



- DETERMINED BY BUILDER AT TIME OF BUILDING
- 2. EXISTING CONTOURS SHOWN ARE DESIGN
- 3. ALL DRAINAGE DESIGN AND CONSTRUCTION ACTIVITIES SHALL COMPLY WITH CHAPTER II, ARTICLE III OF THE SUPERIOR MUNICIPAL

CIVIL RESOURCES, LLO

323 5th STREET P.O. Box 680 FREDERICK, CO 80530 303.833.1416 WWW.CIVILRESOURCES.COM

STC METROPOLITAN DISTRICT #2

141 UNION BLVD., STE 150 LAKEWOOD, CO 80228

	REVISIONS	
NO	. DESCRIPTION	DATI
1	STAFF COMMENTS	05/18/16
2	STAFF COMMENTS	06/01/16
3	STAFF COMMENTS	06/14/16

VESTED RIGHTS

THIS PLAN CONSTITUTES A SITE SPECIFIC DEVELOPMENT PLAN AS DEFINED IN SECTION 24-68-101, ET SEQ., C.R.S., AND CHAPTER 16 OF THE SUPERIOR MUNICIPAL CODE, AVAILABLE AT THE SUPERIOR TOWN HALL, 124 EAST COAL CREEK DRIVE, SUPERIOR, COLORADO.

DESIGNED BY: JAB DATE: 4/1/2016 DRAWN BY: <u>CAI</u> SCALE<u>: 1"=20'</u> CHECKED BY: JAB JOB NO.: 228.001.04


PARTIAL DRAINAGE PLAN 1


DWG NAME:BLK25_OGP.DWG


C3.1


NORTH_

(IN FEET)

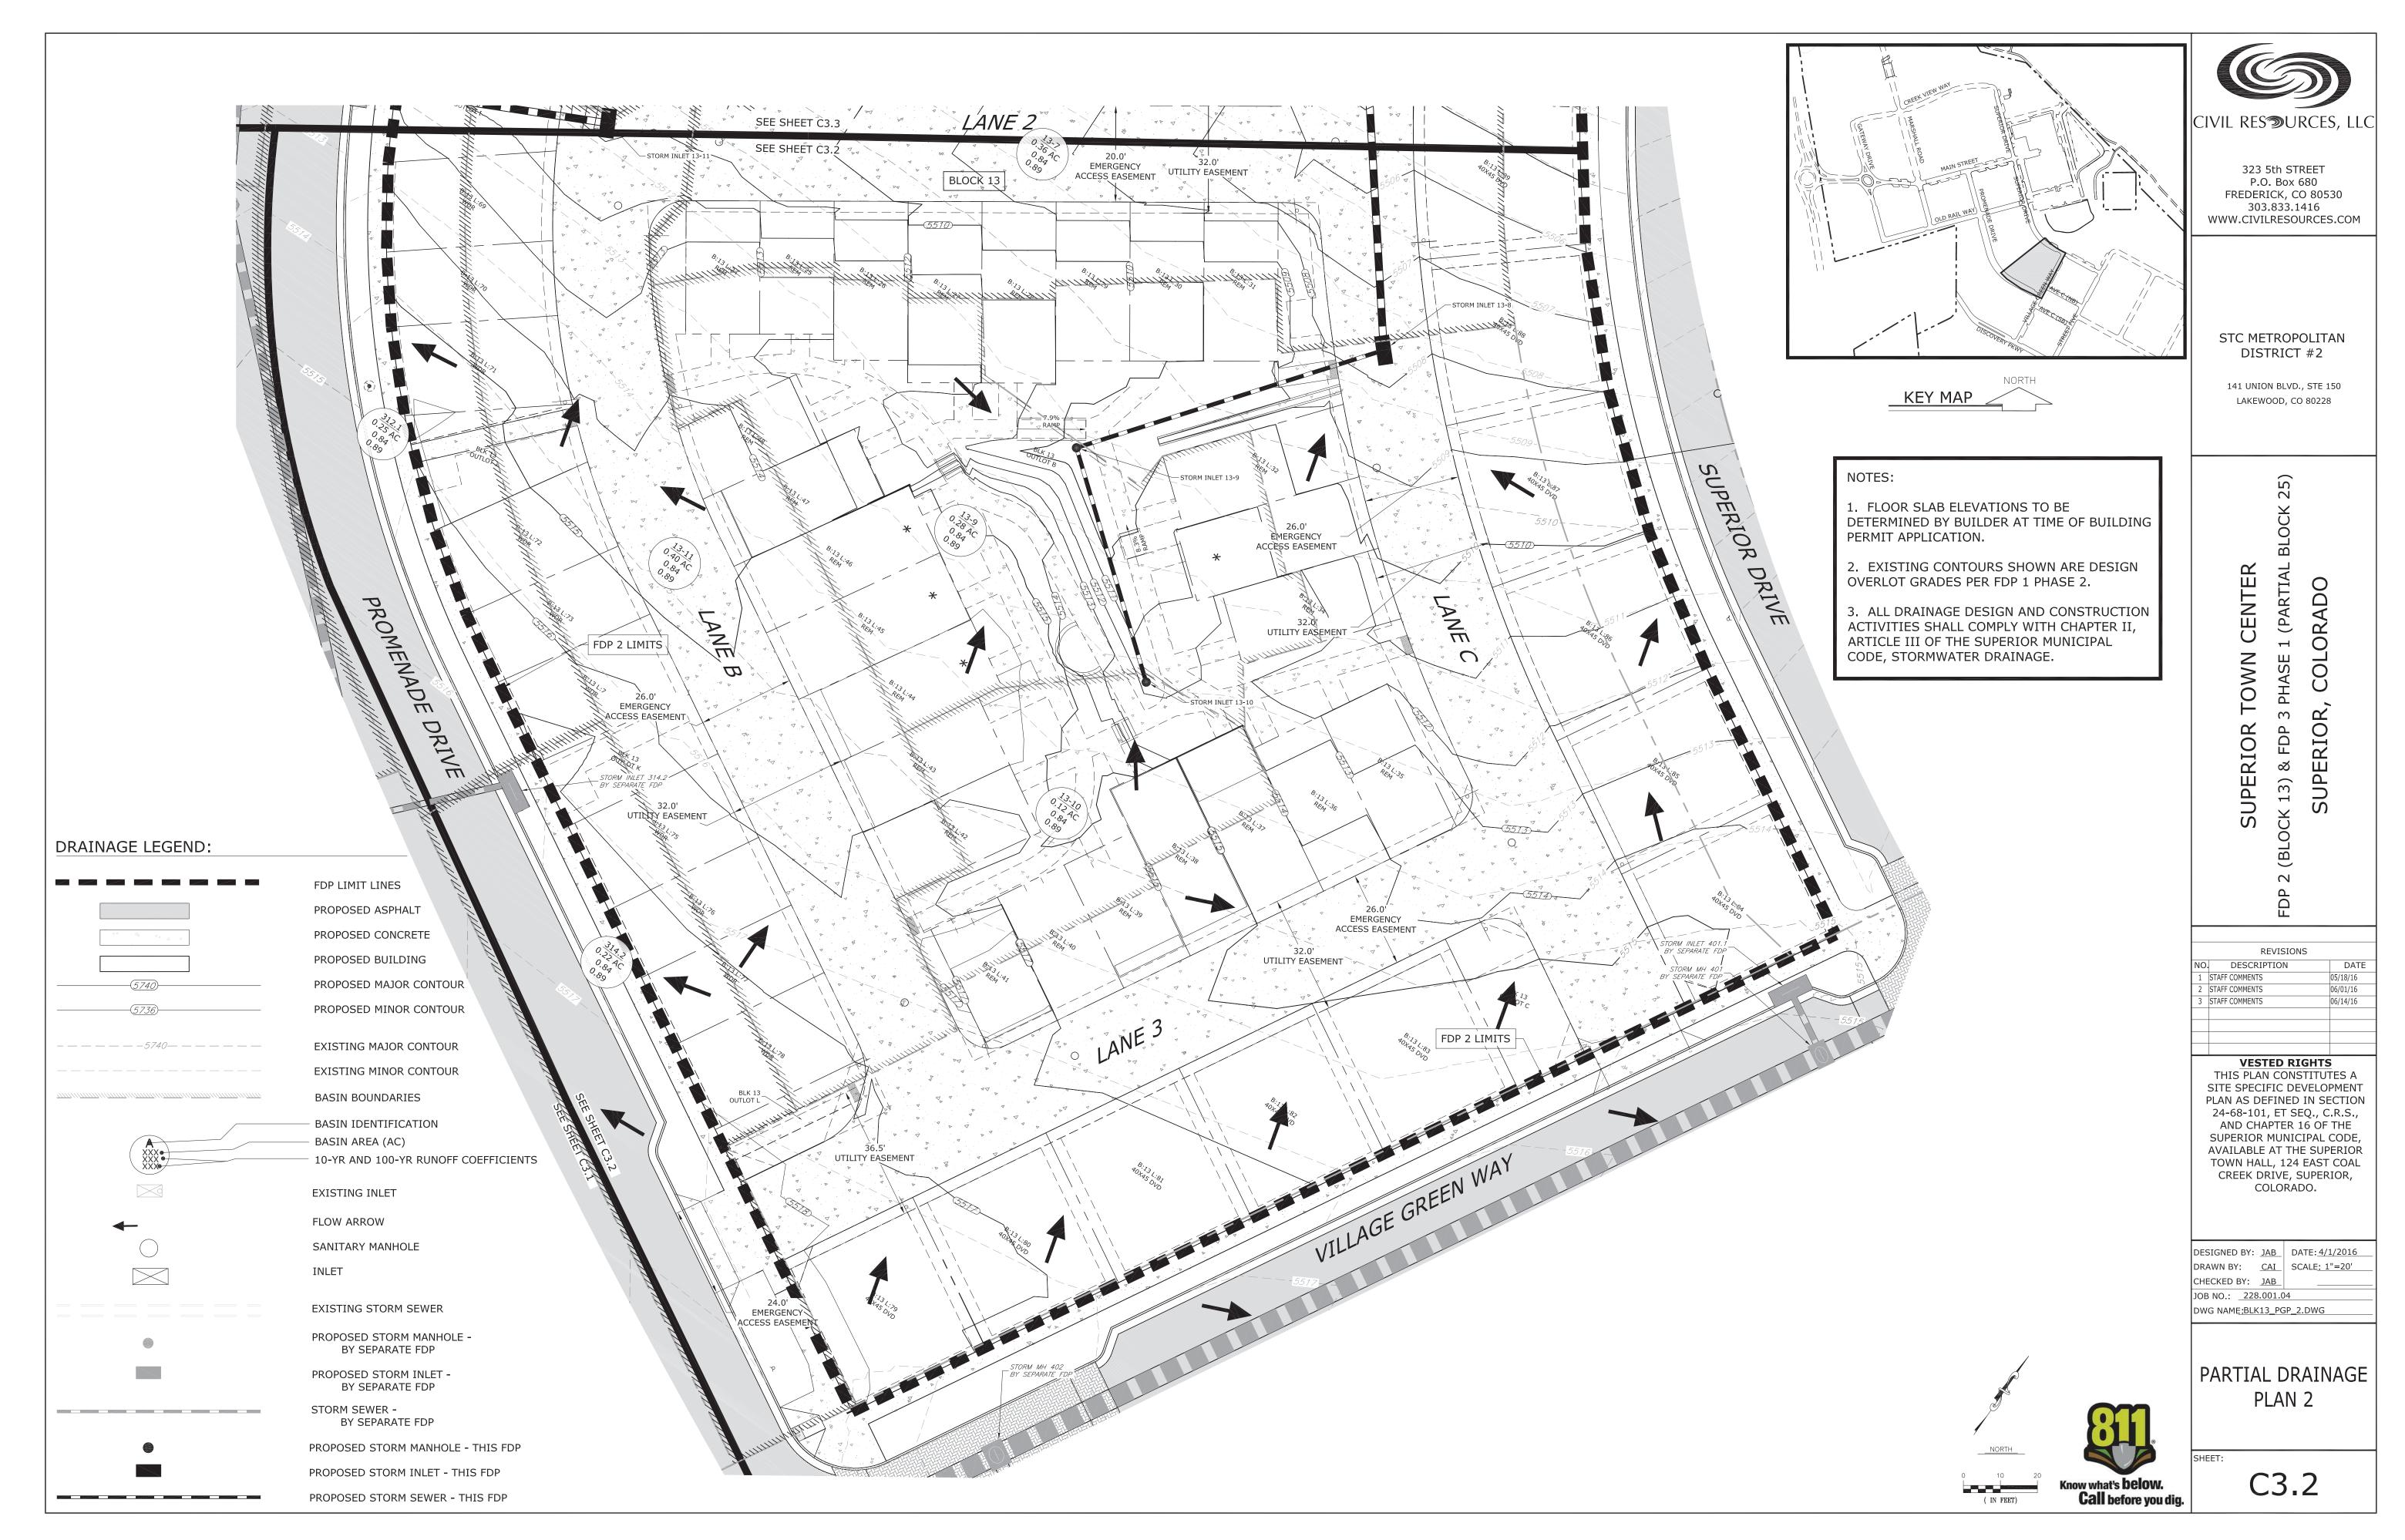

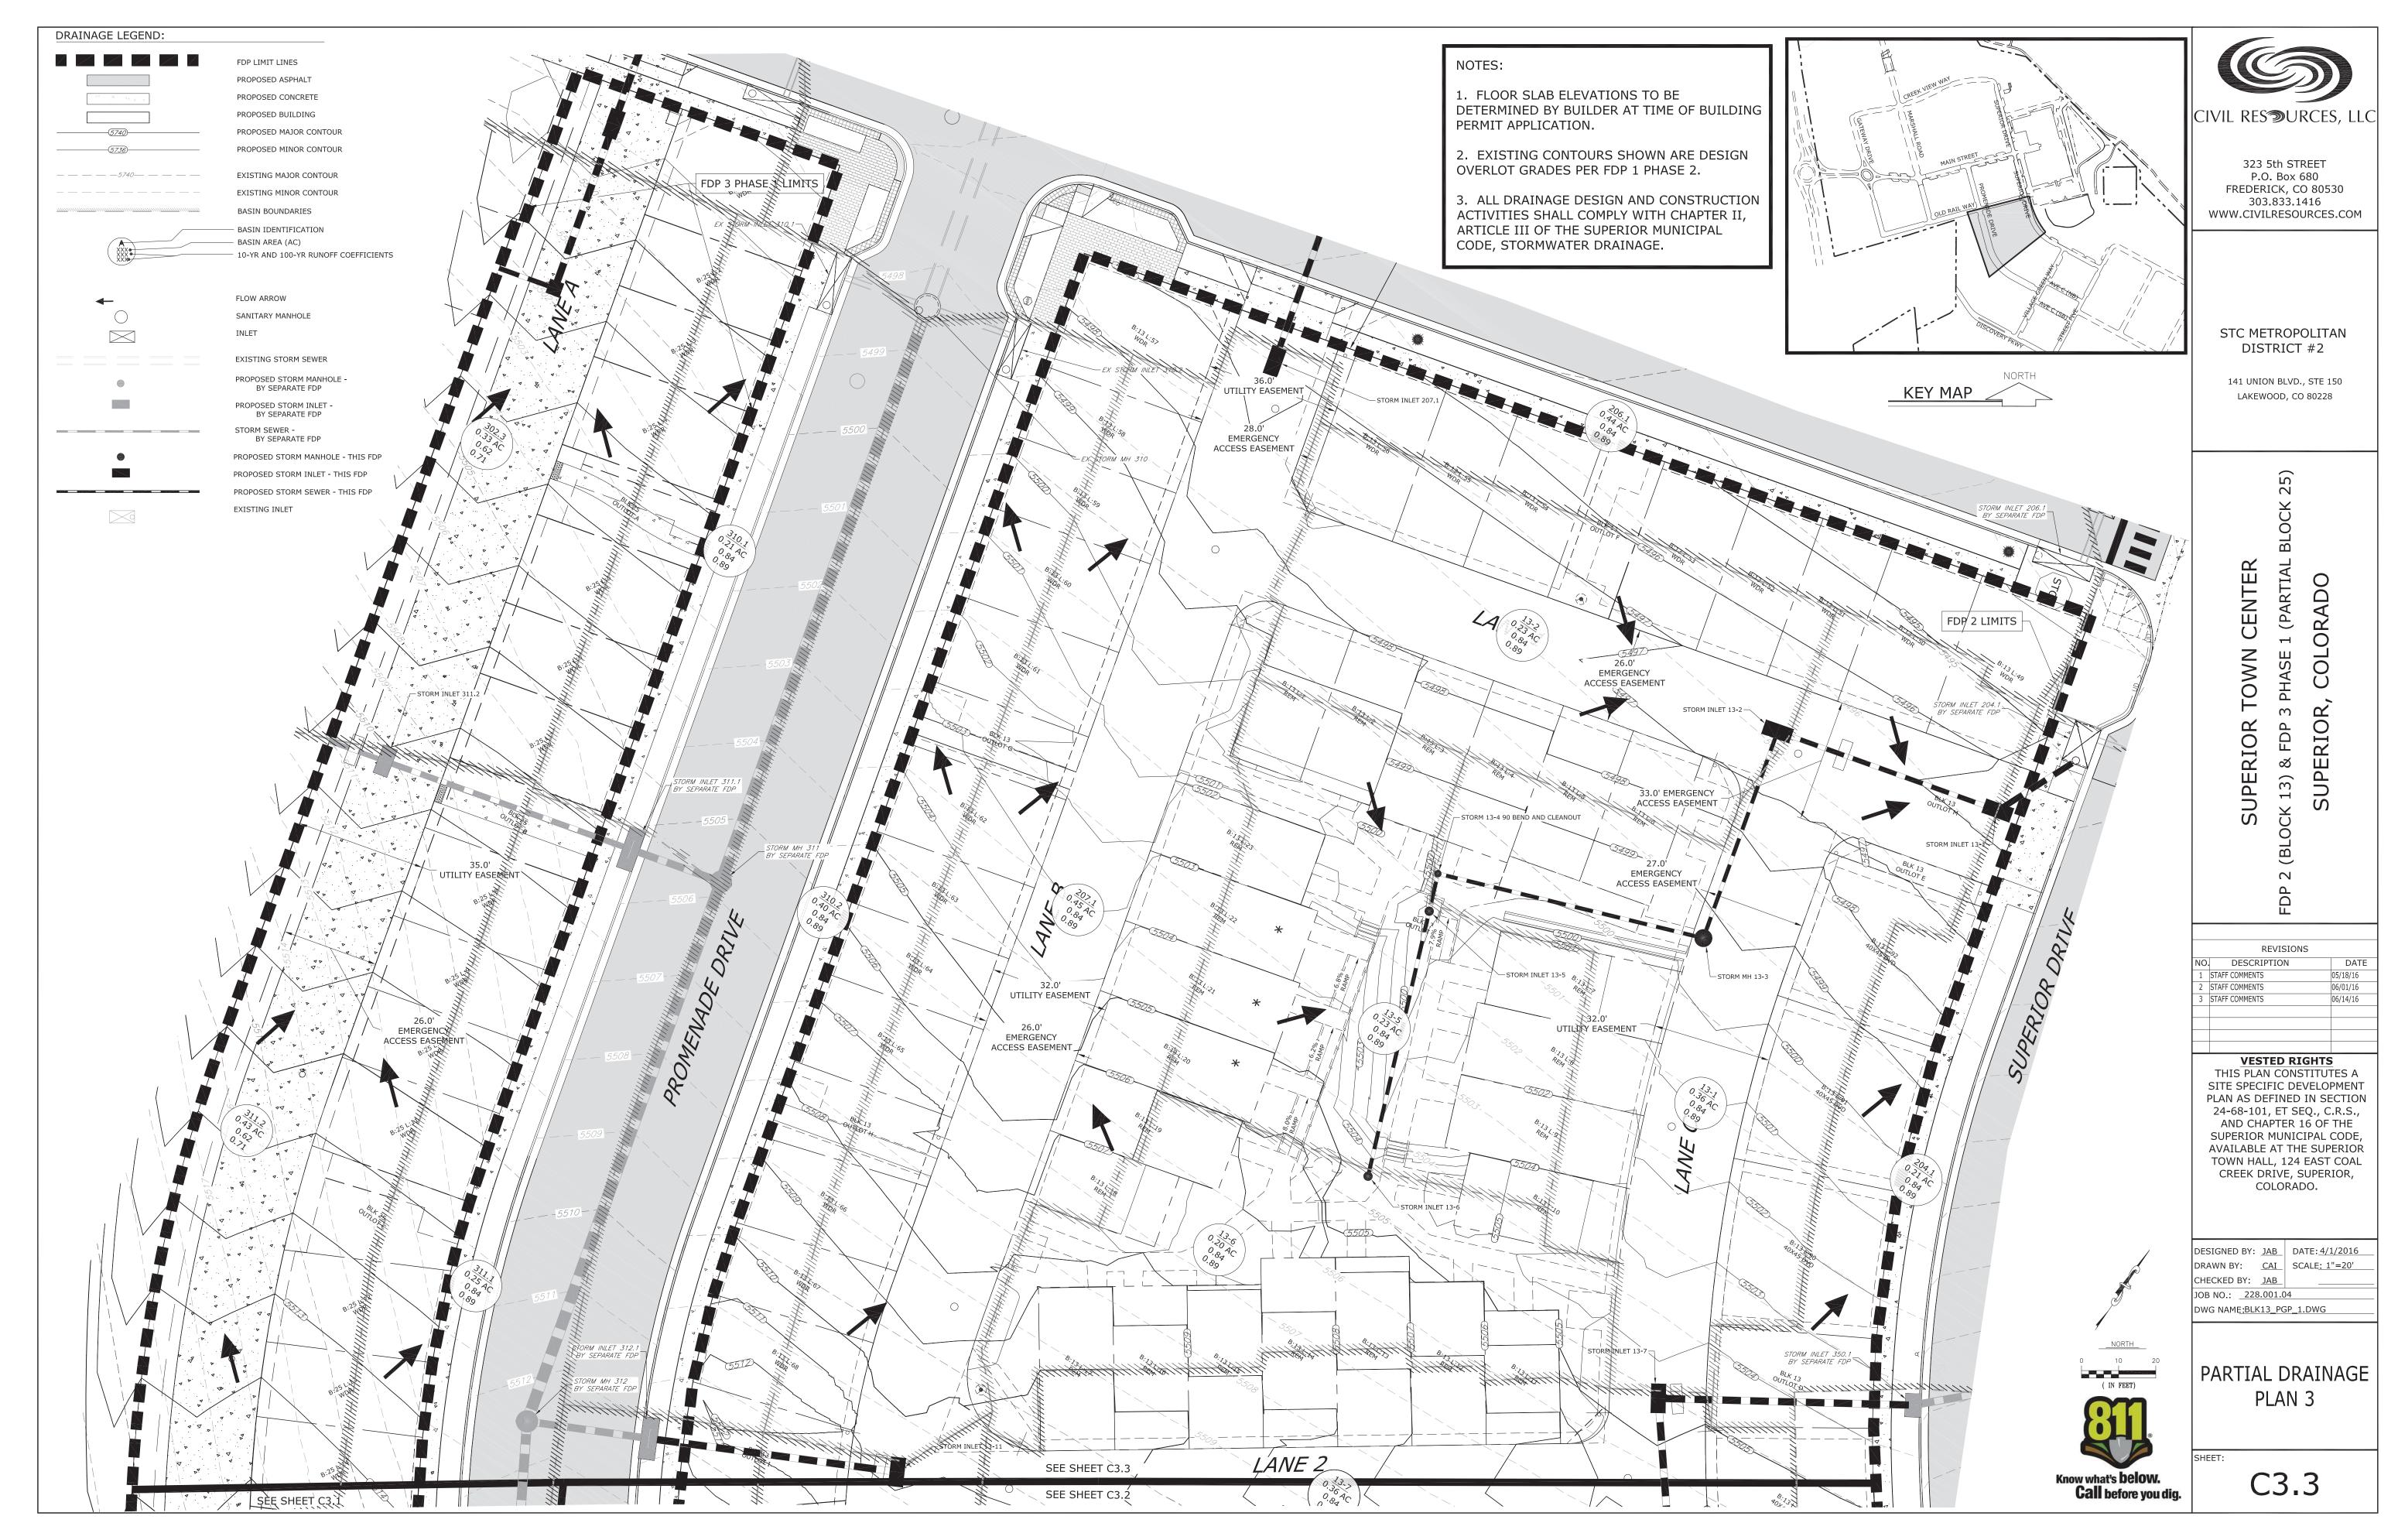

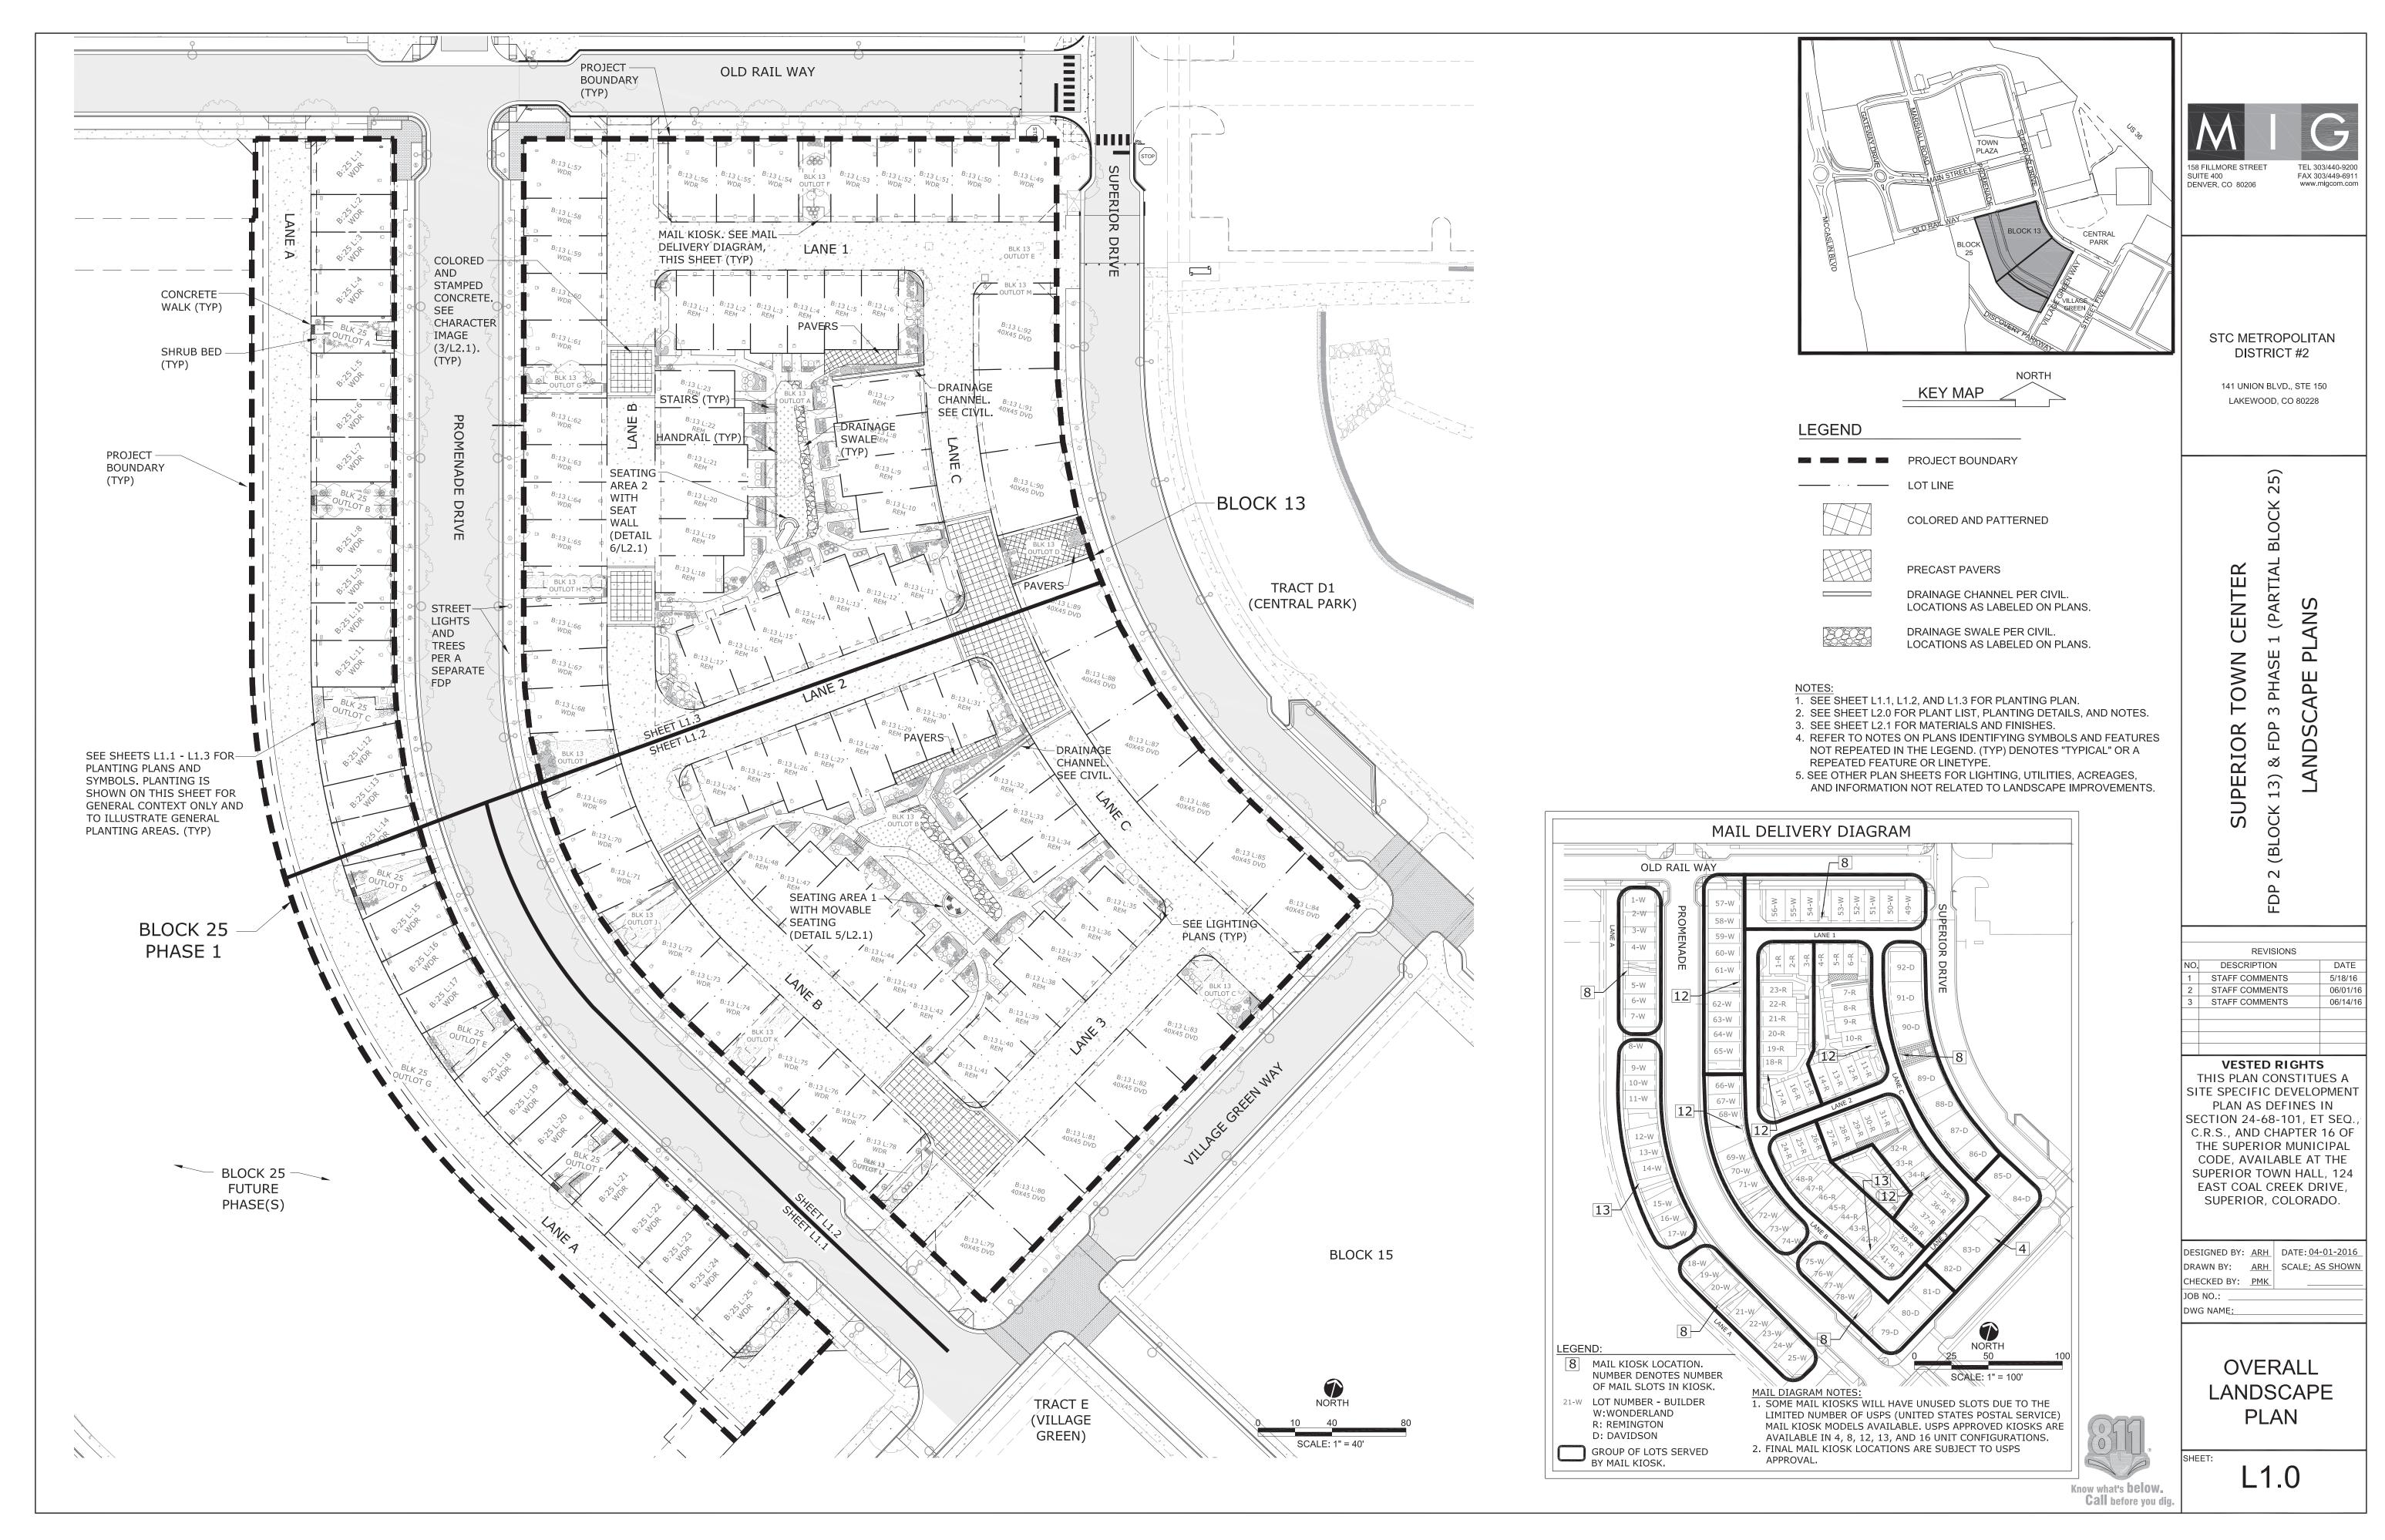

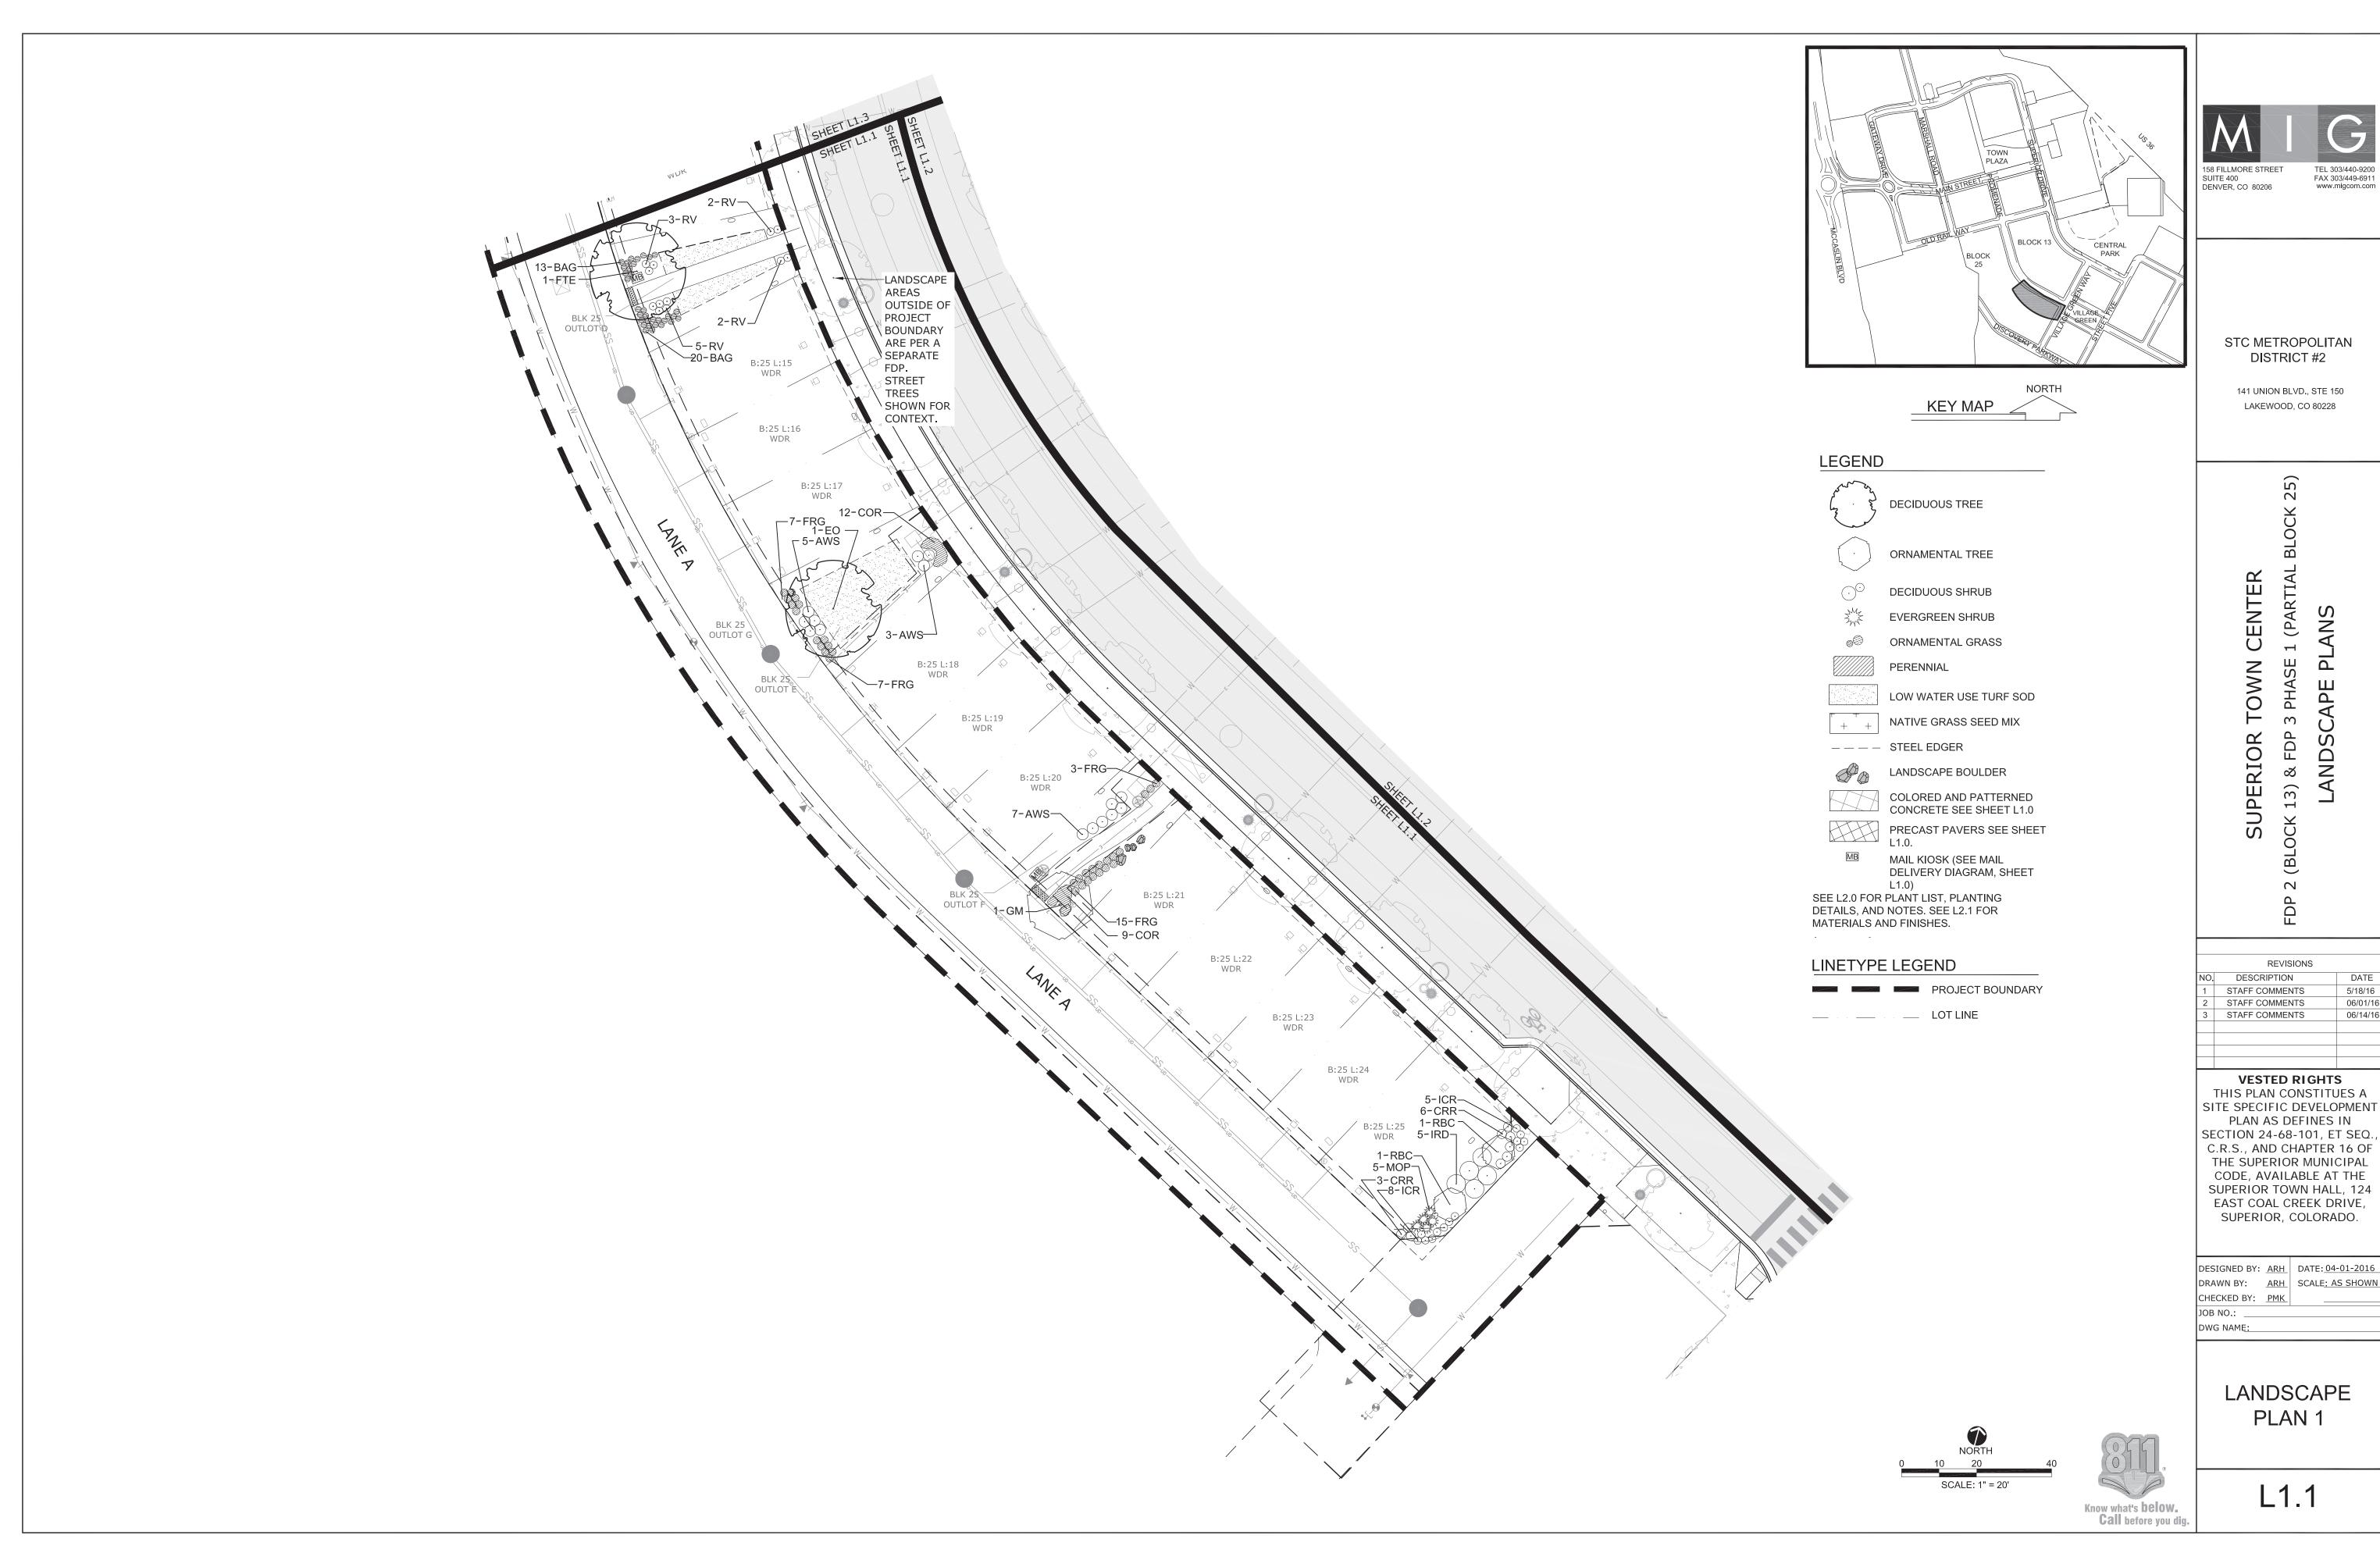



DATE


5/18/16


06/01/16


06/14/16

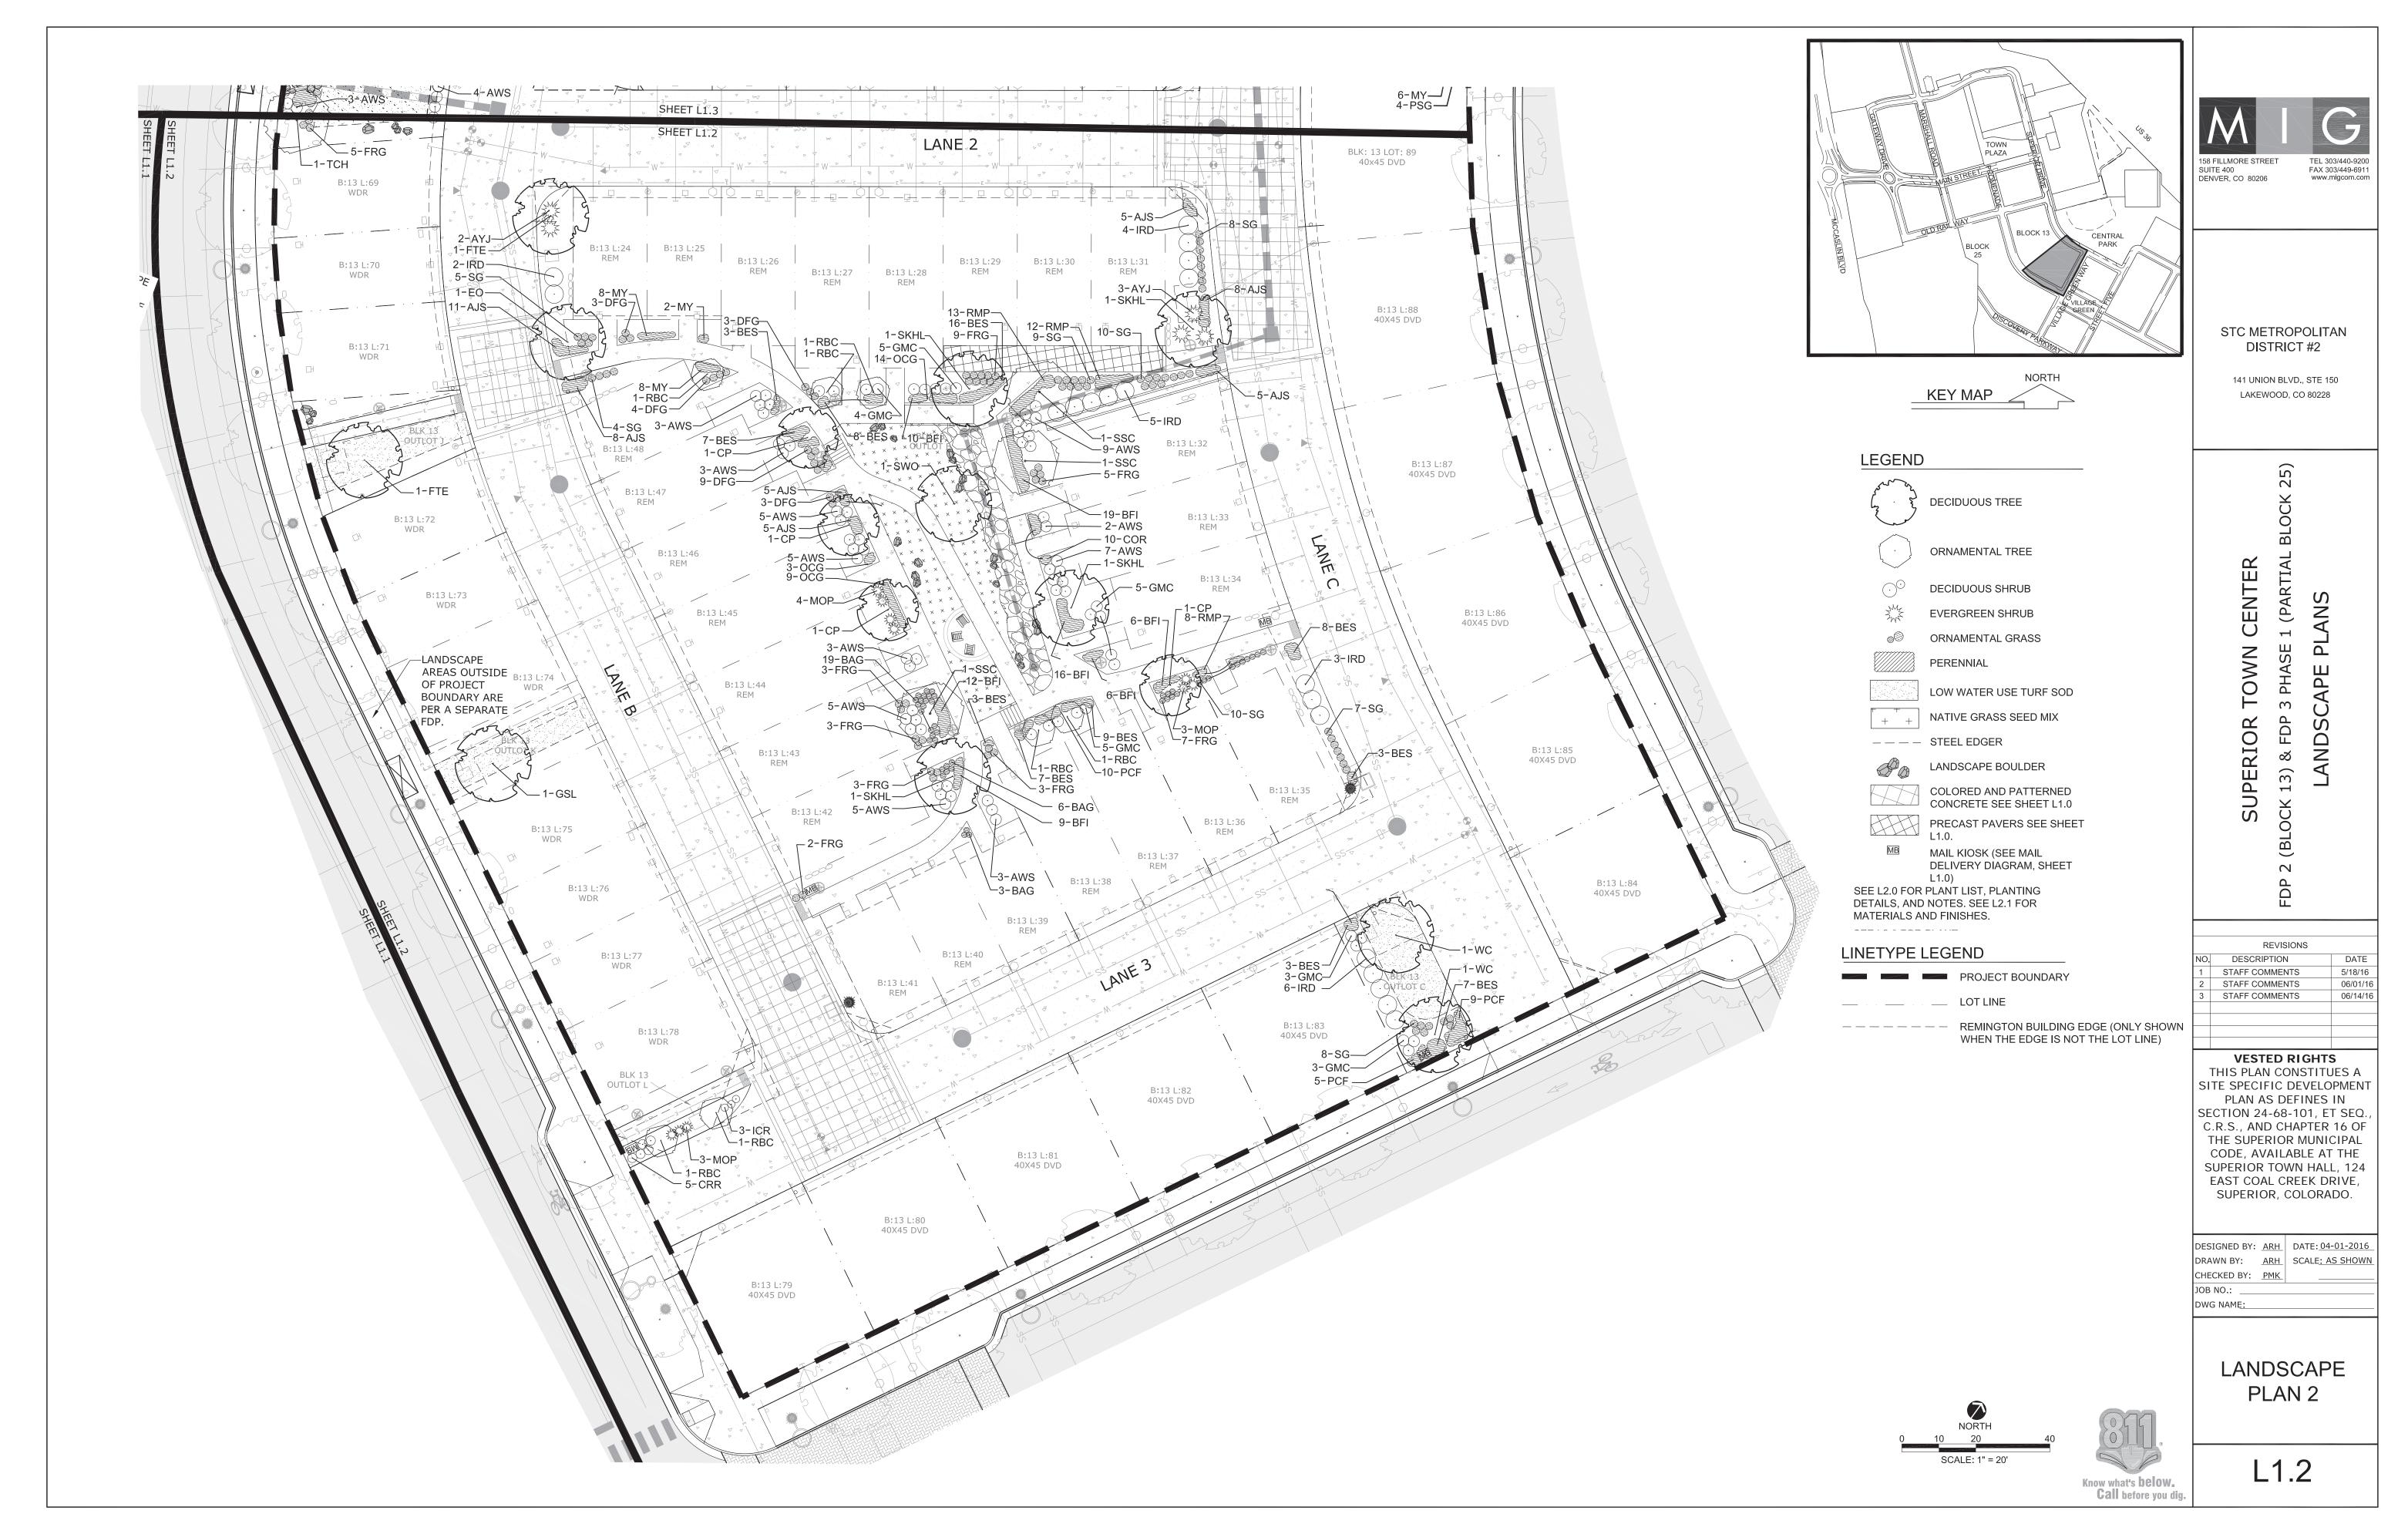

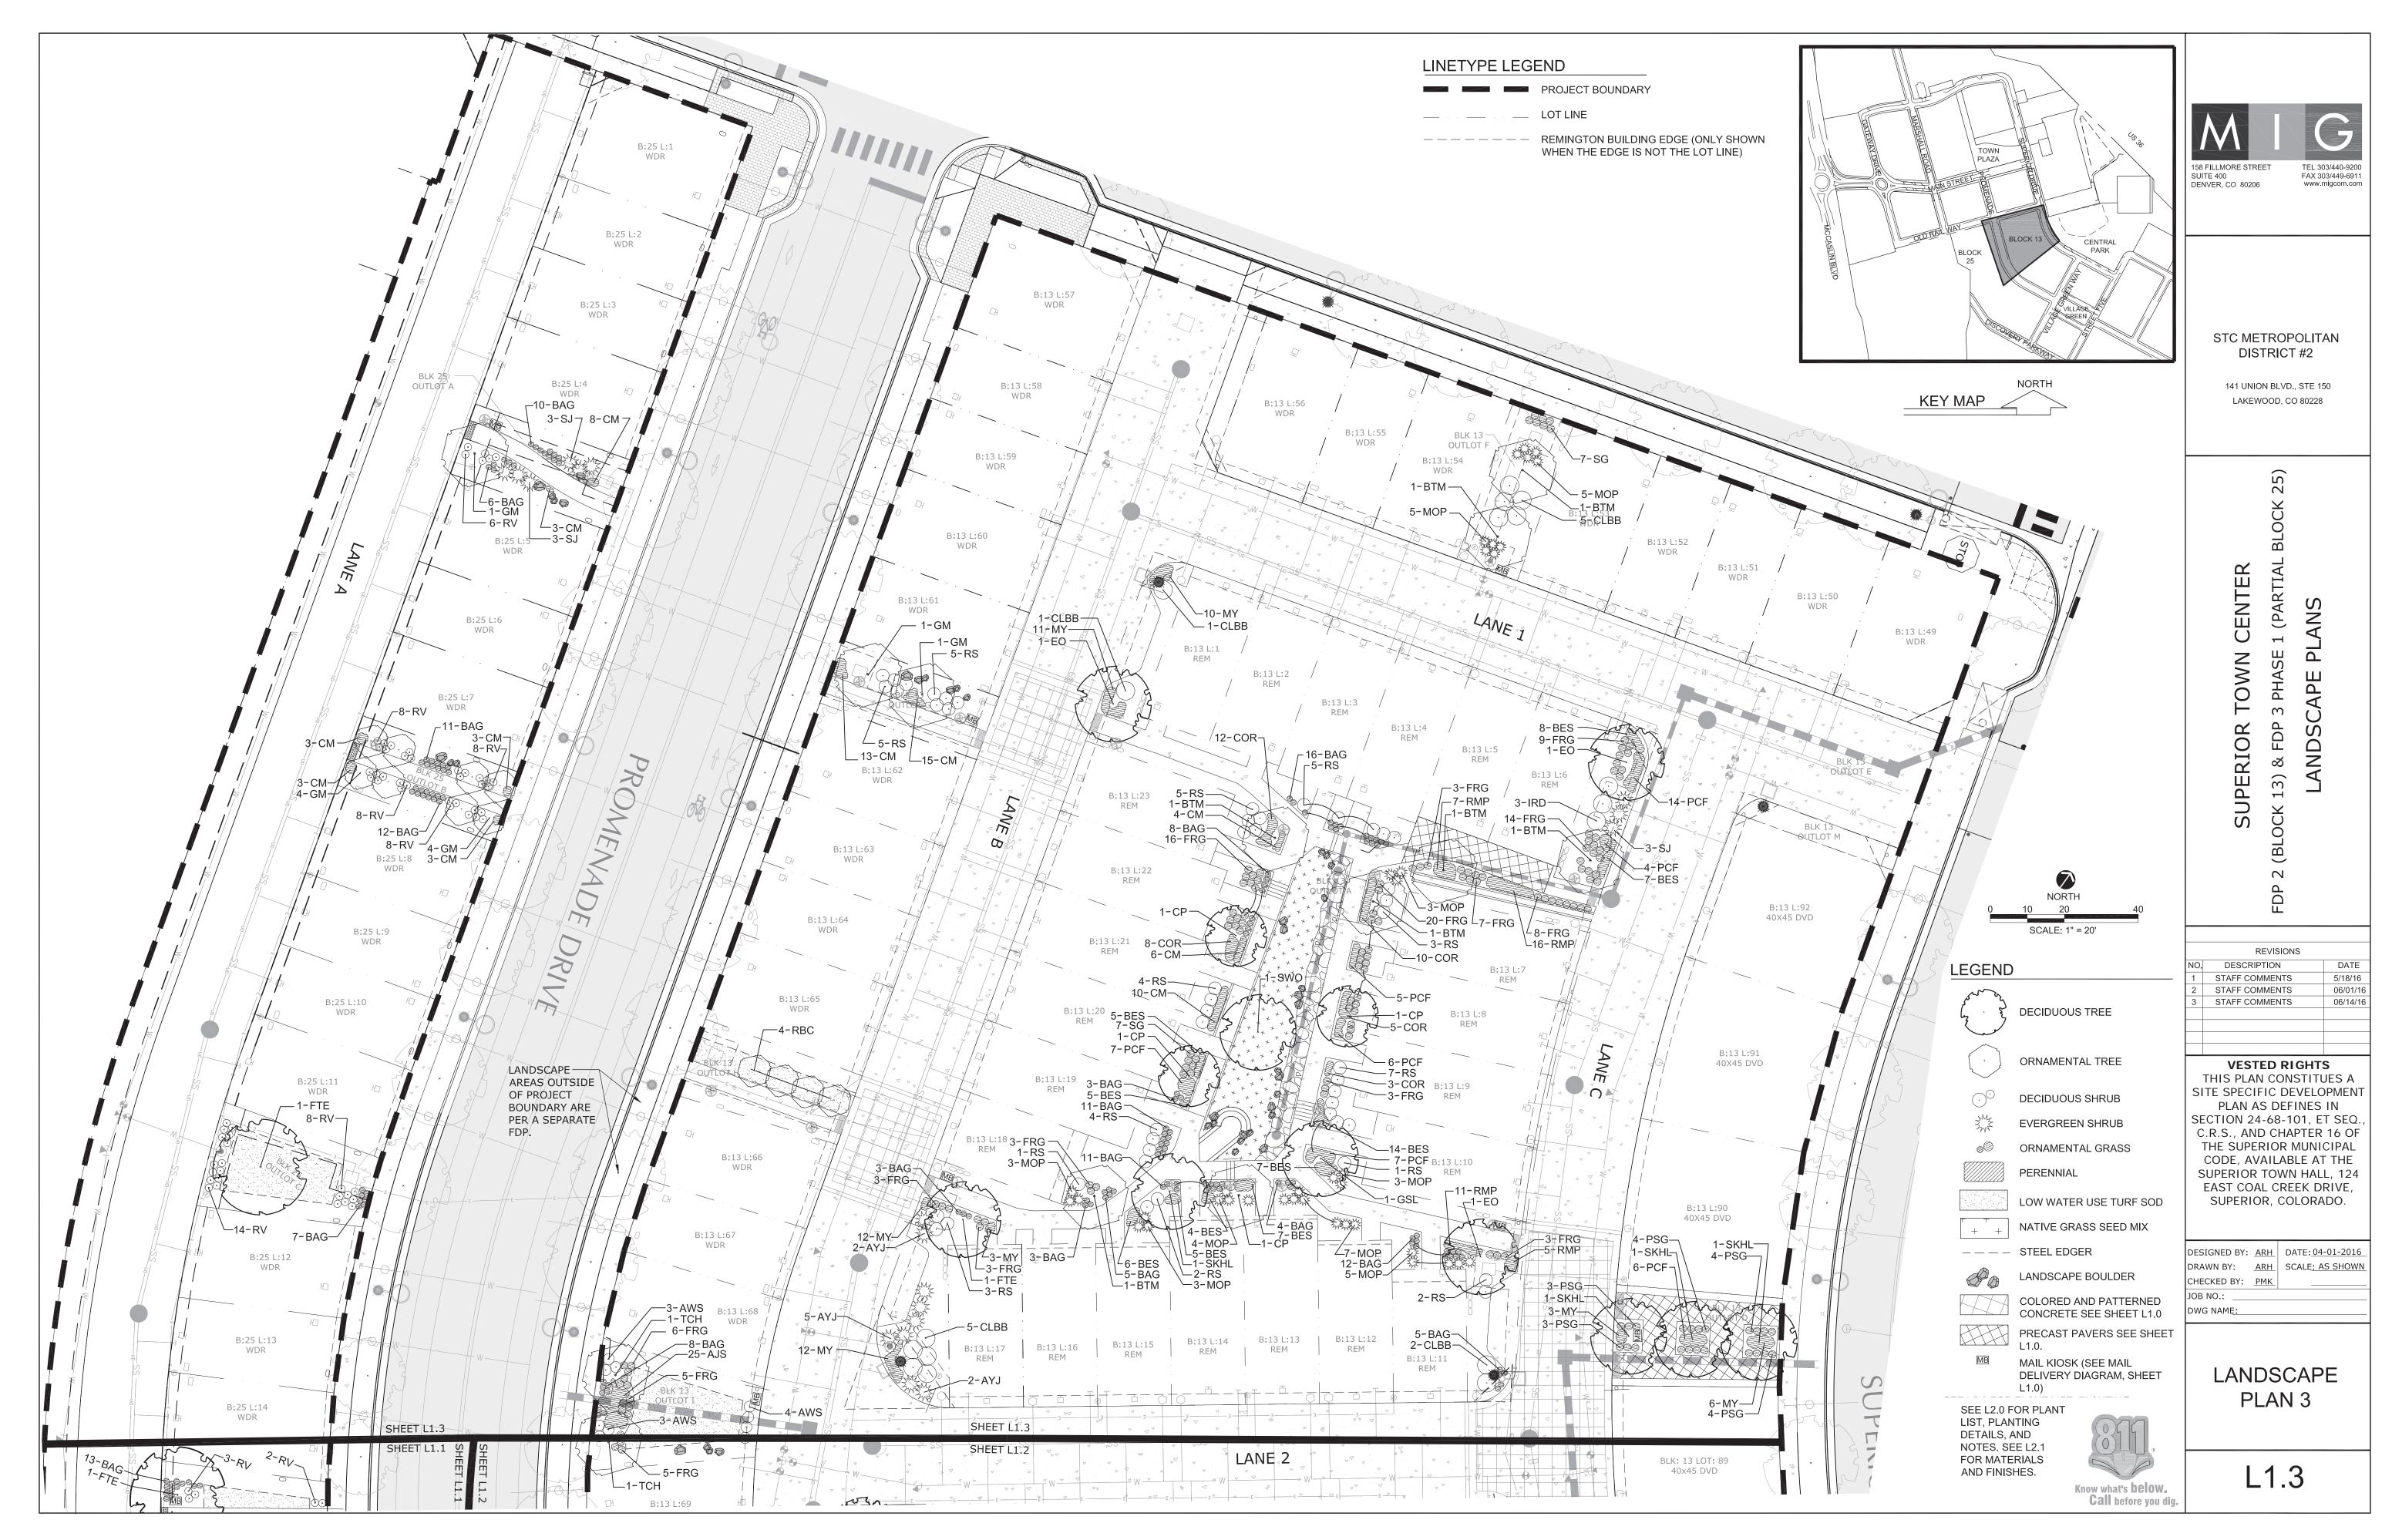


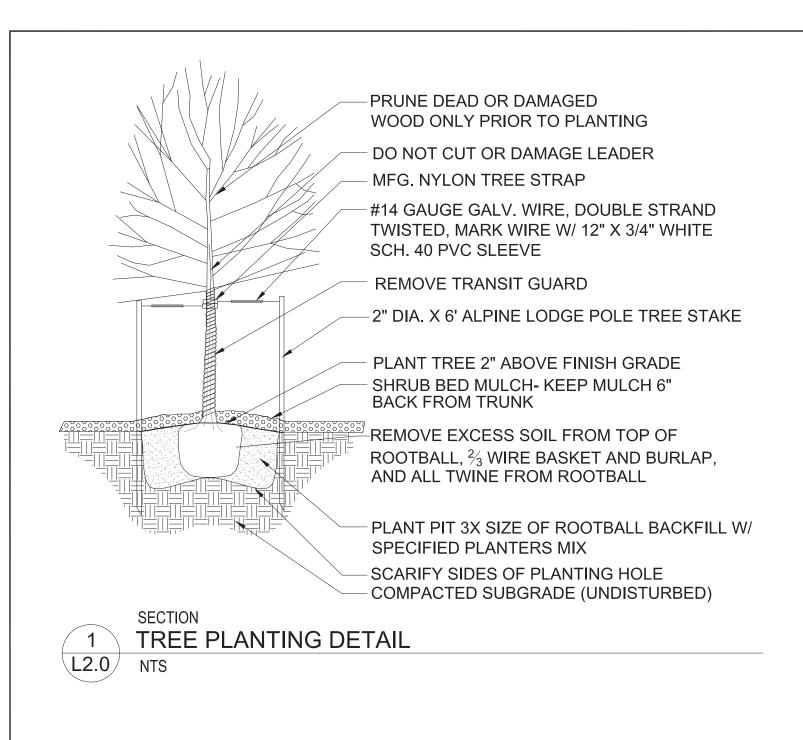

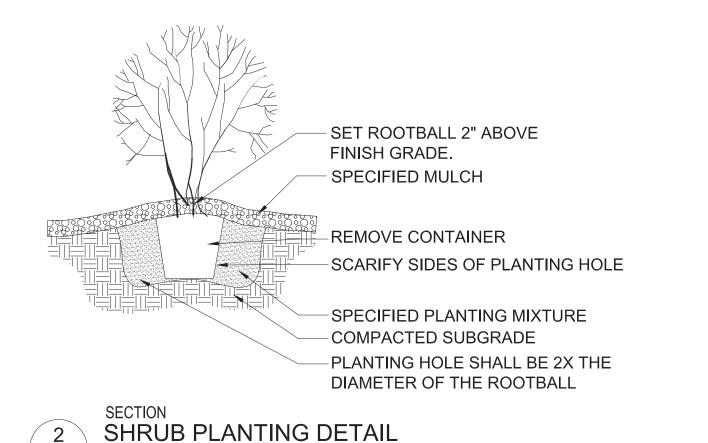

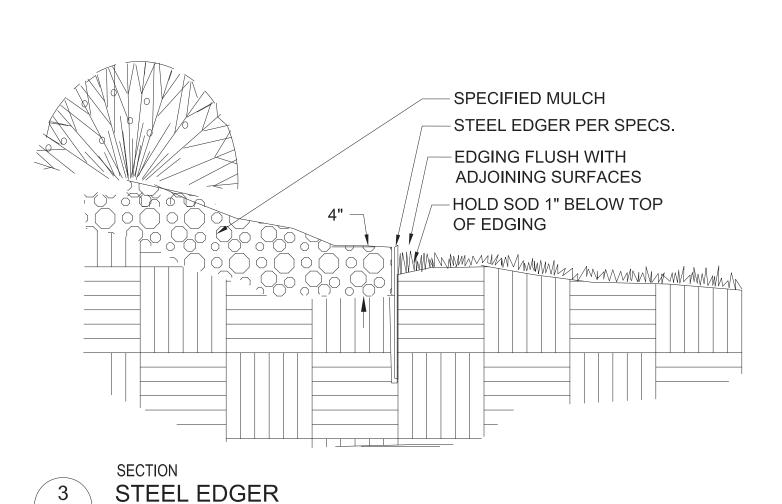

L2.0 NTS

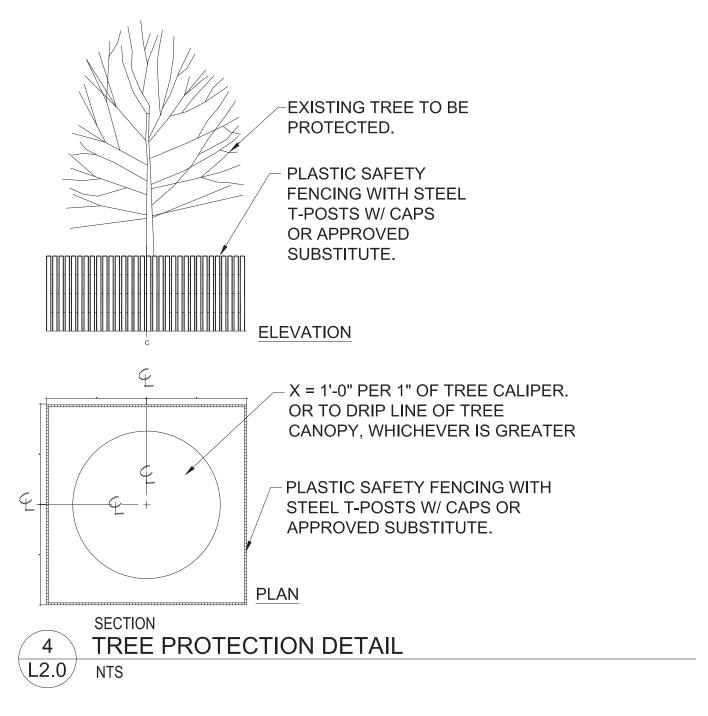

NOTES	Cumani	or Tours Contan EDD 2 and 2				
TREES PLANTED WITHIN SIGHT TRIANGLES SHALL NOT BRANCH	Plant L	or Town Center FDP 2 and 3	Total	l Traca	= CO Total	Chruba - 205
HORIZONTALLY BELOW A 6' HEIGHT. SHRUBS WITHIN SIGHT TRIANGLES		ous Trees	Iota	irees	= 69 lotal :	Shrubs = 295
SHALL NOT EXCEED 2'-0" IN HEIGHT.			Common Name	04	Consisso	Total = 32
2. ALL SHRUB BEDS ARE TO BE MULCHED TO A 3" MIN. DEPTH WITH 1" TO	Key CP	Latin Name Pyrus calleryana Chanticleer	Common Name Chanticleer Pear	Qty 8	Spacing As Shown	Size 2.5" Cal.
1-1/2" DIA. ROCK MULCH IN TANS, BROWNS, WHITES, AND GRAYS. ROCK		Quercus robur		10000		
MULCH IS TO BE PLACED OVER WEED CONTROL FABRIC.	EO	(1)	English Oak	5	As Shown	2.5" Cal.
3. ALL SHRUB BEDS SHALL BE SEPARATED FROM TURF AREAS BY 3/16" X	FTE	Ulmus x 'Frontier'	Frontier Elm	5	As Shown	2.5" Cal.
4" X 16' STEEL EDGING.	GSL	Tilia cordata 'Greenspire'	Greenspire Linden	2	As Shown	2.5" Cal.
4. LOCATION OF PLANT MATERIAL SHALL BE ADJUSTED TO PROVIDE THE	SKHL	Gleditsia triacanthos 'Skyline'	Skyline Honeylocust	8	As Shown	2.5" Cal.
REQUIRED MINIMUM CLEARANCE FROM THE FINAL LOCATION OF ALL	SWO	Quercus bicolor	Swamp White Oak	2	As Shown	2.5" Cal.
BURIED UTILITY LINES.	WC	Catalpa speciosa	Western Catalpa	2	As Shown	2.5" Cal.
5. ALL TREES IN NATIVE GRASS AND TURF AREAS SHALL HAVE A 3'						
DIAMETER, 4" DEEP WOOD MULCH RING AROUND THE BASE OF THE	Charles and the second	ental Trees	Birth ID at Market Of IMale	-	A 01	Total = 37
TREE.	BTM	Acer grandidentatum	Bigtooth 'Rocky Mountain Glow' Maple	7	As Shown	8' Clump
6. NATIVE GRASS SEED MIX TO BE TOWN OF SUPERIOR STANDARD NATIVE	GM	Acer ginnala 'Flame'	Ginnala Maple	12	As Shown	8' Clump
SEED MIX: ROCK CREEK IRRIGATED NATIVE SEED MIX.	RBC	Malus 'Red Barron'	Red Barron Crabapple	13	As Shown	2" Cal.
7. THE LANDSCAPING INDICATED ON THE PLANS WILL BE WATERED BY A	SSC	Malus 'Spring Snow' Crataegus crus-galli var. inermis	Spring Snow Crabapple Thornless Cockspur Hawthorn	3	As Shown As Shown	2" Cal. 2" Cal.
FULLY AUTOMATED, UNDERGROUND SPRINKLER SYSTEM CONSISTING	ICH	Crataegus crus-gam var. mermis	morniess Cockspur Hawthorn		AS SHOWN	Z Cal.
OF A COMBINATION OF ROTORS, POP-UPS, AND LOW WATER USE	Davido	ous Shrubs				Total = 219
EMITTERS (E.G. DRIP EMITTERS, BUBBLERS, STREET TREE RINGS, ETC.). 8. THE WATER SOURCE FOR THE IRRIGATION SYSTEM WILL BE THE TOWN			Common Name	04.	0	
OF SUPERIOR RE-USE LINE.	Key	Latin Name		Qty 75		Size
9. THE IRRIGATION SYSTEM WILL BE CONTROLLED BY PROGRAMMABLE	AWS	Spirea japonica 'Anthony Waterer'	Anthony Waterer Spirea	5,000,000	As Shown	5 Gal.
IRRIGATION SYSTEM WILL BE CONTROLLED BY PROGRAMMABLE IRRIGATION CLOCK WHICH ALLOWS VARIATIONS IN ZONE SEQUENCING	CLBB	Buddleja davidii nanhoensis 'Petite Indigo'	Compact Lavender Butterfly Bush	14	As Shown	5 Gal.
AND TIMING TO MEET THE WATER USE REQUIREMENTS OF EACH AREA	CRR	Rosa Flower Carpet Red	Flower Carpet Red Rose	14	As Shown	5 Gal.
OF THE PLANTING PLAN	GMC	Ribes alpinum 'Green Mound'	Greenmound Alpine Currant	25	As Shown	5 Gal.
10. RAIN SENSORS WHICH AUTOMATICALLY SHUT DOWN THE IRRIGATION	ICR	Rosa x Ivory Carpet	Ivory Carpet Rose	16	As Shown	5 Gal.
SYSTEM DURING PERIODS OF HIGH MOISTURE WILL BE INSTALLED.	IRD	Cornus stolonifera 'Isanti'	Isanti Redtwig Dogwood	28	As Shown	5 Gal.
11. DRIP, SUBSURFACE, BUBBLER, OR LOW VOLUME IRRIGATION	RS	Perovskia artiplicifolia	Russian Sage	47	As Shown	5 Gal.
DISTRIBUTION SYSTEMS WILL BE USED FOR ALL PLANTING STRIPS LESS		_				
THAN 8' WIDE AND ALL PLANTING BEDS INVOLVING TREES, SHRUBS,	U125	een Shrubs	10 %	1200		Total = 76
PERENNIALS AND GROUND COVERS.	Key	Latin Name	Common Name	Qty		Size
	AYJ	Juniperus horizontalis 'Youngstown'	Andorra Youngstown Juniper	14	As Shown	5 Gal.
	MOP	Pinus mugo 'Mops'	Miniature Mugo Pine	53	As Shown	5 Gal.
	SJ	Juniperus sabina 'Scandia'	Scandia Juniper	9	As Shown	5 Gal.

Latin Name

FRG

PSG

BES

BFI

CM

COR

RMP

Helictotrichon sempervirens

Panicum virgatum 'Heavy Metal'

Panicum virgatum 'Prairie Sky'

Rudbeckia fulgida 'Goldsturm

Coreopsis vertichillata 'Moonbeam'

Zauschneria garretti 'Orange Carpet'

Nepeta x 'Walker's Low'

Sedum 'Autumn Joy'

Baptisa australis

Achilea 'Mooshine'

Echinacea purpurea

Penstemon strictus

Centranthus ruber

Pennisetum alopecuroides 'Cassian'

Calamagrostis Acutiflora 'Karl Foerster'

LANDSCAPE DENSIT	ı⊏5 (Per#	PD-A-201	3-1 and Pi	DA #2)	
	Single-	own Center Family I Required	Superior Town Center Multi-Family Residential Required		
Landscape Area	Trees	Shrubs	Trees	Shrubs	
Open Space Landscape Requirements (Developed Landscape)	1/1150 s.f.	1/100 s.f.	1/1150 s.f.	1/100 s.f.	
Open Space Landscape Requirements (Naturalized Landscape)	1/4000 s.f.	1/500 s.f.	1/4000 s.f.	1/500 s.f.	
(Naturalized Landscape) Foundation Planting				(See No	

Common Name

Blue Avena Grass

Feather Reed Grass

Autumn Joy Sedum

Black-Eyed Susan

Walker's Low Catmint

Moonbeam Coreopsis

Creeping Hummingbird Trumpet

Rocky Mountain Penstemon

Moonshine Yarrow

Purple Coneflower

Red Valerian

Blue False Indigo

Prairie Sky Switchgrass

Cassian Dwarf Fountain Grass

Heavy Metal Blue Switchgrass

Note 1 Foundation Plantings and Landscape Buffers: Where lots in the Superior Town center are developed to the property line (zero lot line), foundation plantings and landscape buffers between uses will typically not apply.

Note 2 Superior Town Center (STC) Landscaping: STC landscaping shall be per Article XXI, Section 16-21-10 of the Municipal Code except where noted in #PD-A-2013-1 and PDA #2.

THIS CHART IS FOR PLANTING INFORMATIONAL PURPOSES ONLY. SEE OTHER SITE PLAN SHEETS FOR SITE INFORMATION AND REQUIREMENTS (INCLUDING ACREAGES).

Block 13		Block 25 Phase 1		
Required	Provided	Required	Provided	
	33,149 SF		6,098 SF	
	19,463 SF		5,660 SF	
75% Min. (14,597 SF)	15,800 SF	4,245 SF	5,225 SF	
28	54	5	15	
NA	NA	NA	NA	
331	*242	61	*53	
	26 Tree Surplus = 364 Shrubs		10 Tree Surplus = 140 Shrubs	
331 Shrubs	606 Shrubs	61 Shrubs	193 Shrubs	
33.30%	27%	33.30%	21%	
	Required 75% Min. (14,597 SF) 28 NA 331 331 Shrubs	Required Provided 33,149 SF 19,463 SF 19,463 SF 75% Min. (14,597 SF) 15,800 SF 28 54 NA NA 331 *242 Surplus = 364 Shrubs 606 Shrubs	Required Provided Required 33,149 SF 19,463 SF 75% Min. (14,597 SF) 15,800 SF 4,245 SF 28 54 5 NA NA NA 331 *242 61 Surplus = 364 Shrubs 331 Shrubs 606 Shrubs 61 Shrubs	

*Ornamental grasses and perennials not included. See plant list for total quantities.



Size

5 Gal.

5 Gal.

5 Gal.

5 Gal.

5 Gal.

1 Gal.

Qty Spacing

196 As Shown

22 As Shown

175 As Shown

18 As Shown

75 As Shown

72 As Shown

142 As Shown

78 As Shown

71 As Shown

69 As Shown

75 As Shown

26 As Shown

73 As Shown

72 As Shown

72 As Shown

STC METROPOLITAN DISTRICT #2

> 141 UNION BLVD., STE 150 LAKEWOOD, CO 80228

ಶ

REVISIONS DESCRIPTION DATE 5/18/16 STAFF COMMENTS STAFF COMMENTS 06/01/16 STAFF COMMENTS 06/14/16

> **VESTED RIGHTS** THIS PLAN CONSTITUES A SITE SPECIFIC DEVELOPMENT

PLAN AS DEFINES IN SECTION 24-68-101, ET SEQ. C.R.S., AND CHAPTER 16 OF THE SUPERIOR MUNICIPAL CODE, AVAILABLE AT THE SUPERIOR TOWN HALL, 124 EAST COAL CREEK DRIVE, SUPERIOR, COLORADO.

DESIGNED BY: ARH DATE: 04-01-2016 DRAWN BY: ARH SCALE: AS SHOWN CHECKED BY: PMK JOB NO.:

DWG NAME:

PLANT LIST AND NOTES

L2.0

Know what's **below**. Call before you dig





DRAINAGE SWALE CHARACTER IMAGE



CONCRETE STAMP: Majestic Ashlar Slate by Concrete Equipment Direct (or approved equal) https://www.concreteequipmentdirect.com/

COLOR: DAVIS COLORS "ADOBE" (or similar samples to be provided and approved) www.daviscolors.com/

PADIO™ 14 PAVING SYSTEM (or approved equal) COLOR: GRAPHITE http://anchorblock.com/


"For a sophisticated look, choose the RINN™ Padio™ 14 paving system - comprising 4 pieces with the same width (14cm) and varying lengths, reminiscent of plank styling.

FEATURES:

80mm 4-piece system consists of two large rectangles (5.5" x 23" and 5.5" x 18.5"), medium rectangle (5.5" x 13"), small rectangle (5.5" x 9") Rinn™ paving systems offer rich, long-lasting

colors and iconic European styling Ideal for patios, pathways, walkways and driveways

Suitable for residential and light commercial

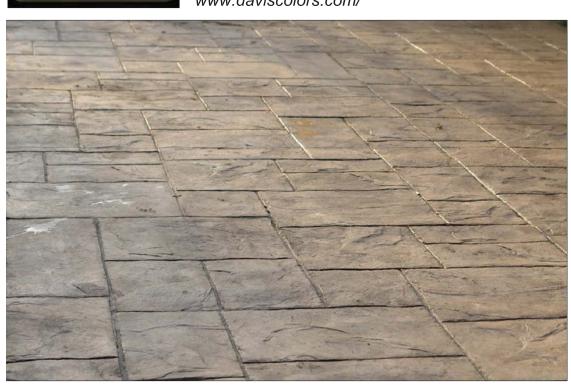


COLORED AND STAMPED CONCRETE L2.1 (STREET)



PRECAST PAVERS - CHARACTER IMAGE

L2.1 SELECTED "PATIO" AREAS (SEE PLANS)

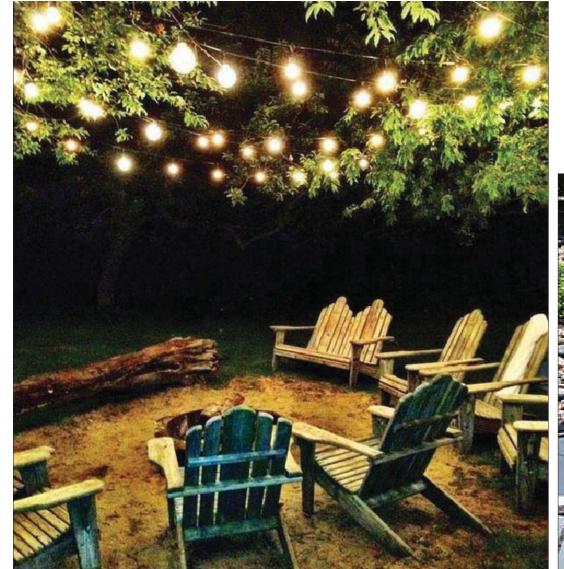



L2.1

"CAPE COD" BY FROG **FURNISHINGS** (or approved equal) COLORS TO BE SELECTED FROM REDS, BLUES, GREENS, AND BROWNS. SEATING AREA MAY CONTAIN MULTIPLE COLORS. COLOR SAMPLES TO BE PROVIDED BY MANUFACTURER FOR FINAL SELECTION. http://www.frogfurnishings.com/#!pr prd4/2029828125/cape-cod

Materials: Recycled Plastic (UV stabilized) with Stainless Steel hardware





CONCRETE SEATWALL CHARACTER IMAGES - SEATING AREA 2 L2.1 DETAILS TO BE DEVELOPED/APPROVED AT TIME OF CONSTRUCTION DRAWINGS

L2.1

1 L2.1

ROCK MULCH

MOVABLE FURNITURE CHRACTER IMAGERY - SEATING AREA 1

Know what's **below. Call** before you dig.

STC METROPOLITAN DISTRICT #2

141 UNION BLVD., STE 150

LAKEWOOD, CO 80228

REVISIONS DESCRIPTION STAFF COMMENTS 5/18/16 STAFF COMMENTS 06/01/16 STAFF COMMENTS 06/14/16


> **VESTED RIGHTS** THIS PLAN CONSTITUES A SITE SPECIFIC DEVELOPMENT PLAN AS DEFINES IN SECTION 24-68-101, ET SEQ. C.R.S., AND CHAPTER 16 OF THE SUPERIOR MUNICIPAL CODE, AVAILABLE AT THE SUPERIOR TOWN HALL, 124 EAST COAL CREEK DRIVE, SUPERIOR, COLORADO.

DESIGNED BY: ARH DATE: 04-01-2016 DRAWN BY: ARH SCALE: AS SHOWN CHECKED BY: PMK

DWG NAME:

LANDSCAPE MATERIALS, FINISHES, AND CHARACTER **IMAGERY**

L2.1

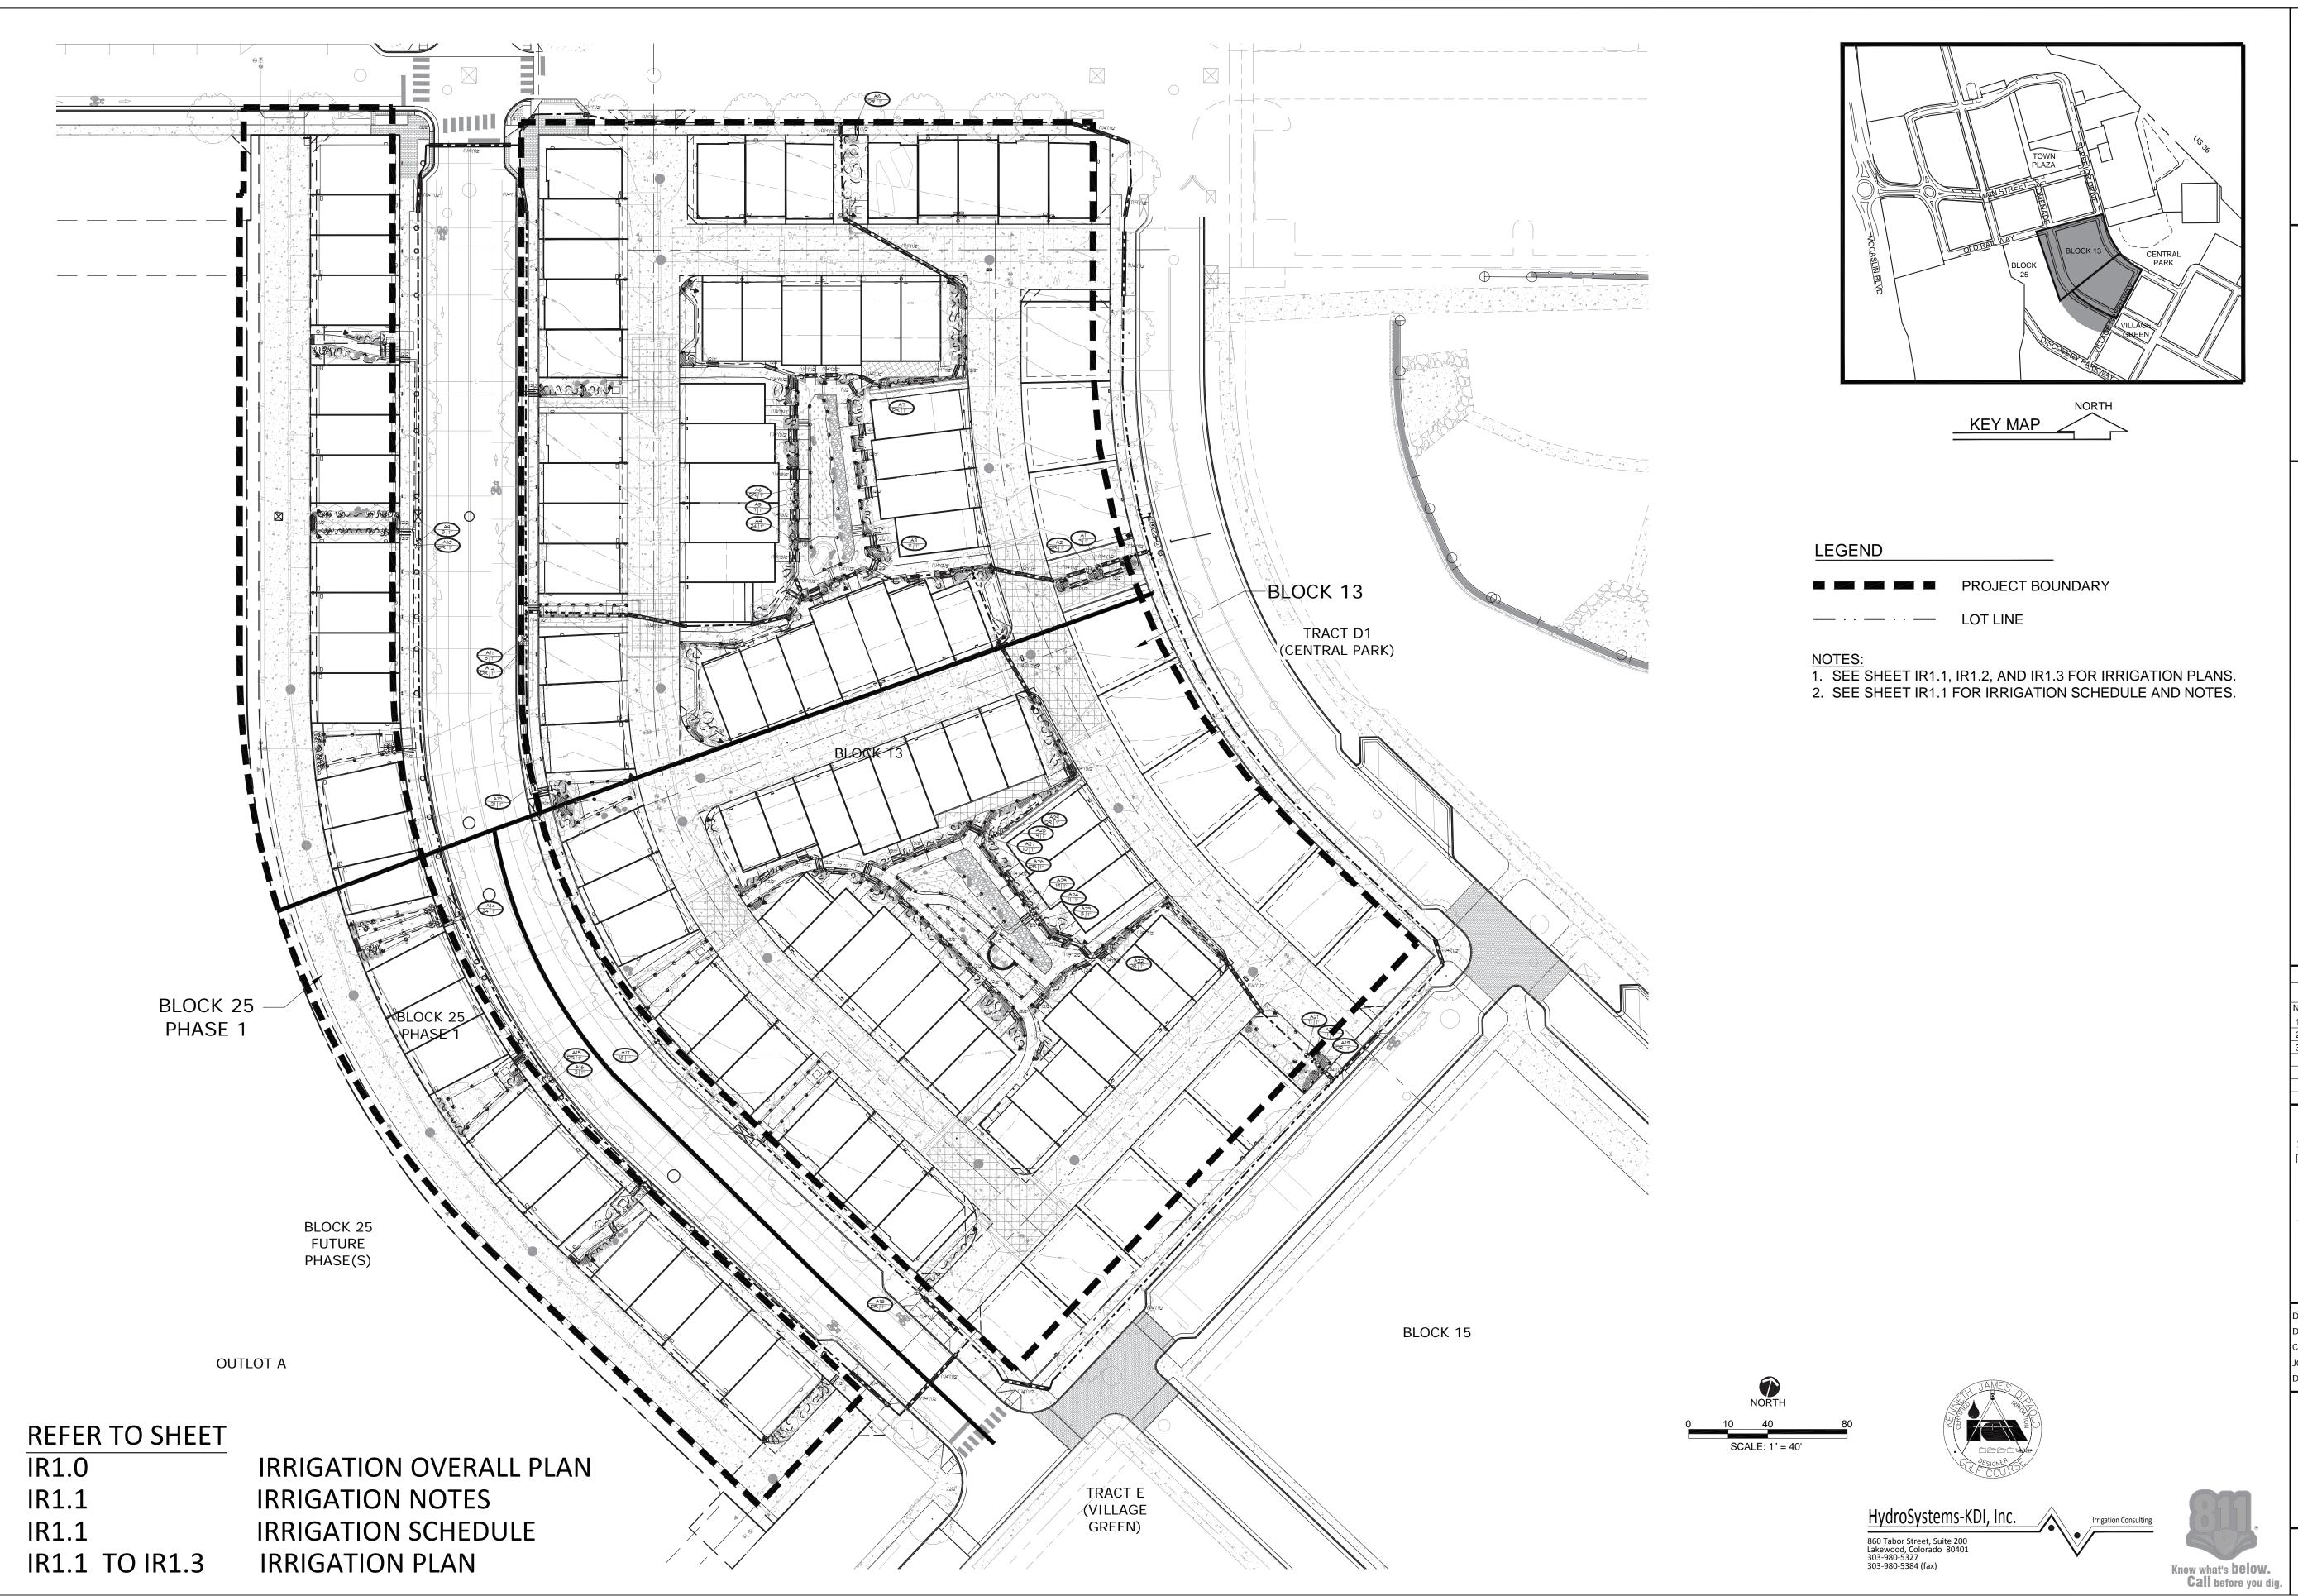

STC METROPOLITAN DISTRICT #2

141 UNION BLVD., STE 150

LAKEWOOD, CO 80228

	REVISIONS	
NO.	DESCRIPTION	DATE
1	STAFF COMMENTS	5/18/16
2	STAFF COMMENTS -#2	6/01/16
3	STAFF COMMENTS -#3	6/14/16

VESTED RIGHTSTHIS PLAN CONSTITUES A SITE SPECIFIC DEVELOPMENT PLAN AS DEFINES IN SECTION 24-68-101, ET SEQ., C.R.S., AND CHAPTER 16 OF THE SUPERIOR MUNICIPAL CODE AVAILABLE AT THE SUPERIOR TOWN HALL, 124 EAST COAL CREEK DRIVE, SUPERIOR, COLORADO.

DESIGNED BY: KJD DATE: 04-08-2016 DRAWN BY: <u>KJD</u> SCALE<u>: AS SHOWN</u> CHECKED BY: <u>JSB</u>

DWG NAME<u>:</u>

OVERALL IRRIGATION PLAN

IR1.0

IRRIGATION DEVELOPMENT DESIGN NOTES

- 1. THE IRRIGATION SYSTEM SHALL BE DESIGNED TO PROVIDE PEAK SEASON IRRIGATION WITHIN AN SIX NIGHT, SIX HOUR PER NIGHT WATERING PERIOD
- 2. THE MAINLINE SYSTEM WILL BE DESIGNED SUCH THAT VELOCITIES WITHIN THE MAINLINE PIPING DO NOT EXCEED FIVE FEET PER SECOND.
- 3. THE MAXIMUM FLOW RATE REQUIRED FOR THE SITE IS 20 GPM. THE STATIC PRESSURE AVAILABLE AT THE SITE IS (TBD) PSI.
- 4. IRRIGATION DESIGN APPROACH
- 4.1. TURF AREAS
- 4.1.1. SMALL AREAS (25 FEET WIDE OR LESS) SHALL BE IRRIGATED WITH FIXED NOZZLE POP-UP SPRAY HEADS WITH MATCHED PRECIPITATION NOZZLES. NOZZLES SHALL BE SIZES TO PROVIDE HEAD TO HEAD COVERAGE.
- 4.1.2. LARGE TURF AREAS (WIDER THAN 25 FEET) SHALL BE IRRIGATED WITH GEAR DRIVEN ROTOR HEADS WITH A MINIMUM PRECIPITATION RATE OF .45" PER HOUR FOR A FULL CIRCLE HEAD
- 4.2. SHRUB BED AREAS BED AREAS WITH PLANT MATERIAL ONE GALLON IN SIZE OR LARGER SHALL BE DRIP IRRIGATED.
- 4.3. PERENNIAL AND ANNUAL BED AREAS PERENNIAL AND ANNUAL BED AREAS SHALL BE SPRAY IRRIGATED WITH 12" POP-UP SPRAY HEADS WITH A MAXIMUM SPACING OF 10' O.C. OR IN AREAS ARE LESS THAN 10 FT. WIDE SHALL BE IRRIGATED WITH SUBSURFACE IRRIGATION
- 4.4. SUBSURFACE IRRIGATION WHERE REQUIRED BY LOCAL CODES, SUBSURFACE IRRIGATION SHALL BE INSTALLED IN SHRUB BEDS AND/OR NATIVE AREAS LESS THAN 10 FT. WIDE. TURF SHALL ONLY BE LOCATED IN AREAS GREATER THAN 10 FT. WIDE.
- 5. WEB-BASED CONTROL NOTE WEATHERMATIC SMARTLINK WEB-BASED CONTROL SYSTEM WITH FLOW MONITORING AND REPORTING MODEL (PER SCHEDULE). INSTALL PER MANUFACTURER'S RECOMMENDATIONS. CONTACT STEVE WURST AT WEATHERMATIC (303) 653-1587 FOR PRICING. CONTACT JOHN KEESEN AT HYDROSYSTEMS*KDI (303) 980-5327 FOR CONTROLLER AND FLOW SENSOR START-UP AND INITIALIZATION. WATER MANAGEMENT SUBSCRIPTION IS INCLUDED IN THE COST OF THE CONTROLLER FOR A 1 YEAR PERIOD AND WILL BE MANAGED ON BEHALF OF THE OWNER BY HYDROSYSTEMS*KDI. COORDINATION BETWEEN HYDROSYSTEMS*KDI AND THE LANDSCAPE MAINTENANCE COMPANY WILL BE REQUIRED FOR A PERIOD OF ONE YEAR, AT MINIMUM
- 6. THE IRRIGATION INFORMATION SHOWN ON THESE PLANS IS CONCEPTUAL.

		IRRIGATION SCHE	DULE	
SYMBOL	MANUFACTURER	MODEL NO.	DESCRIPTION	DETAIL NO.
00 00	HUNTER	PROS-06-CV-PRS30-R W/ MPR NOZ.	POPUP SPRAY HEAD	
L R S	HUNTER	PROS-06-CV-PRS30-R W/ MPR SST, CORNER NOZ.	POPUP SPRAY HEAD	
◆ ■ ◆ ■	HUNTER	PROS-12-CV-PRS30-R WITH MPR NOZZLE	HI-POP SPRAY HEAD	
	HUNTER	PROS-12-CV-PRS30-R WITH MPR SST, CORNER NOZZLE	HI-POP SPRAY HEAD	
•	HUNTER	ICV SERIES W/ DECODER	ELECTRIC CONTROL VALVE	
▼	HUNTER	HQ-44-LRC	QUICK COUPLING VALVE	
(A)	MEATHERMATIC	SL9600 2-WIRE SERIES, #[QUOTE NUMBER] WITH (SLPED-ENC/SLMMSS) & SMARTLINK AIRCARD WITH FLOW	ELECTRIC CONTROLLER	
R	MEATHERMATIC	SLM5 -MIRELESS	MEATHER STATION DEVICE	
N/5	MATCO	201X	MANUAL DRAIN VALVE	
M		LINE SIZE - 21/2" AND SMALLER	GATE VALVE	
	FEBCO	825YA	RP BACKFLOW PREVENTER	
N/5	GUARDSHACK	<i>G</i> 5-1	BACKFLOW PREVENTER ENCLOSURE	
FS	MEATHERMATIC	SLFSI-T10 (1")	FLOW SENSOR	
•	HUNTER	ICV SERIES	MASTER CONTROL VALVE	
		CLASS 200 BE - 21/2" \$ SMALLER	PVC MAINLINE -PURPLE	
		CLASS 200 BE	PVC LATERAL -PURPLE	
		CLASS 160	PVC SLEEVING	
//	TORO	BLUE STRIPE -PURPLE	POLY DRIP TUBING -3/4" MIN. MIDTH	
\oplus	HUNTER	ICZ-101-40 W/DECODER	DRIP VALVE ASSEMBLY	
▶			DRIP LINE BLOW-OUT STUB	
N/5	RAIN BIRD	XERI-BUG	DRIP EMITTERS	
	NETAFIM	TLRM6-12 ROMS SPACED 12"-PURPLE	SUBSURFACE DRIPLINE	
		PURPLE CLASS 200 BE	SUBSURFACE HEADER PIPE - 1" PVC	
\bigoplus	NETAFIM	LVCZS80-10075 W/DECODER	SUBSURFACE VALVE ASSEMBLY	
▶			SUBSURFACE LINE BLOW-OUT STUB	
-	GPM B		CONTROLLER & STATION NO. CONTROL VALVE SIZE	

