PEDESTRIAN AND TRAIL IMPROVEMENTS

SUPERIOR, CO

OLSSON PROJECT NUMBER 021-00854



**VICINITY MAP** 

## MILE HIGH FLOOD DISTRICT


MILE HIGH FLOOD DISTRICT

DATE LAURA KROEGER, P.E., EXECUTIVE DIRECTOR

KURT BAUER, P.E., WATERSHED MANAGER, STREAM SERVICES DATE

#### TOWN OF SUPERIOR

CALL UTILITY NOTIFICATION CENTER OF COLORADO

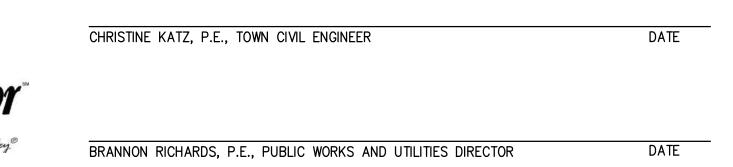

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#### PREPARED BY:

1525 Raleigh Street Suite 400 Denver, CO 80204 TEL 303.237.2072 FAX 303.237.2659




CHANCE UHRICH, P.E. 48947, PROJECT ENGINEER

DATE

100% DESIGN NOT TO BE USED FOR CONSTRUCTION

November 20, 2023 DATE PRINTED OLSSON

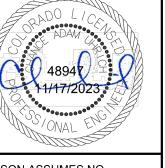

UTILITY LOCATIONS (HORIZONTAL OR VERTICAL). VERIFY THE LOCATION OF ALL COMMENCEMENT OF ANY CONSTRUCTION ACTIVITIES.

REV. NO	DATE	REVISIONS DESCRIPTION
1	2023.11.16	2023.11.16 TOWN ALLEY IMPROVEMENTS PLAN
		DEVICIONS

MCCASLIN BLVD 2ND AVENUE TO N FINAL DESIGN

QA/QC by: project no.:

drawing no.: <u>W TTL.DWG</u>
date: <u>11.15.2023</u>

SHEET of 23

CALL 3-BUSINESS DAYS IN ADVANCE BEFORE YOU DIG, GRADE, OR EXCAVATE FOR THE MARKING OF UNDERGROUND MEMBER UTILITIES.


NOTE: ALL CONSTRUCTION SHALL

BE IN ACCORDANCE WITH TOWN OF SUPERIOR DESIGN STANDARDS

AND SPECIFICATIONS.

# Survey Control Sheet

Part of Sections 19 & 24, Township 1 South, Range 70 West of the 6th Principal Meridian Located in the City of Superior, County of Boulder, State of Colorado

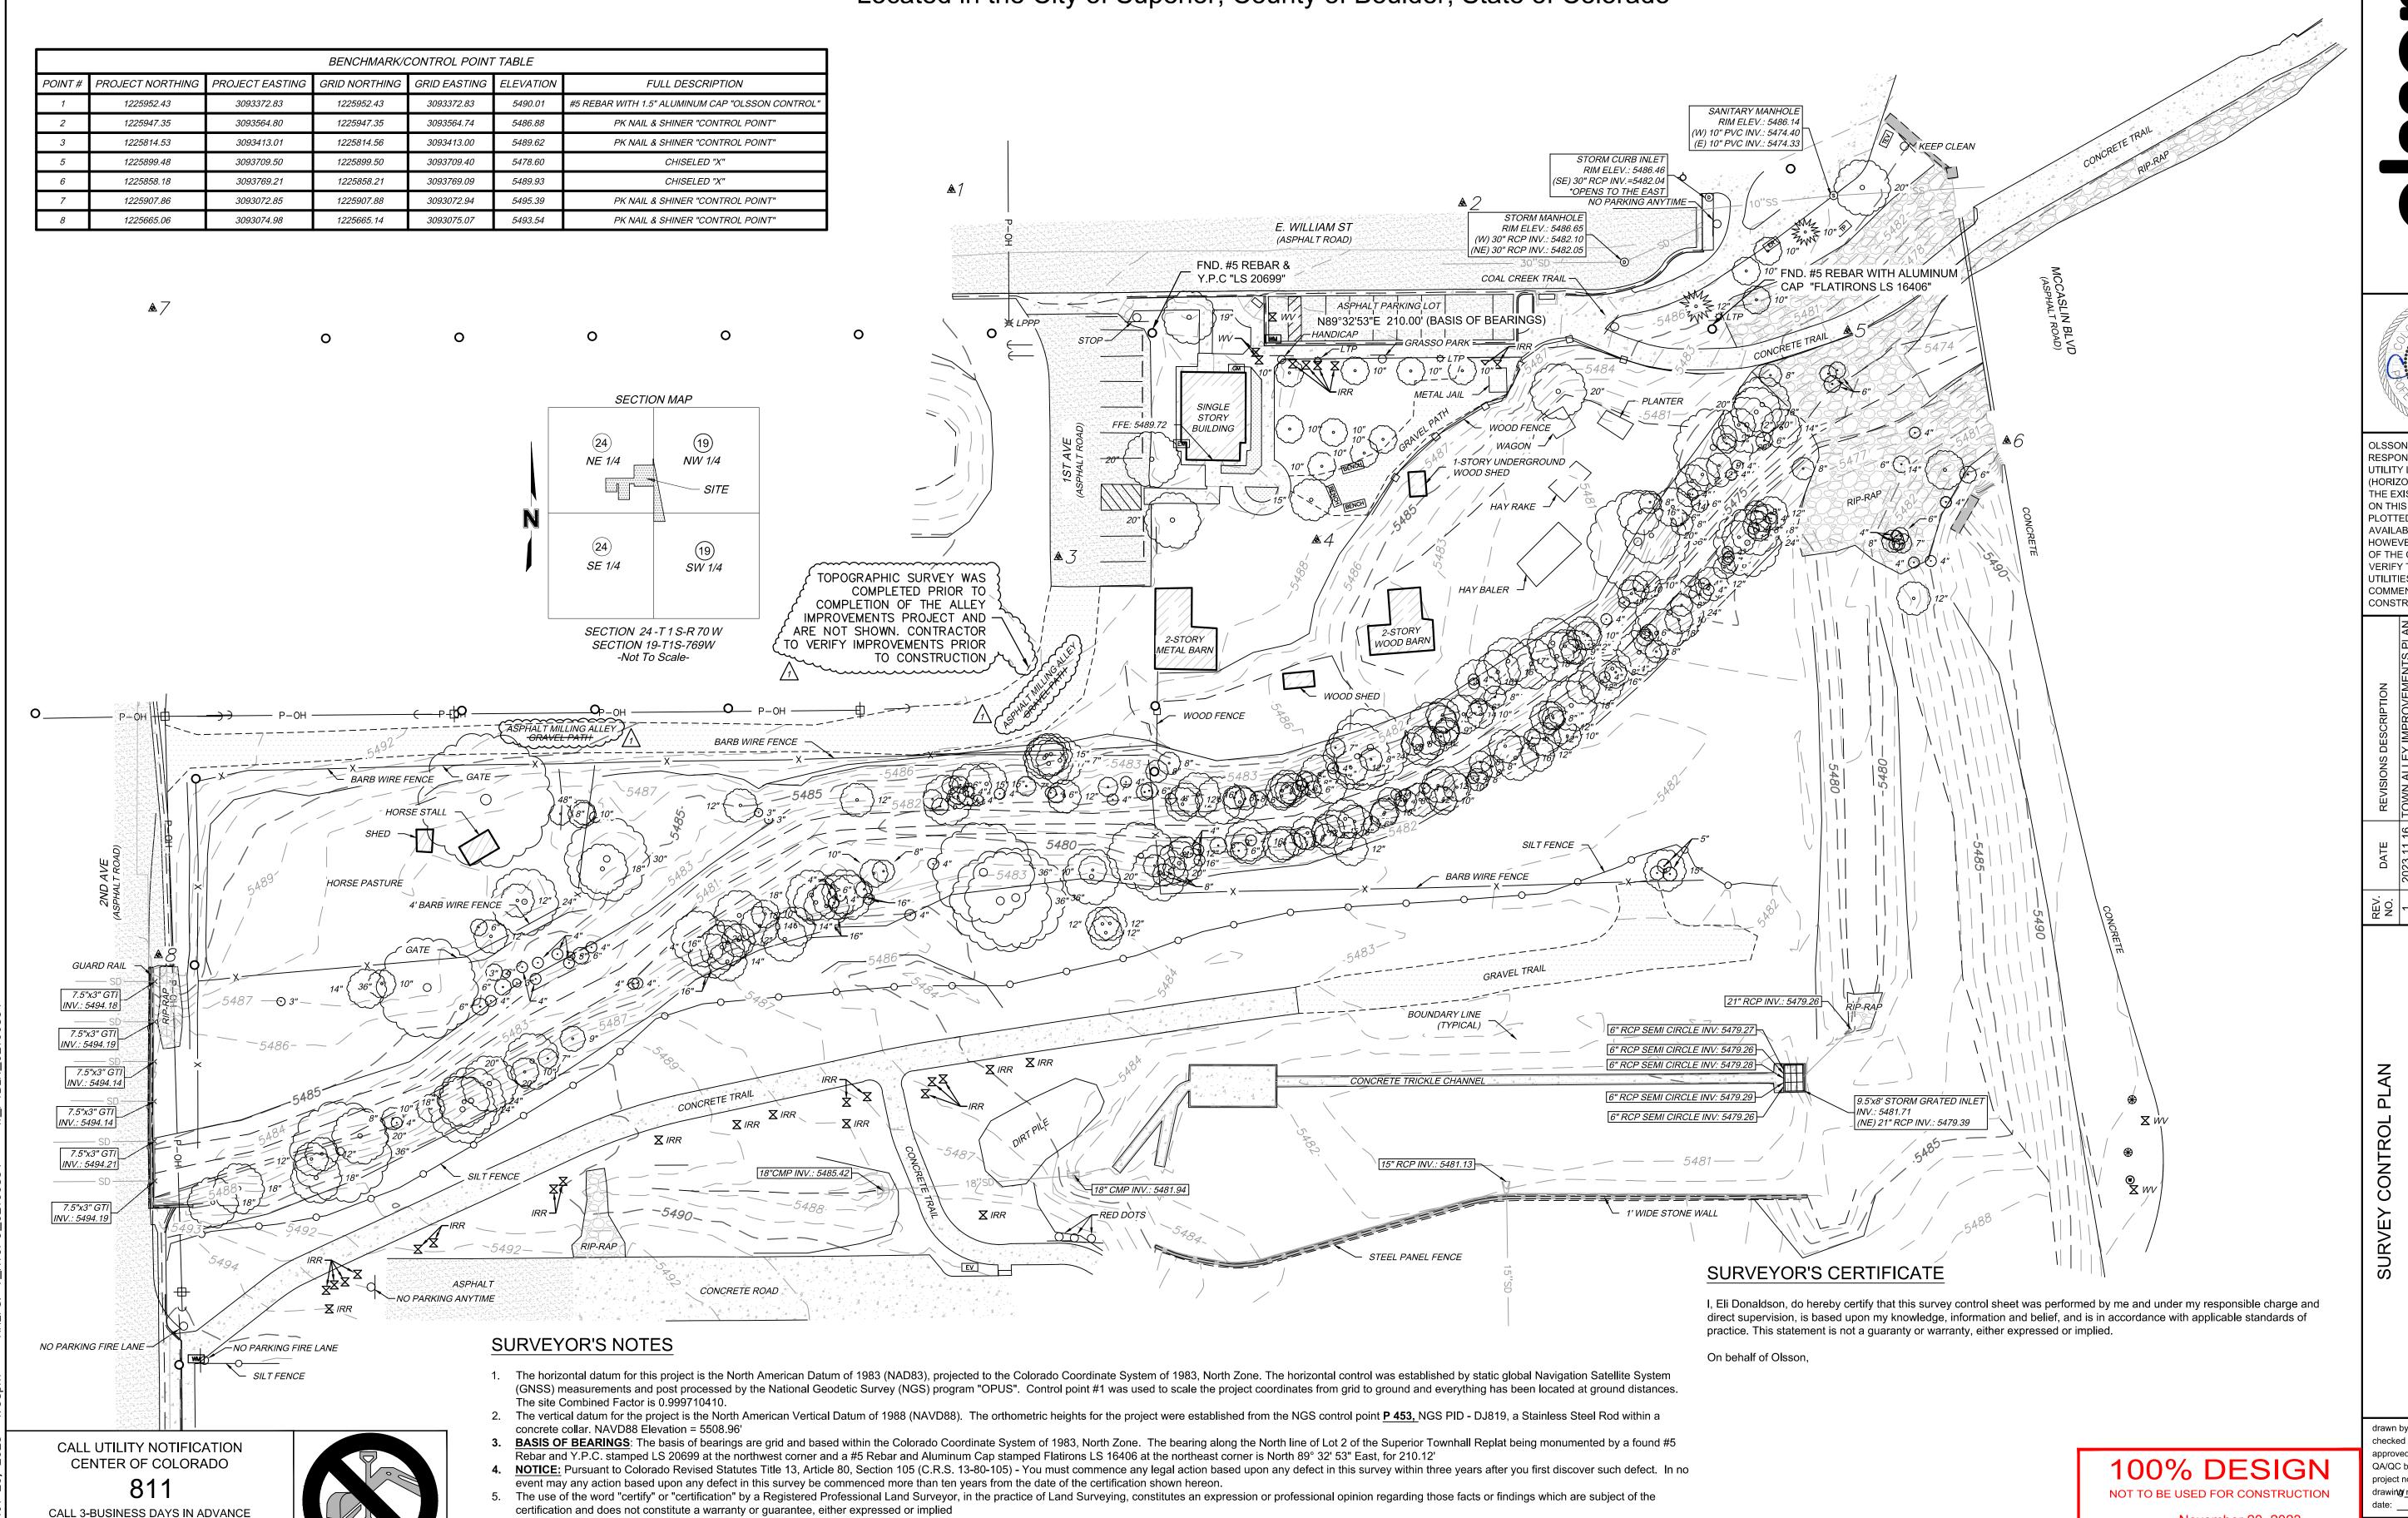

CALL 3-BUSINESS DAYS IN ADVANCE BEFORE YOU DIG, GRADE, OR EXCAVATE FOR THE MARKING OF UNDERGROUND MEMBER UTILITIES.



The purpose of this survey is to provide the control values used for the basis of this project.

There was a significant fire at this site which happened after the initial topographic data was collected. The topographic data was not revised to reflect possible changes to site features.

Original field work was completed: 7/28/2021. Additional topo was added 04/05/2023 on the South side of the creek and the Northeast corner of the site.

November 20, 2023 DATE PRINTED OLSSON

Eli J. Donaldson

Professional Land Surveyor

Colorado Registration Number: 38755

QA/QC by: project no.: drawing nxTOPO 02100854 DWG

SHEET of 23

UTILITY LOCATIONS COMMENCEMENT OF ANY CONSTRUCTION ACTIVITIES

B

				ALIGN	- TRAIL L	EFT BANK			
NO.		STATION	NORTHING	EASTING	LENGTH	LINE/CHORD BEARING	DELTA	TANGENT	RADIUS
L18		400+00.00 401+40.54	1225915.0041 1225774.4635	3093435.8937 3093435.8937	140.54'	S0°00'00"E			
C16	PC= PI= PT=	401+40.54 401+65.51 401+79.78	1225774.4635 1225749.4918 1225749.4635	3093435.8937 3093435.8937 3093460.8653	39.24'	S44*58'03"E	89 <b>*</b> 56'06"	24.97'	25.00'
C17	PC= PI= PT=	401+79.78 402+14.99 402+49.57	1225749.4635 1225749.4236 1225760.7117	3093460.8653 3093496.0738 3093529.4237	69.79'	N80°40'58"E	18°45'52"	35.21'	213.09'
C18	PC= PI= PT=	402+49.57 402+77.08 403+04.49	1225760.7117 1225770.1325 1225783.3861	3093529.4237 3093555.2752 3093579.3873	54.92'	N65°35'26"E	8*46'23"	27.51'	358.68'
L19		403+04.49 403+14.37	1225783.3861 1225788.4012	3093579.3873 3093587.8992	9.88'	N59°29'38"E			
C19	PC= PI= PT=	403+14.37 403+33.95 403+52.67	1225788.4012 1225798.3393 1225815.2538	3093587.8992 3093604.7667 3093614.6248	38.30'	N44°51'51"E	29 <b>°</b> 15'34"	19.58'	75.00'
L20		403+52.67 403+94.85	1225815.2538 1225851.7001	3093614.6248 3093635.8665	42.18'	N30°14'04"E			
C20	PC= PI= PT=	403+94.85 404+12.95 404+30.60	1225851.7001 1225867.3311 1225878.4511	3093635.8665 3093644.9765 3093659.2478	35.74'	N41°09'17"E	21°50'25"	18.09'	93.77'
C21	PC= PI= PT=	404+30.60 404+52.13 404+73.20	1225878.4511 1225891.6823 1225898.1860	3093659.2478 3093676.2288 3093696.7500	42.60'	N62°14'43"E	20°20'26"	21.53'	120.00'
C22	PC= PI= PT=	404+73.20 404+98.73 405+23.57	1225898.1860 1225905.8986 1225922.5362	3093696.7500 3093721.0863 3093740.4494	50.37'	N60°52'21"E	23°05'09"	25.53'	125.00'
C23	PC= PI= PT=	405+23.57 405+35.10 405+46.63	1225922.5362 1225930.0553 1225936.8532	3093740.4494 3093749.2003 3093758.5225	23.06'	N51*36'53"E	4 <b>°</b> 34'14"	11.54'	289.11'
L32		405+46.63 405+64.22	1225936.8532 1225947.2921	3093758.5225 3093772.6806	17.59'	N53°35'53"E			


CALL 3-BUSINESS DAYS IN ADVANCE BEFORE YOU DIG, GRADE, OR EXCAVATE FOR THE MARKING OF UNDERGROUND MEMBER UTILITIES.



				Д	LIGN - BI	RIDGE			
NO.		STATION	NORTHING	EASTING	LENGTH	LINE/CHORD BEARING	DELTA	TANGENT	RADIUS
L21		5+00.00 5+29.17	1225616.6757 1225645.1826	3093350.3614 3093344.1858	29.17'	N12°13'24"W			
C24	PC= PI= PT=	5+29.17 5+45.53 5+59.26	1225645.1826 1225661.1768 1225673.0057	3093344.1858 3093340.7209 3093352.0302	30.09'	N15°44'43"E	55 <b>°</b> 56'14"	16.37'	30.82'
L22		5+59.26 5+74.32	1225673.0057 1225683.8946	3093352.0302 3093362.4409	15.06'	N43°42'50"E			
L23		5+74.32 6+26.19	1225683.8946 1225720.6070	3093362.4409 3093399.0799	51.87'	N44°56'34"E			
L24		6+26.19 6+68.50	1225720.6070 1225750.4696	3093399.0799 3093429.0565	42.31'	N45°06'33"E			
C34	PC= PI= PT=	6+68.50 6+78.46 6+87.45	1225750.4696 1225757.7086 1225767.6622	3093429.0565 3093435.8882 3093435.8937	18.95'	N21°41'12"E	43"18'37"	9.95'	25.07'
L31		6+94.35 7+03.79	1225774.5649 1225784.0041	3093435.8937 3093435.8937	9.44'	N0°00'00"E			

				А	LIGN - ST	TAIRS .			
NO.		STATION	NORTHING	EASTING	LENGTH	LINE/CHORD BEARING	DELTA	TANGENT	RADIUS
C35	PC= PI= PT=	300+00.00 300+07.79 300+15.59	1225916.7433 1225908.9497 1225901.1558	3093596.6697 3093596.5605 3093596.6479	15.59'	S0°04'48"W	1°26'45"	7.79'	617.72'
L33		300+15.59 300+22.49	1225901.1558 1225901.1558	3093596.6479 3093603.5490	6.90'	N90°00'00"E			
C37	PC= PI= PT=	300+22.49 300+51.87 300+79.61	1225901.1558 1225893.5216 1225871.6722	3093603.5490 3093631.9170 3093651.5545	57.12'	S58 <b>°</b> 26'34 <b>"</b> E	32*59'23"	29.38'	99.21'

E. WILLIAM ST (ASPHALT ROAD)

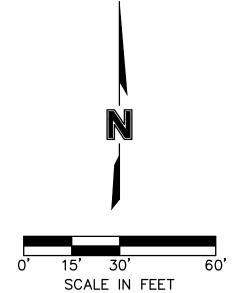

(L) 10 1 VO 11VV.. 07/7.00

OLSSON ASSUMES NO RESPONSIBILITY FOR EXISTING UTILITY LOCATIONS (HORIZONTAL OR VERTICAL). THE EXISTING UTILITIES SHOWN ON THIS DRAWING HAVE BEEN PLOTTED FROM THE BEST AVAILABLE INFORMATION. IT IS HOWEVER THE RESPONSIBILITY OF THE CONTRACTOR TO FIELD VERIFY THE LOCATION OF ALL UTILITIES PRIOR TO THE COMMENCEMENT OF ANY CONSTRUCTION ACTIVITIES.

ASLIN BLVD 2ND AVENUE TO I FINAL DESIGN


drawn by: 100% DESIGN NOT TO BE USED FOR CONSTRUCTION

November 20, 2023 DATE PRINTED OLSSON


drawing nw:HCP 02100854 DWG SHEET of 23

QA/QC by: project no.:

STAIRS \_>
CENTERLINE TRAIL LEFT BANK CENTERLINE 604+91.07 BRIDGE CENTERLINE

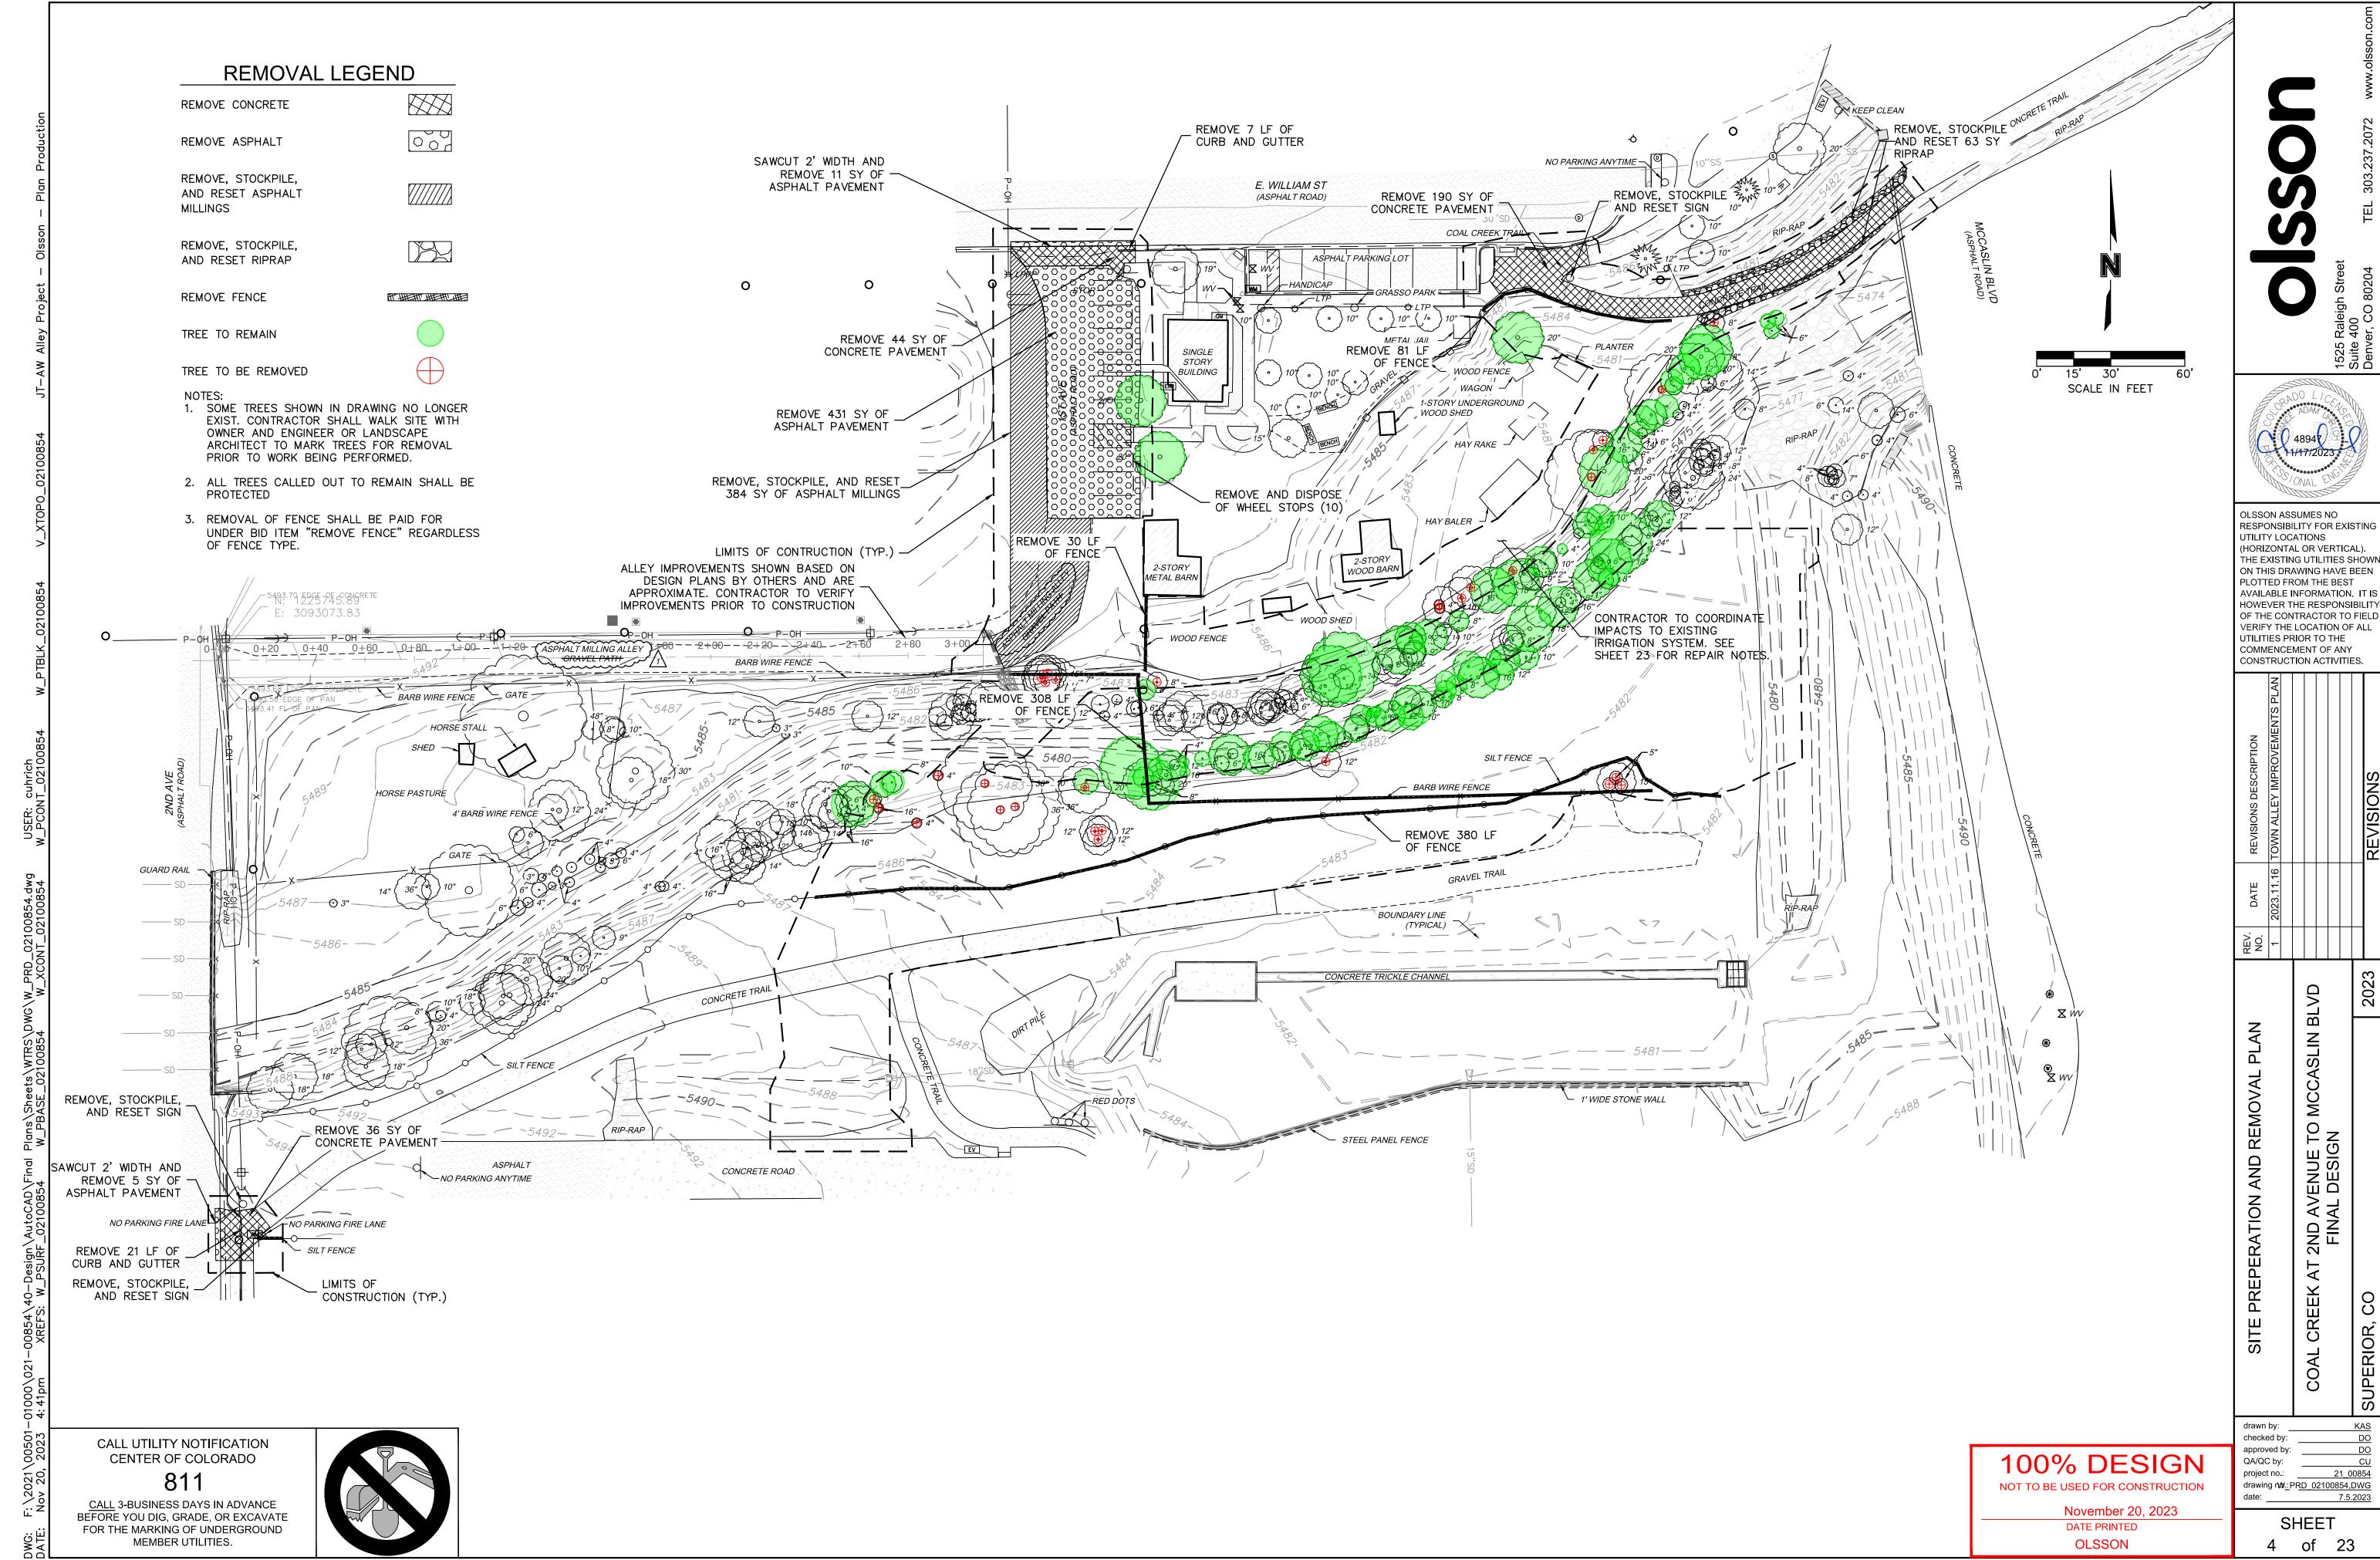

THE EXISTING UTILITIES SHOWN

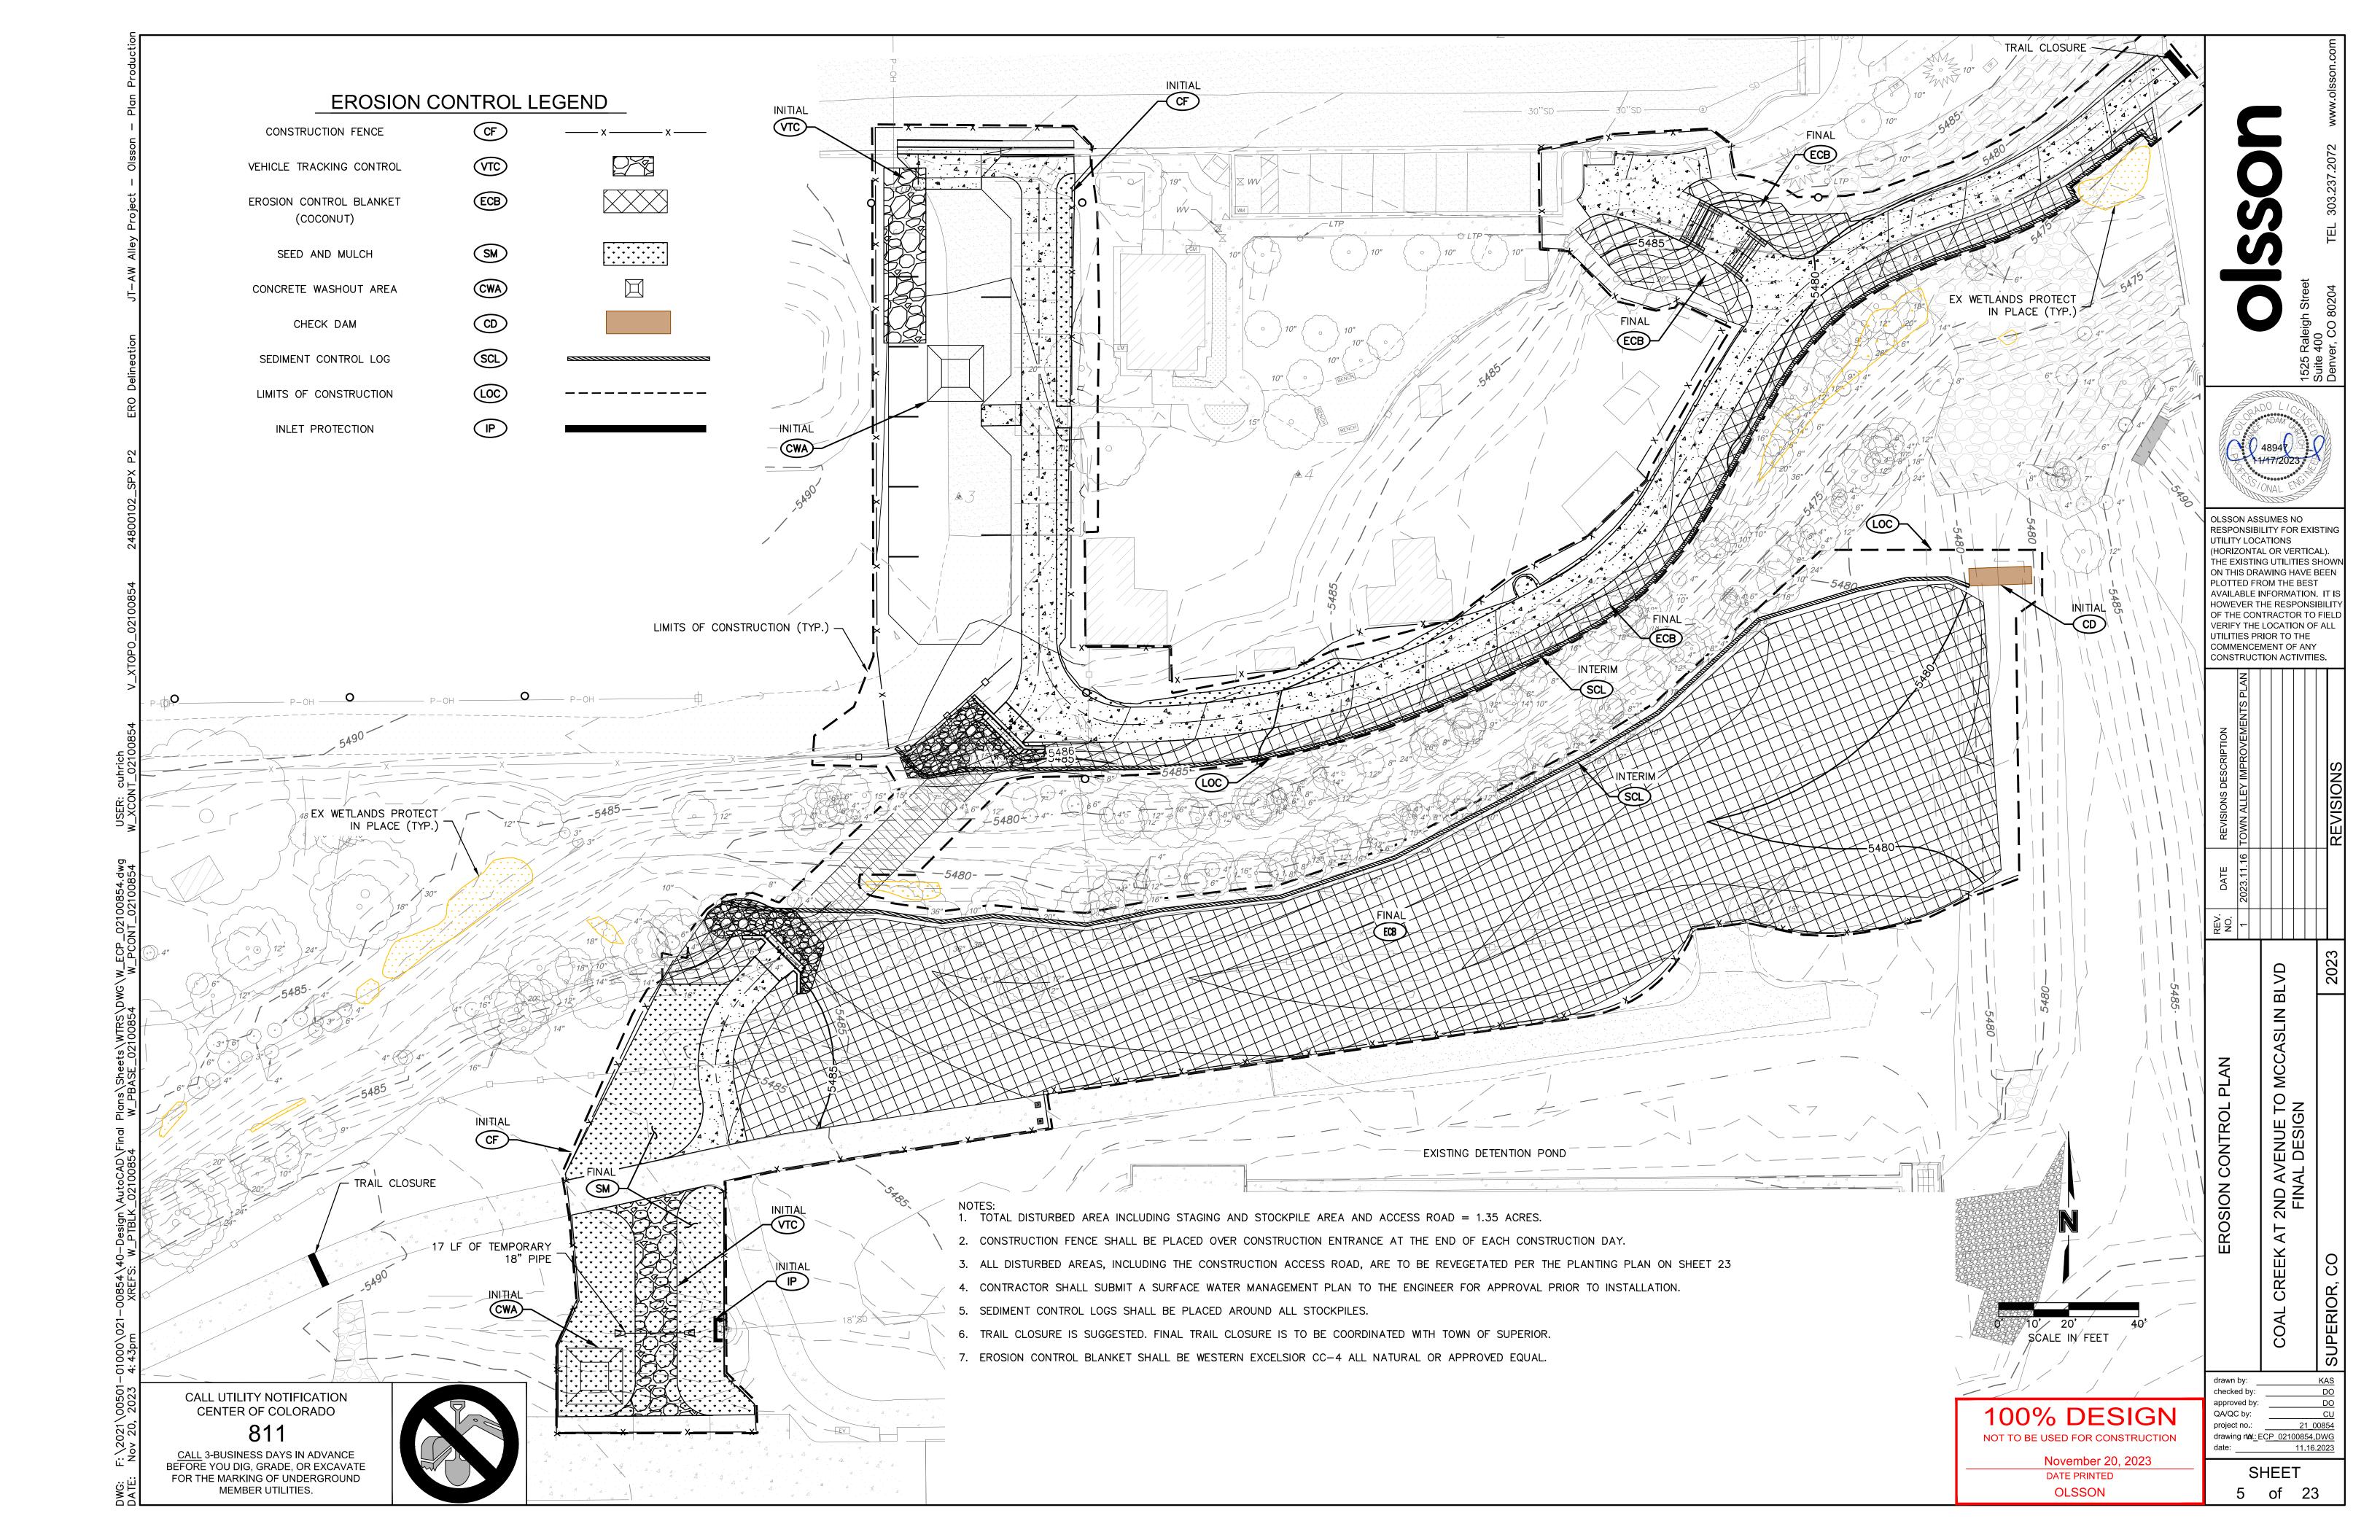




RESPONSIBILITY FOR EXISTING THE EXISTING UTILITIES SHOWN ON THIS DRAWING HAVE BEEN OF THE CONTRACTOR TO FIELD

SHEET of 23

OLSSON

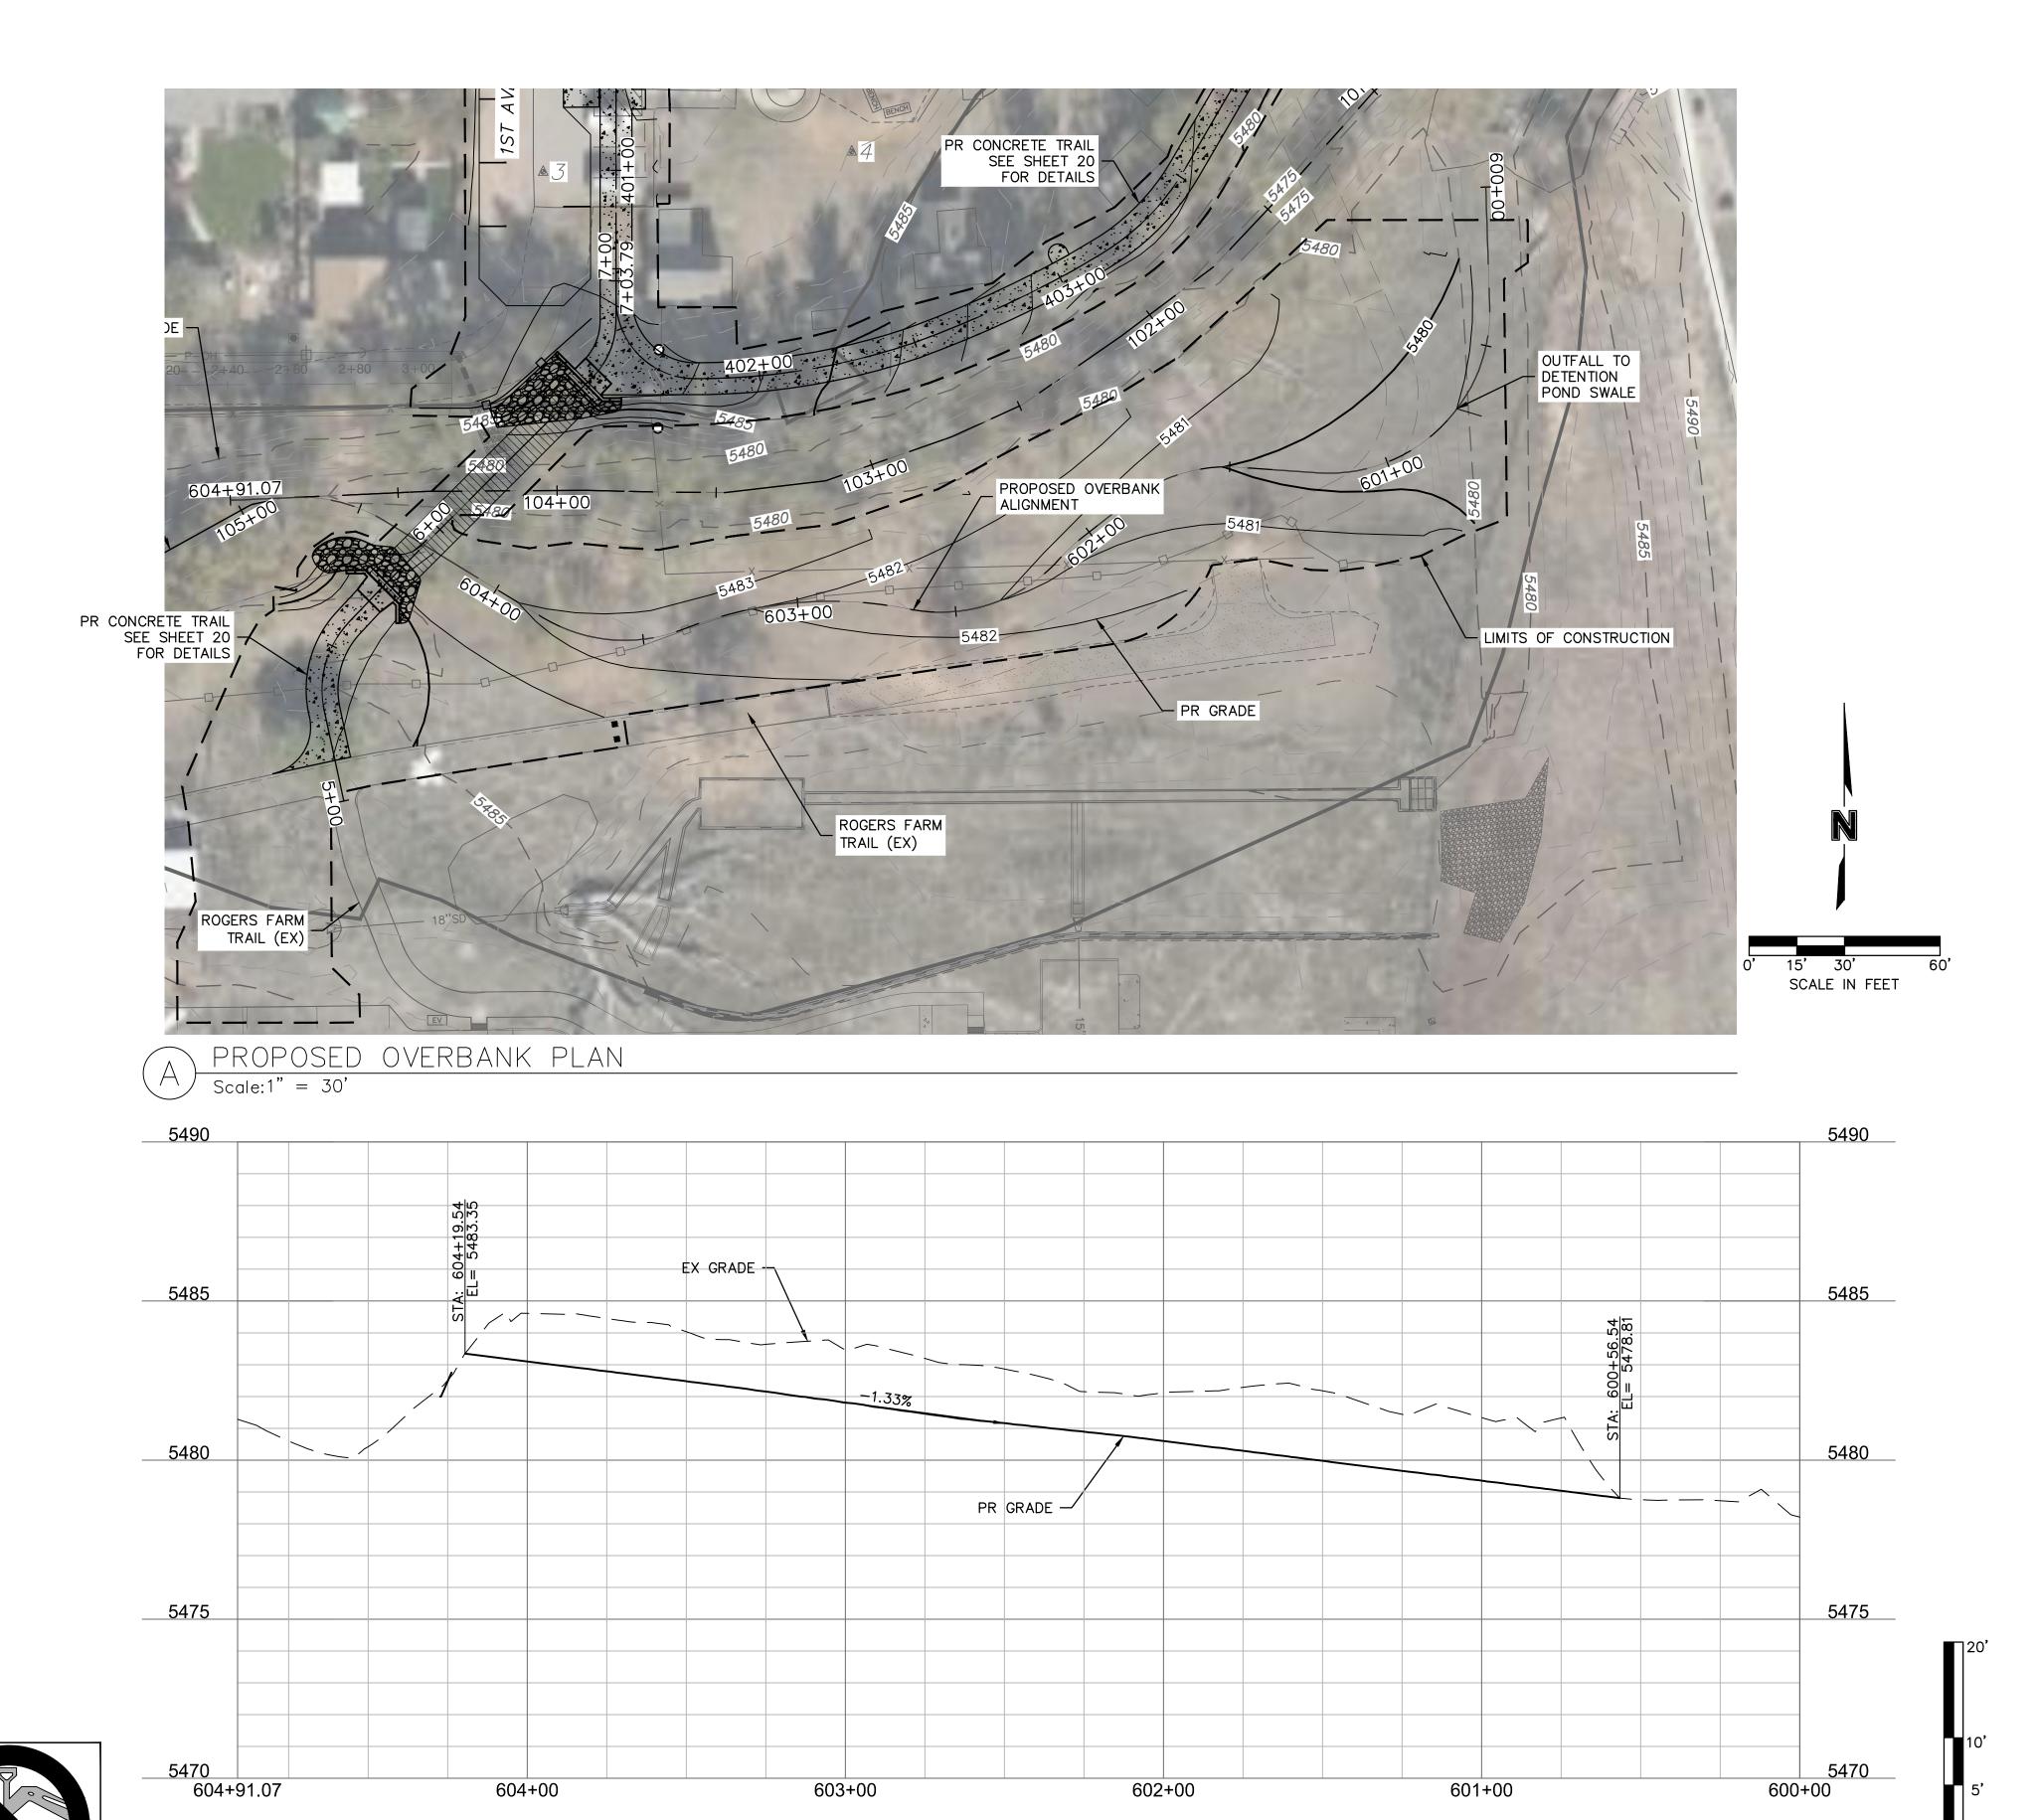

**SSO** treet

1525 Raleigh Str Suite 400 Denver, CO 8020

48947 - 11/47/2023

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UTILITY LOCATIONS
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THE EXISTING UTILITIES SHOWN
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CONSTRUCTION ACTIVITIES.

	REV.	DATE	REVISIONS DESCRIPTION
	1	2023.11.16	2023.11.16 TOWN ALLEY IMPROVEMENTS PL/
2			
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OVERBANK PLAN AND PROFILE

2ND AVENUE TO MCCASLIN BLVD
FINAL DESIGN

drawn by:
checked by:
approved by:
QA/QC by:
project no.:

Column by:
Checked by:
Checked

project no.: 021.00854 drawing no.: W PP.DWG date: 11.20.2023

SHEET

7 of 23

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0' 15' 30' SCALE IN FEET BE USED FOR CONSTRUCT

November 20, 2023

DATE PRINTED

OLSSON

CALL UTILITY NOTIFICATION
CENTER OF COLORADO
811

CALL 3-BUSINESS DAYS IN ADVANCE

811


<u>CALL</u> 3-BUSINESS DAYS IN ADVANCE
BEFORE YOU DIG, GRADE, OR EXCAVATE
FOR THE MARKING OF UNDERGROUND
MEMBER UTILITIES.

PROPOSED OVERBANK PROFILE

Scale:1" = 30'

TRAIL RIGHT BANK AND BRIDGE PLAN


Scale:1" = 30'

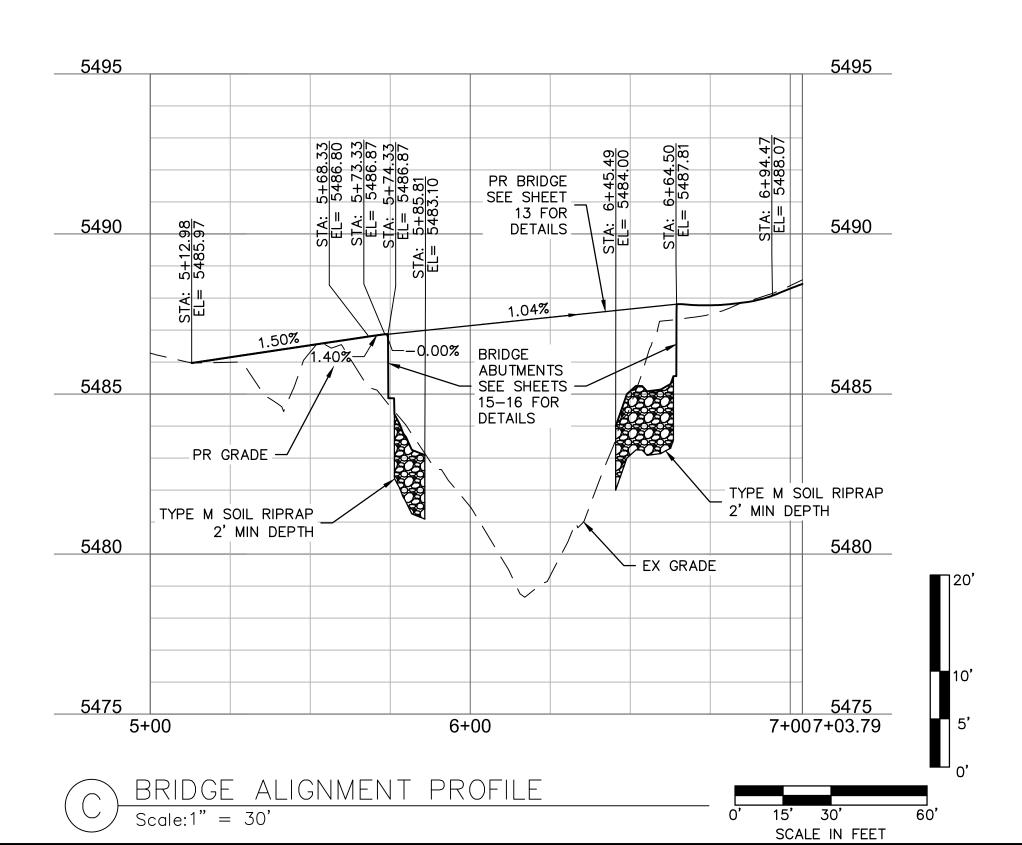

CALL UTILITY NOTIFICATION CENTER OF COLORADO

811

CALL 3-BUSINESS DAYS IN ADVANCE BEFORE YOU DIG, GRADE, OR EXCAVATE FOR THE MARKING OF UNDERGROUND MEMBER UTILITIES.

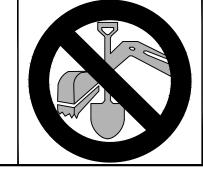

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DATE PRINTED
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SCALE IN FEET

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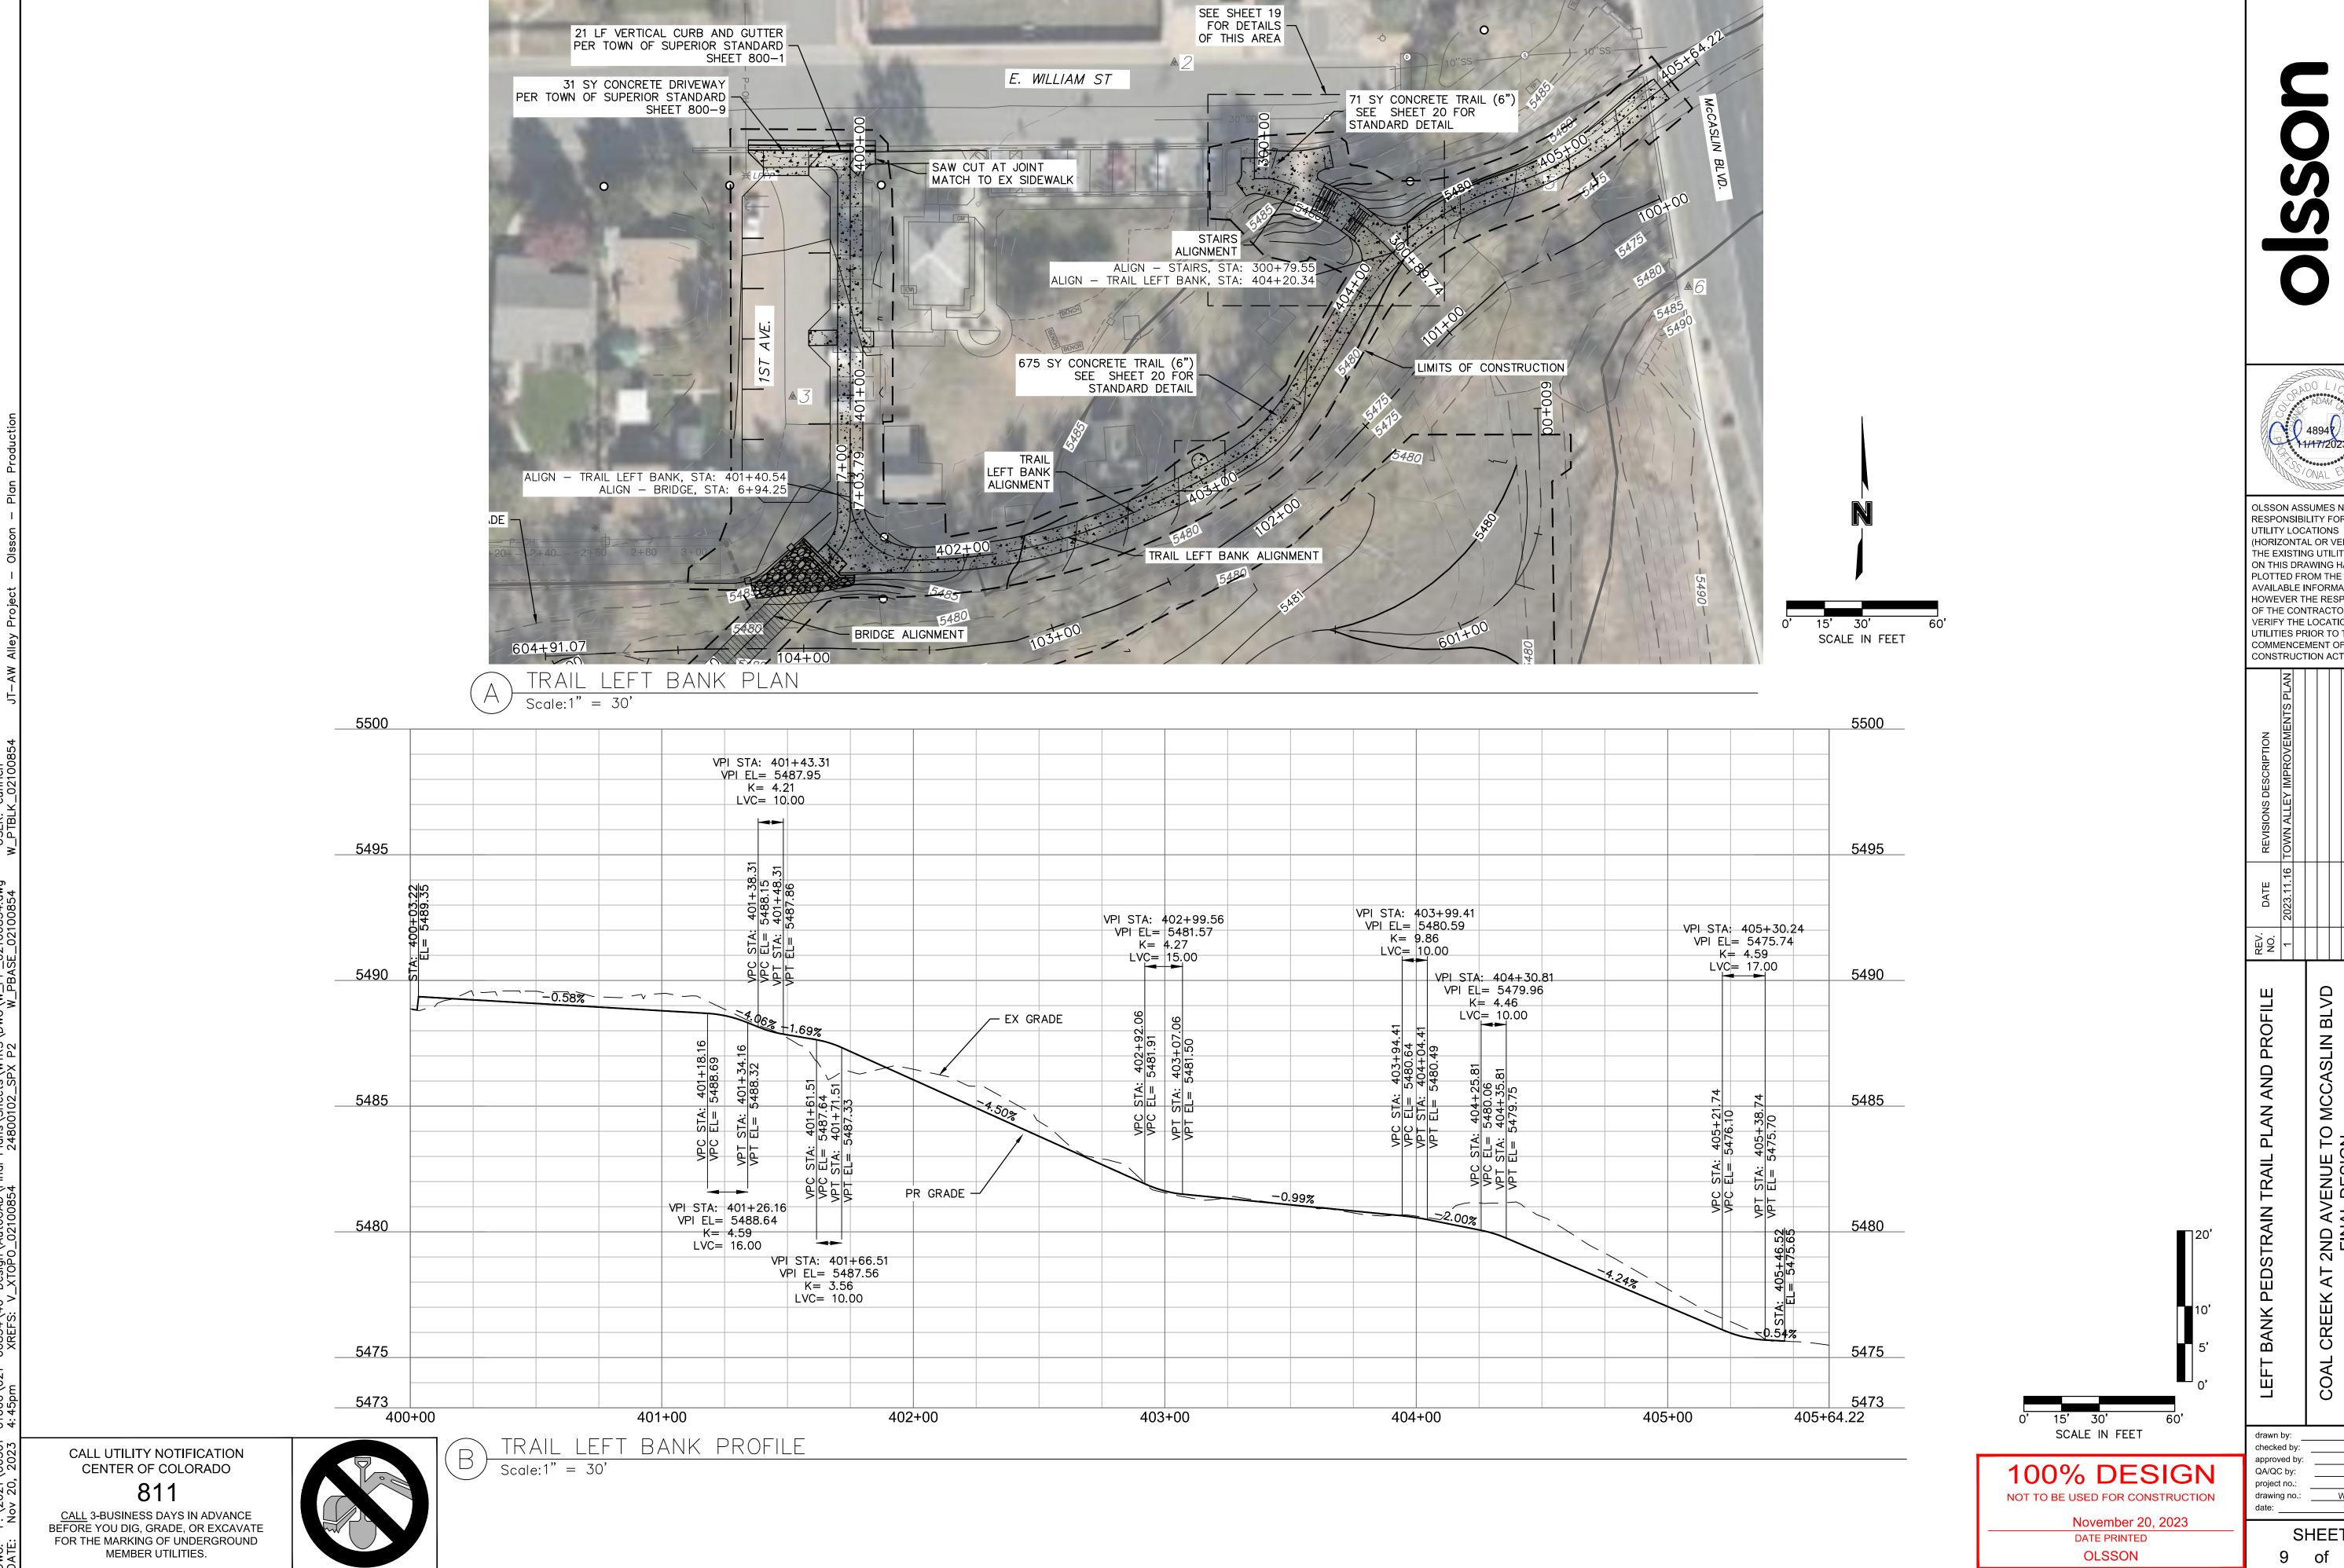
Щ	REV.	DATE	REVISIONS DESCRIPTION
	_	2023 11 16	2023.11.16 TOWN ALLEY IMPROVEMENTS PLAN
<u> </u>			
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PEDESTRIAN TRAIL PLAN AND PROFILE

K AT 2ND AVENUE TO MCCASLIN BLVD
FINAL DESIGN

drawn by: KS
checked by: DO
approved by: CU
project no.: 021.00854
drawing no.: W PP.DWG
date: 11.20.2023

SHEET 8 of 23




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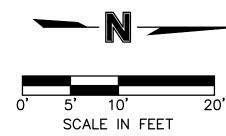
CONSTRUCTION ACTIVITIES.

2ND AVENUE TO P FINAL DESIGN


021.00854 drawing no .: W PP.DWG 11.20.2023

SHEET of 23



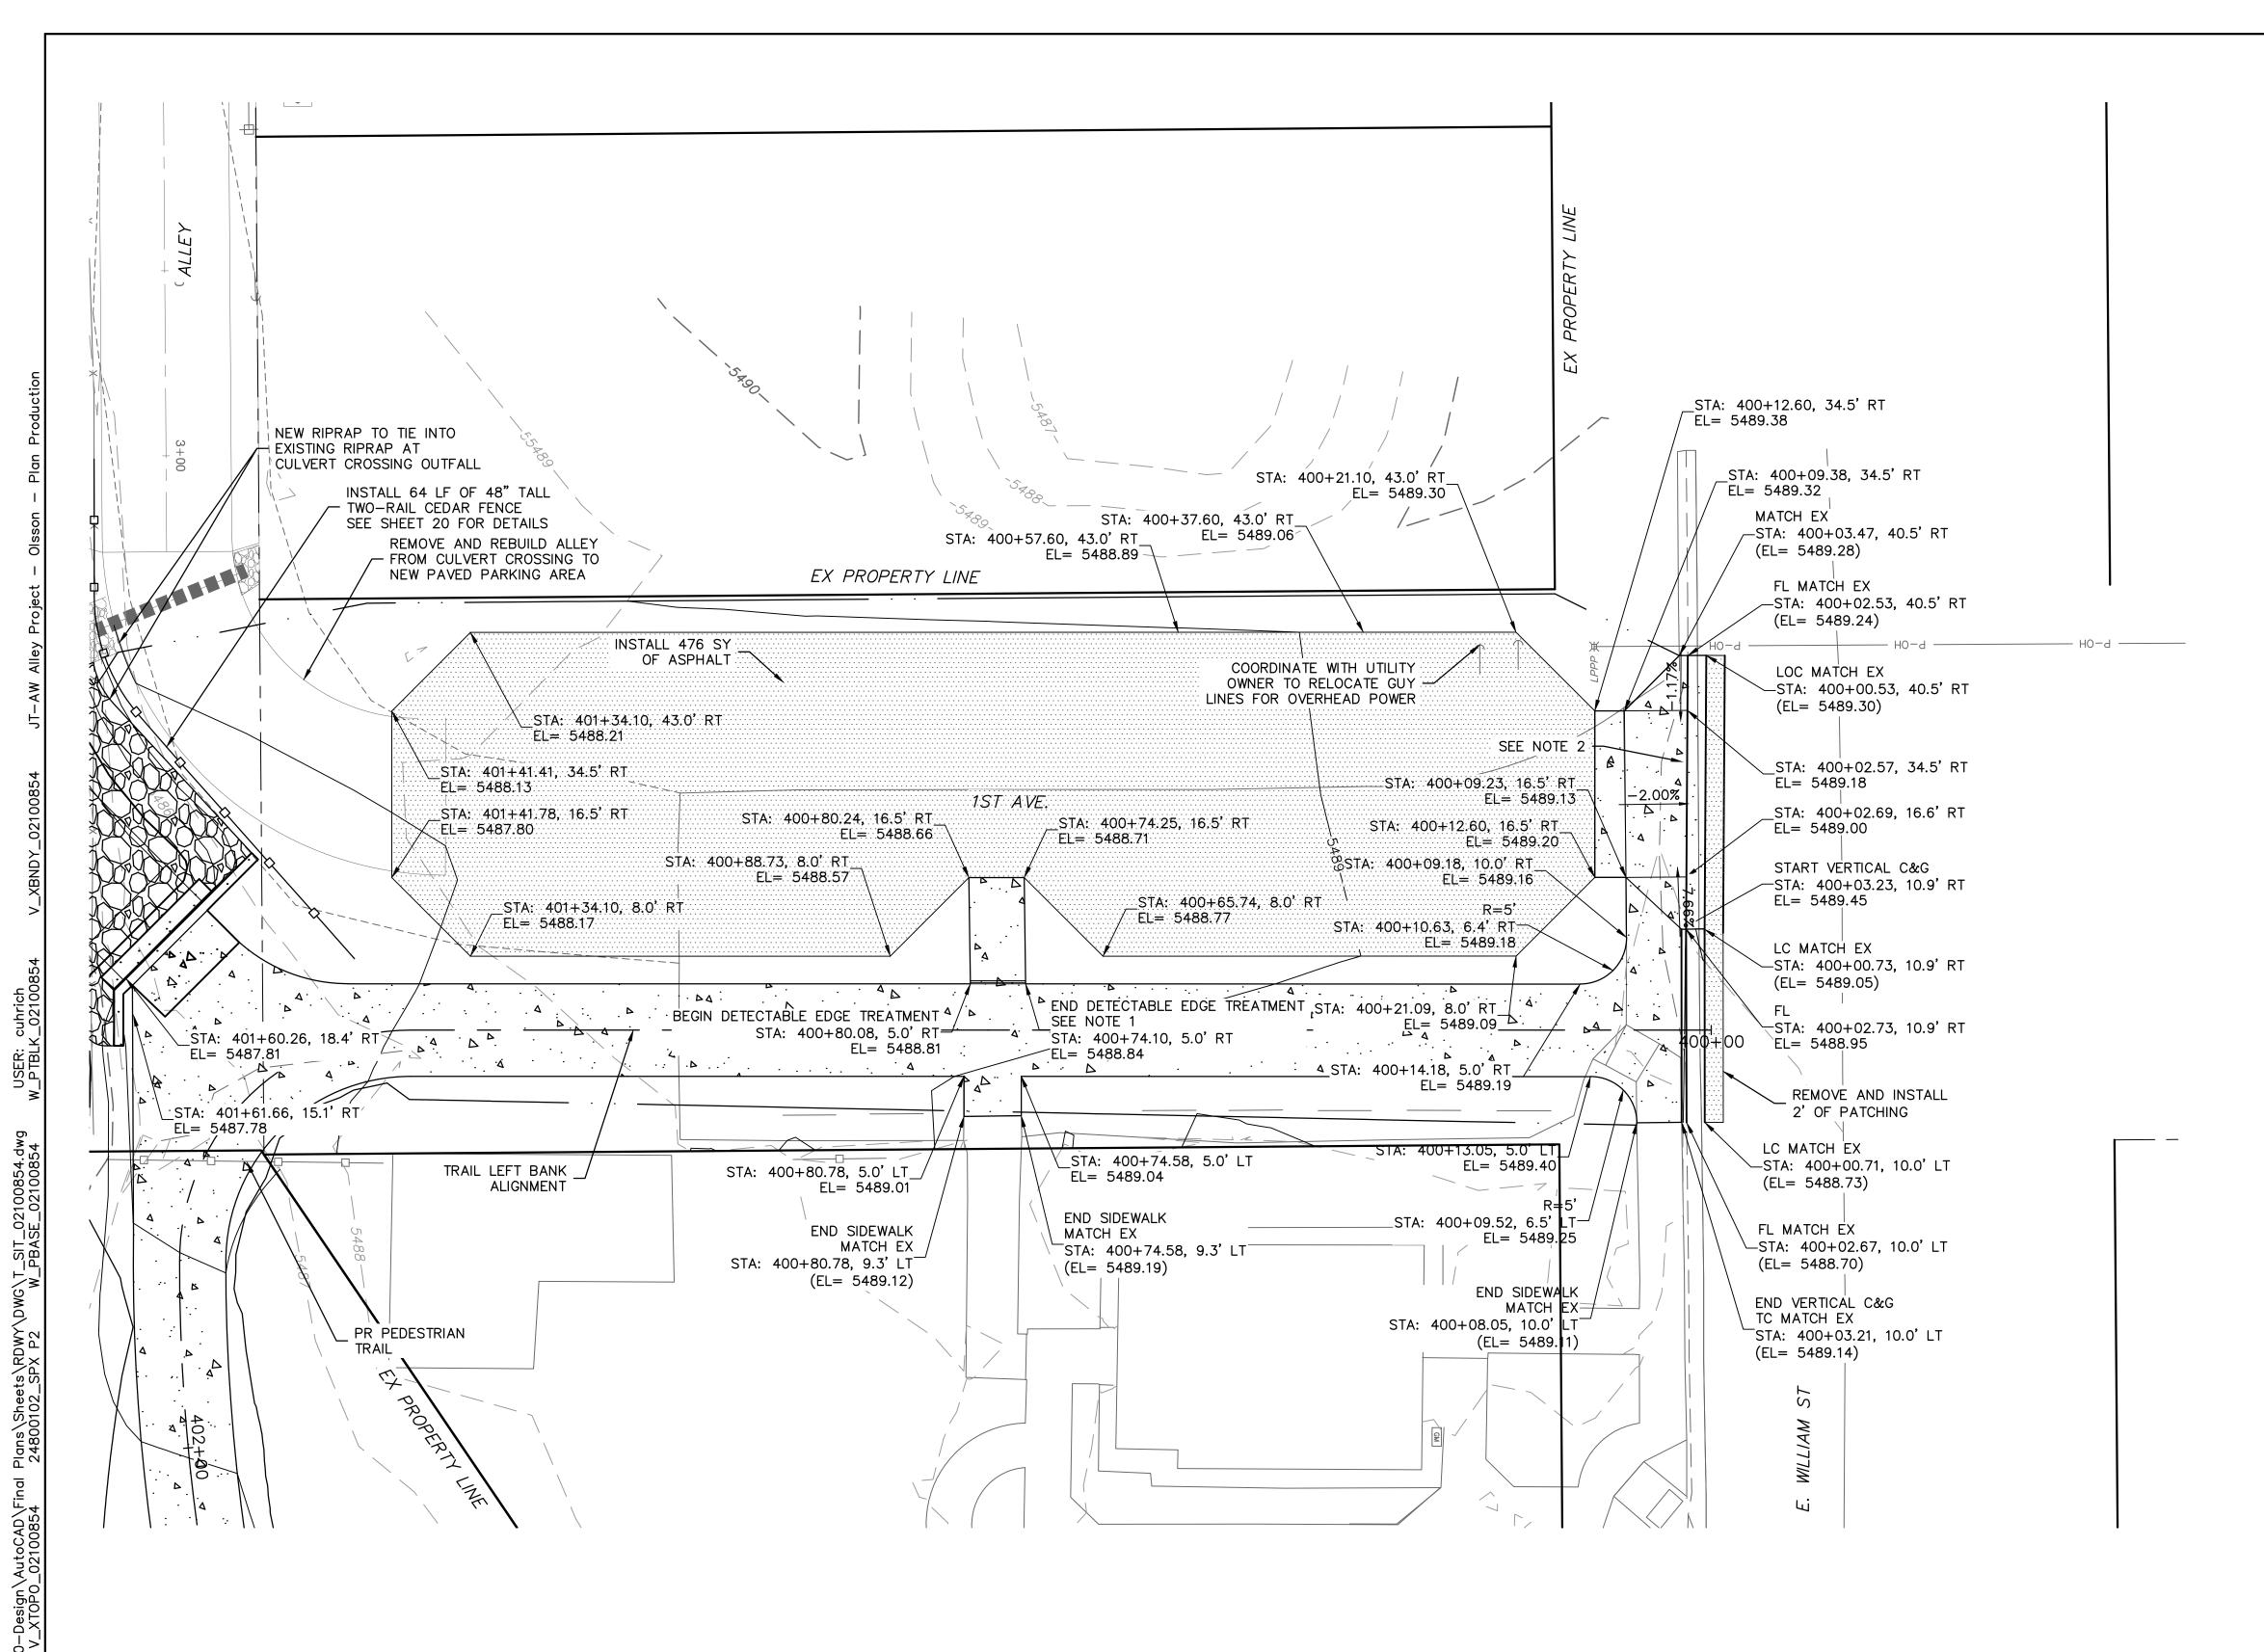

#### <u>LEGEND</u>

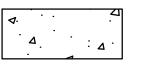

INSTALL CONCRETE PAVEMENT



INSTALL HEAVY DUTY ASPHALT PAVEMENT (SEE TOWN OF SUPERIOR STANDARDS SECTION 900)

GRADING LIMITS

TC: TOP BACK OF CURB

FL: FLOWLINE

LC: LIP OF CURB

C&G: CURB AND GUTTER

(EL= XXXX.XX): EXISTING ELEVATION

#### <u>NOTES</u>


- 1. COORDINATE WITH THE TOWN FOR THE DETECTABLE EDGE TREATMENT. IT IS TO BE 4" WIDE MIN, AND DETECTABLE UNDERFOOT STAMPED CONCRETE OR SIMILAR.
- 2. CONSTRUCT DRIVEWAY PER TOWN OF SUPERIOR STANDARD SHEET 800-9.

drawn by: checked by: approved by: QA/QC by:

> SHEET 10 of 23

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November 20, 2023 DATE PRINTED OLSSON

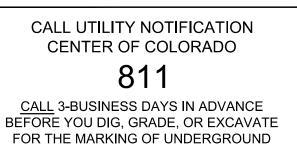

MEMBER UTILITIES.




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တ		NO.	DATE	REVISIONS DESCRIPTION
		_	2023.11.16	2023.11.16   IOWN ALLEY IMPROVEMENTS P
D B N S	Z \ \			
	, ,			
	2023			REVISIONS

2ND AVENUE TO I FINAL DESIGN GRADING PARKING CREEK

project no.: 021-00854 drawing no.: T SIT.DWG date: \_\_\_\_ 11.20.2023

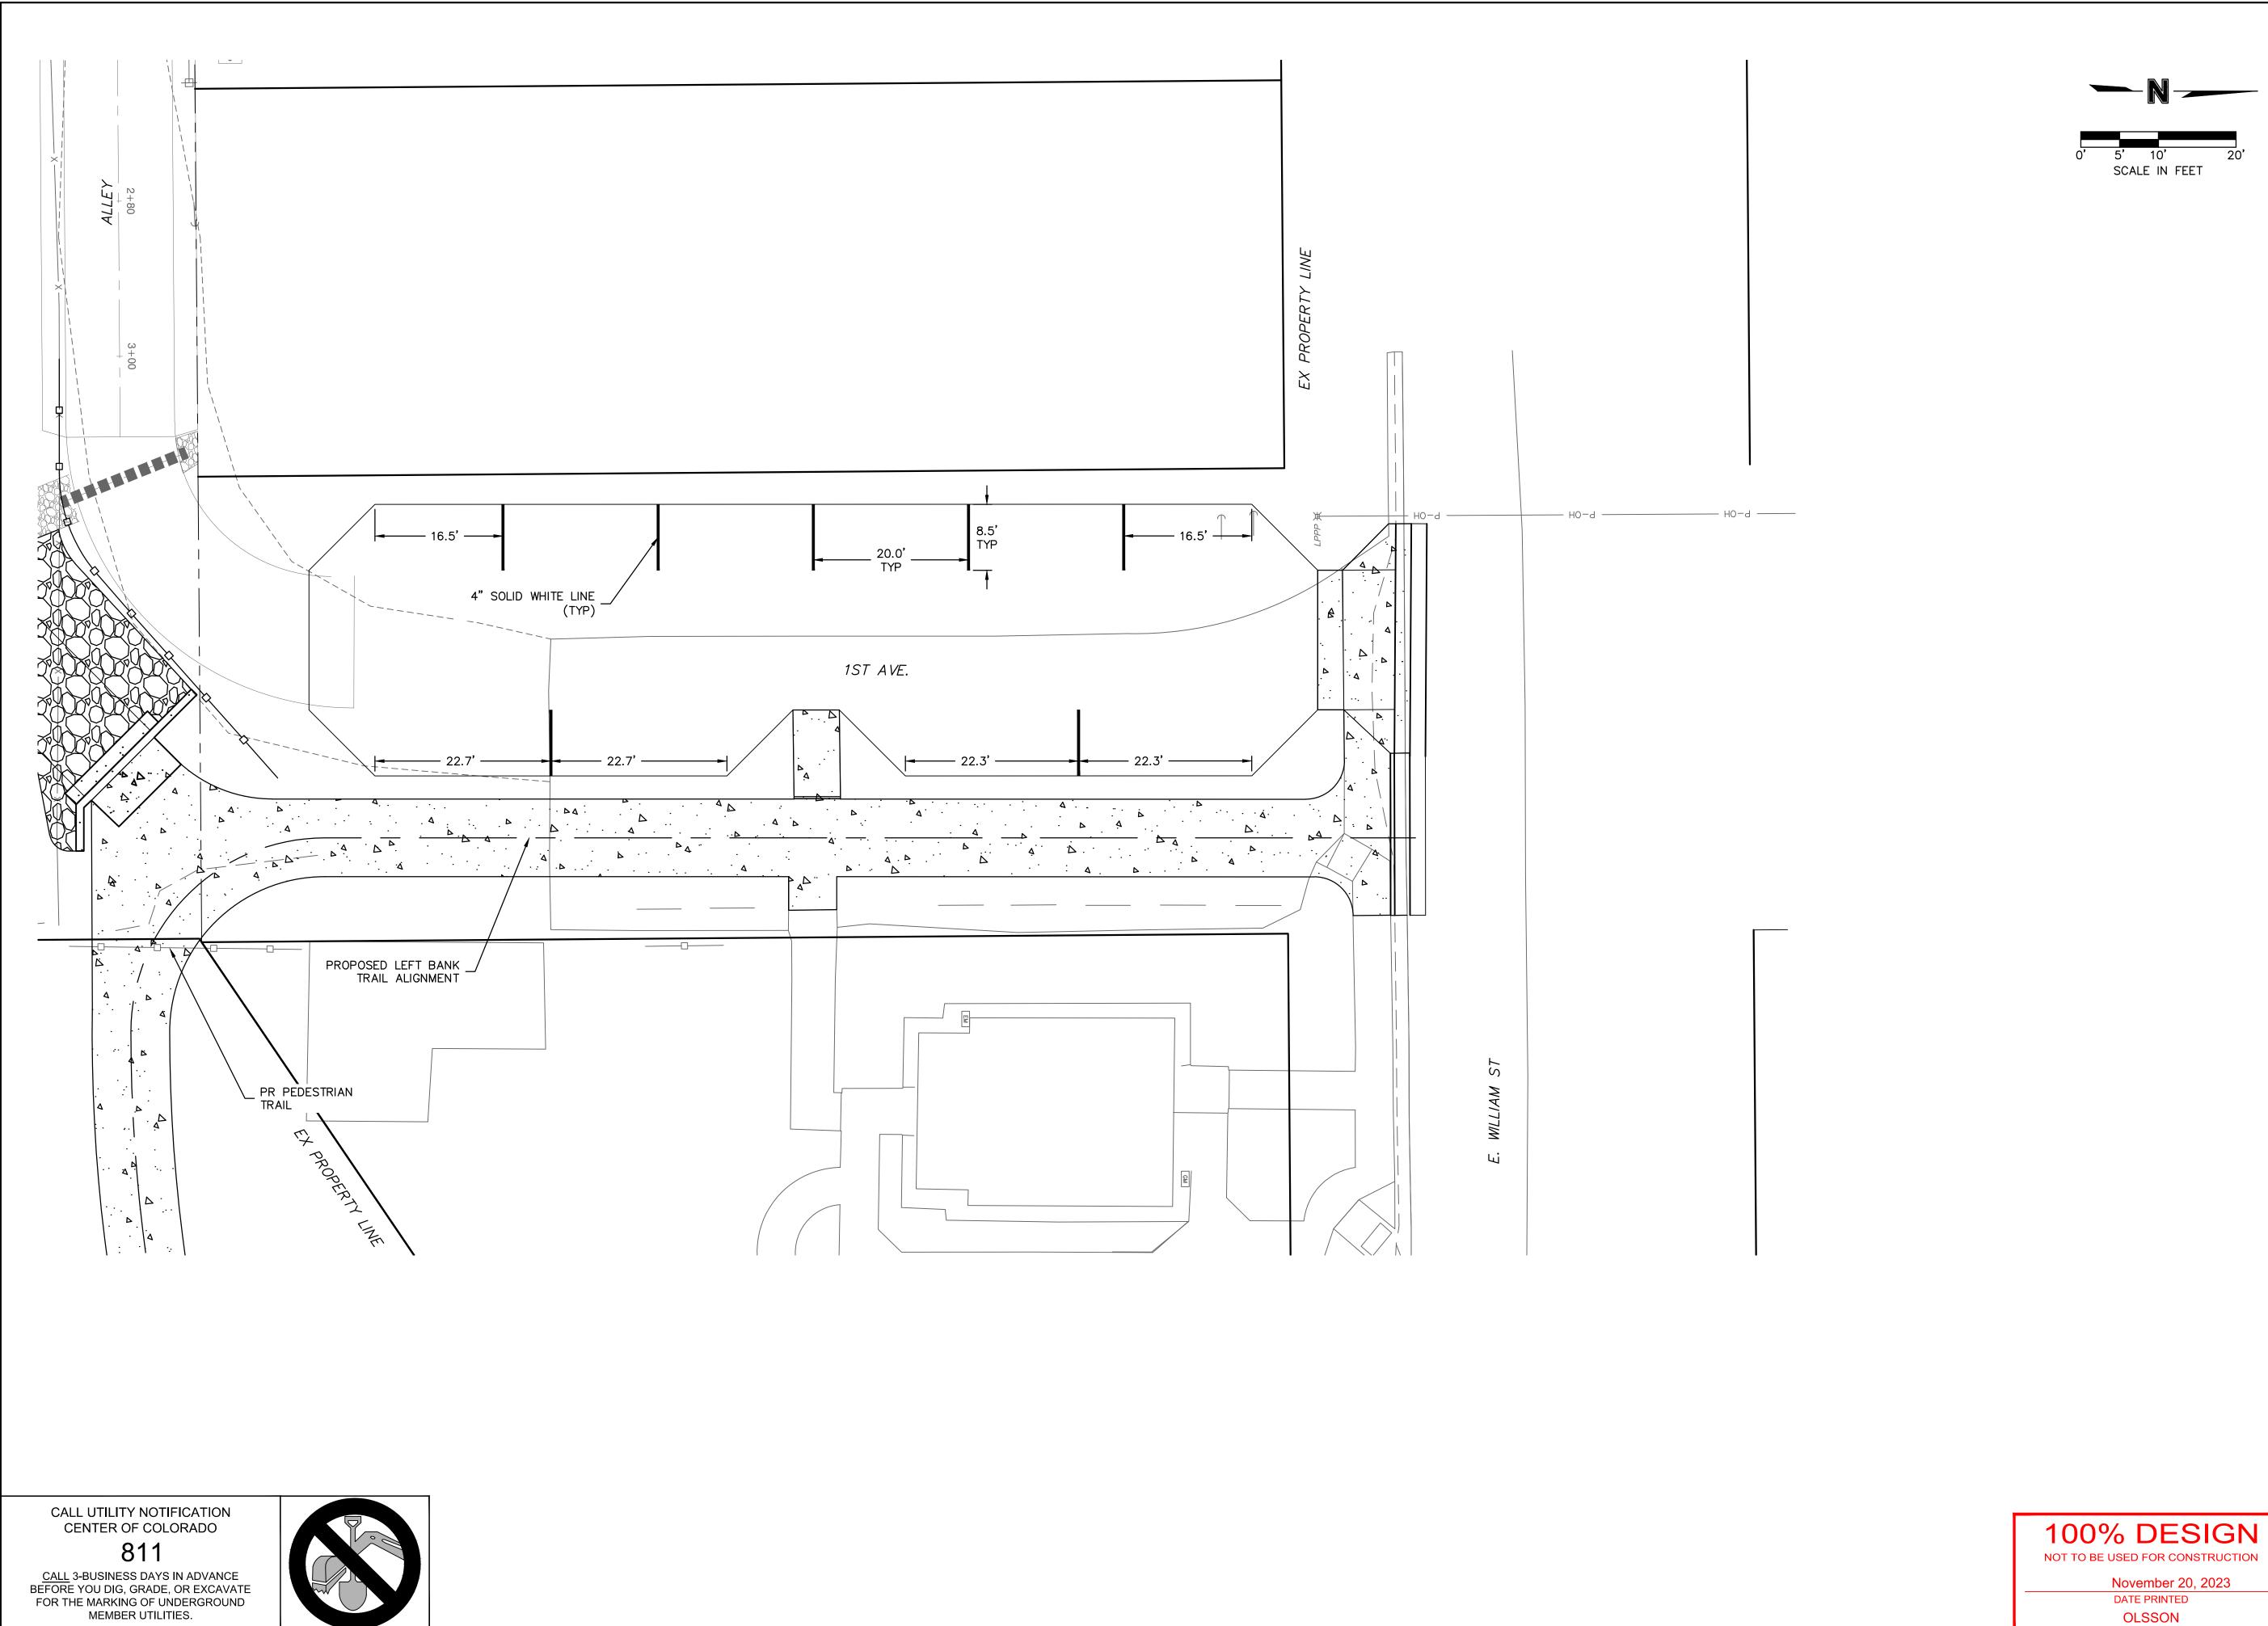

SCALE IN FEET

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	Z				
REVISIONS DESCRIPTION	2023.11.16   TOWN ALLEY IMPROVEMENTS PLAN				REVISIONS
DATE	2023 11 16				
REV. NO.	1				

2ND AVENUE TO MCCASLIN BLVD FINAL DESIGN

COAL CREEK

drawn by: checked by: approved by: 
 QA/QC by:
 MO

 project no.:
 021-00854


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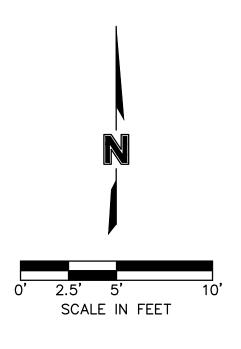
 date:
 11.20.2023
 QA/QC by:

SHEET 11 of 23


100% DESIGN

November 20, 2023 DATE PRINTED OLSSON



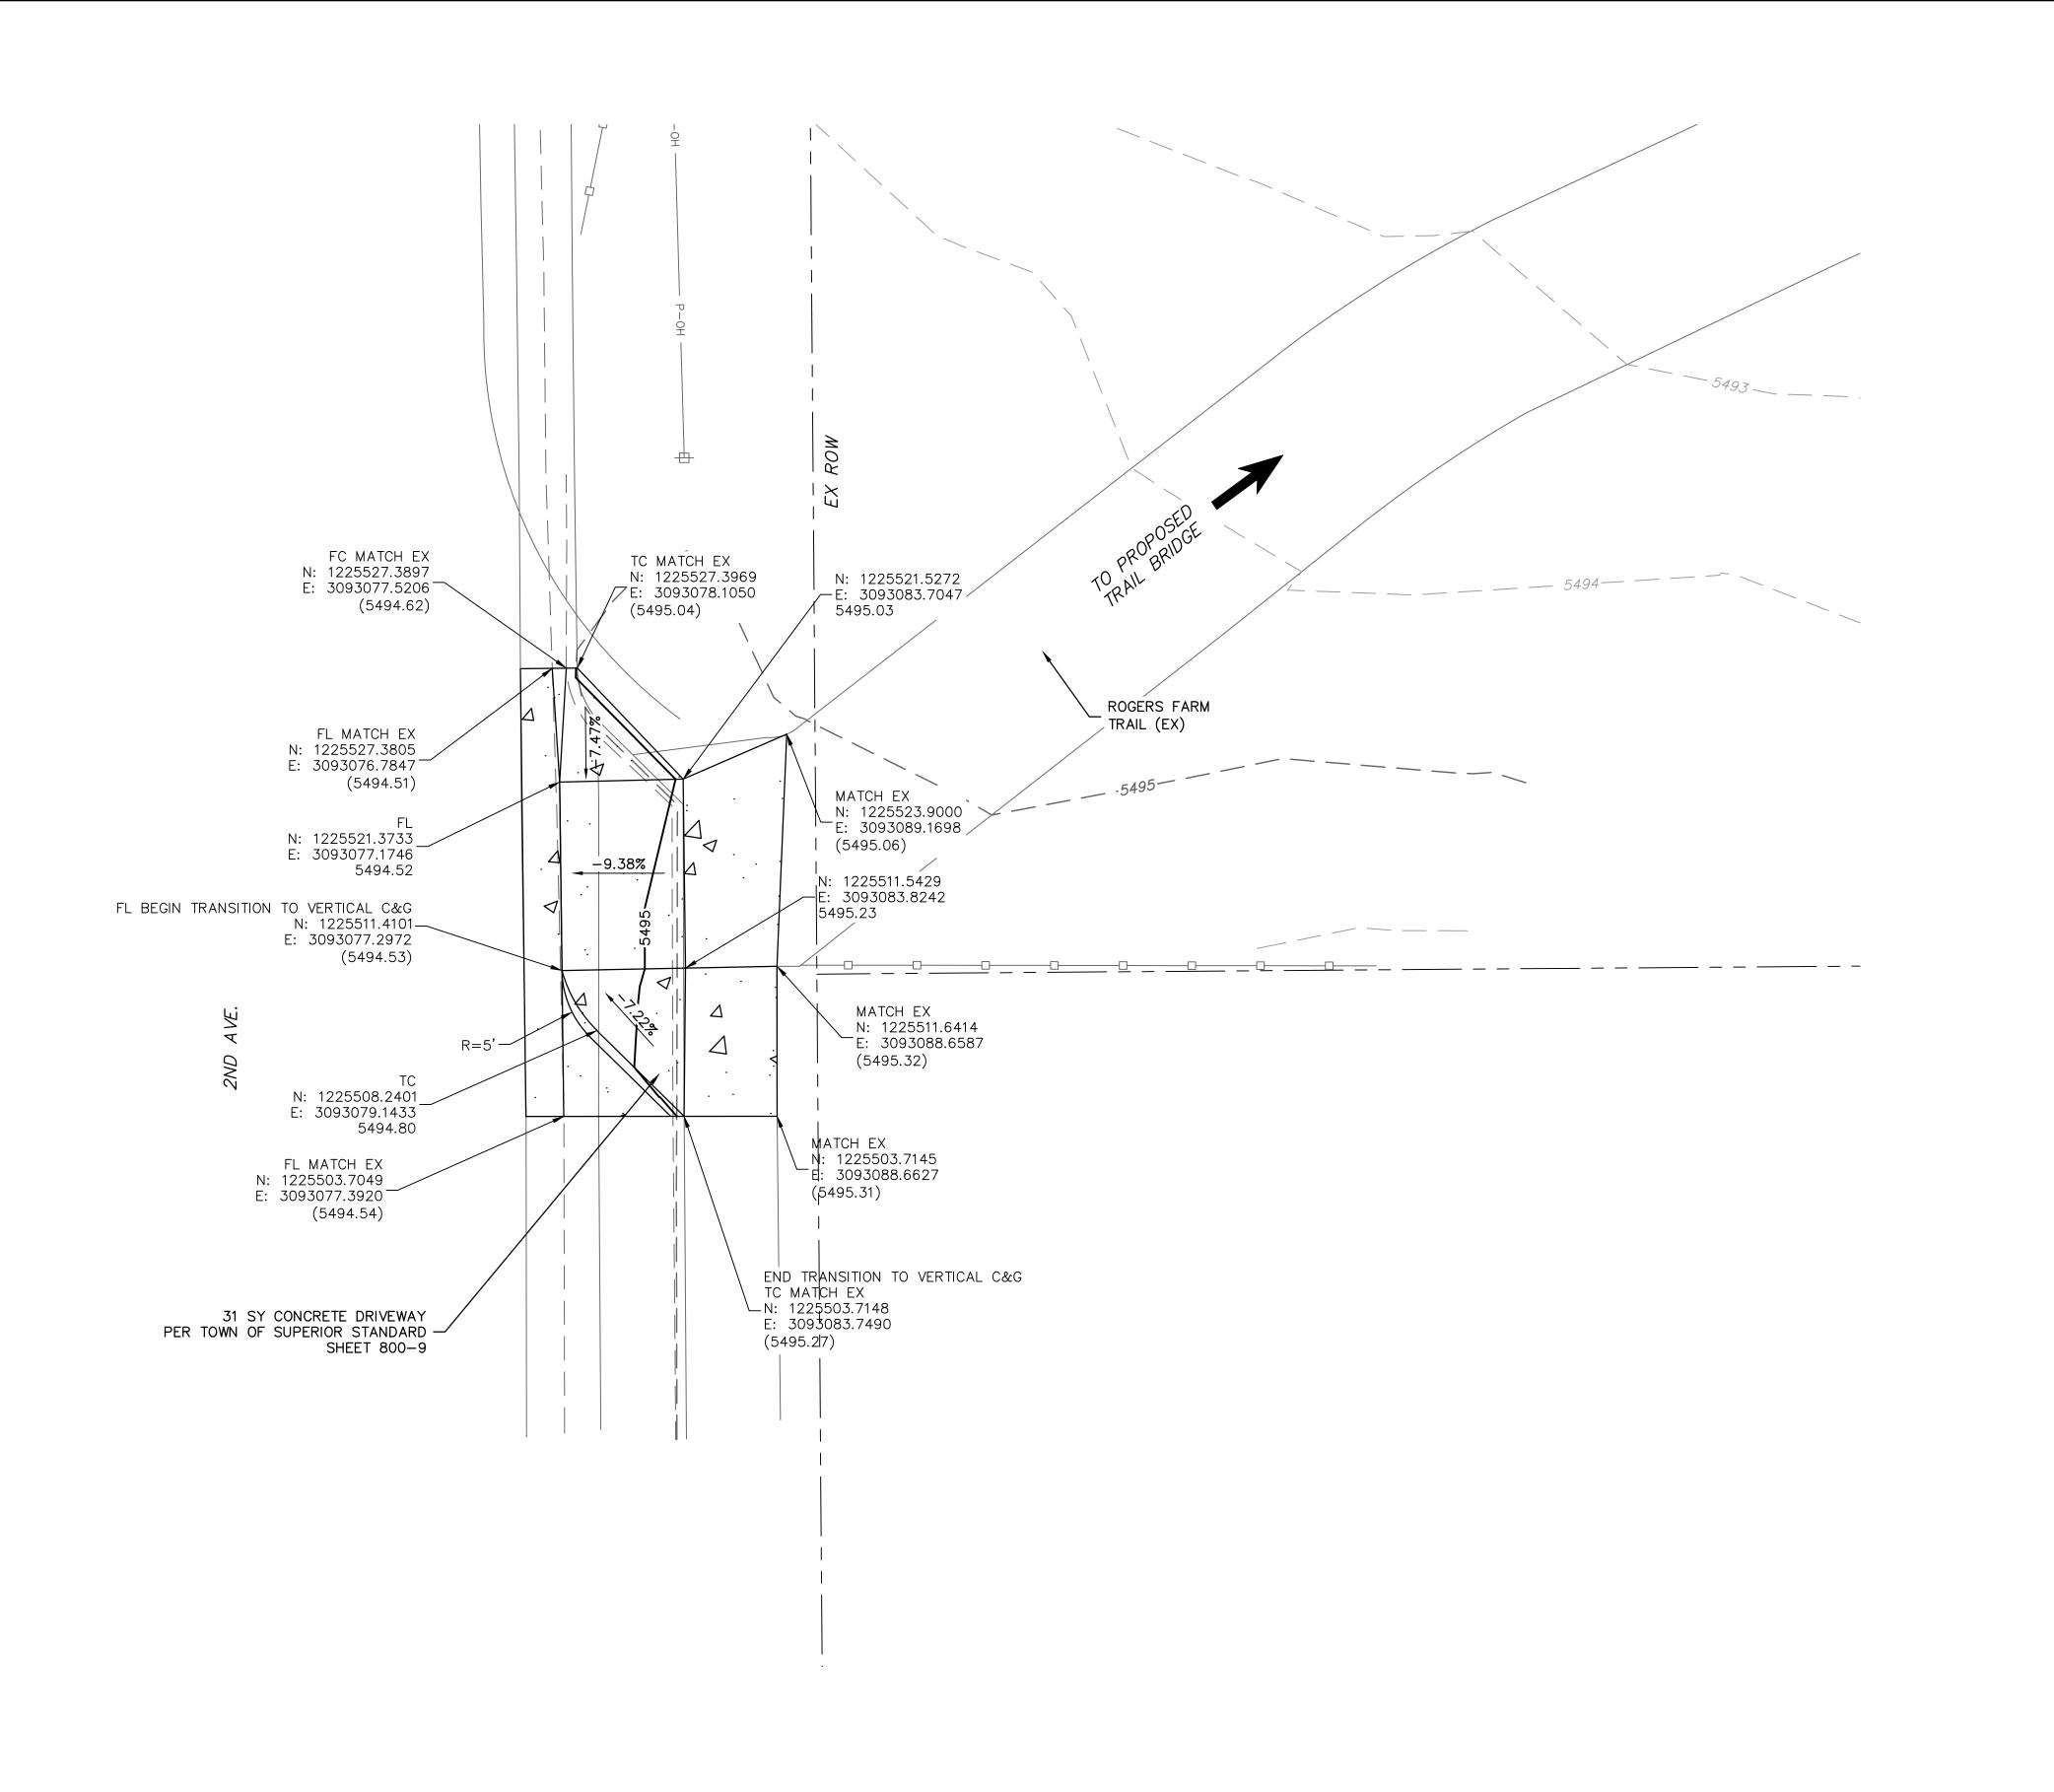

### <u>LEGEND</u>

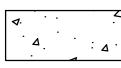

INSTALL CONCRETE PAVEMENT (SEE TOWN OF SUPERIOR STANDARDS SECTION 900)

TC: TOP BACK OF CURB FC: BOTTOM FACE OF CURB FL: FLOWLINE C&G: CURB AND GUTTER (EL= XXXX.XX) : EXISTING ELEVATION

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	<u>}</u> 8	DATE	REVISIONS DESCRIPTION
	-	2023.11.16	2023.11.16 TOWN ALLEY IMPROVEMENTS PLAN
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	۲۸D	
PLAN	CCASLIN B	
EWAY DETAIL PLAN	VENUE TO MCCASLIN BLVD - DESIGN	

2ND AV FINAL . CREEK

drawn by: checked by: approved by: QA/QC by: project no.: 021-00854 drawing no.: T SIT.DWG


date: \_\_\_\_\_ 11.20.2023 SHEET 12 of 23


100% DESIGN NOT TO BE USED FOR CONSTRUCTION


> November 20, 2023 DATE PRINTED OLSSON


CENTER OF COLORADO CALL 3-BUSINESS DAYS IN ADVANCE BEFORE YOU DIG, GRADE, OR EXCAVATE FOR THE MARKING OF UNDERGROUND MEMBER UTILITIES.

CALL UTILITY NOTIFICATION

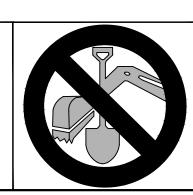

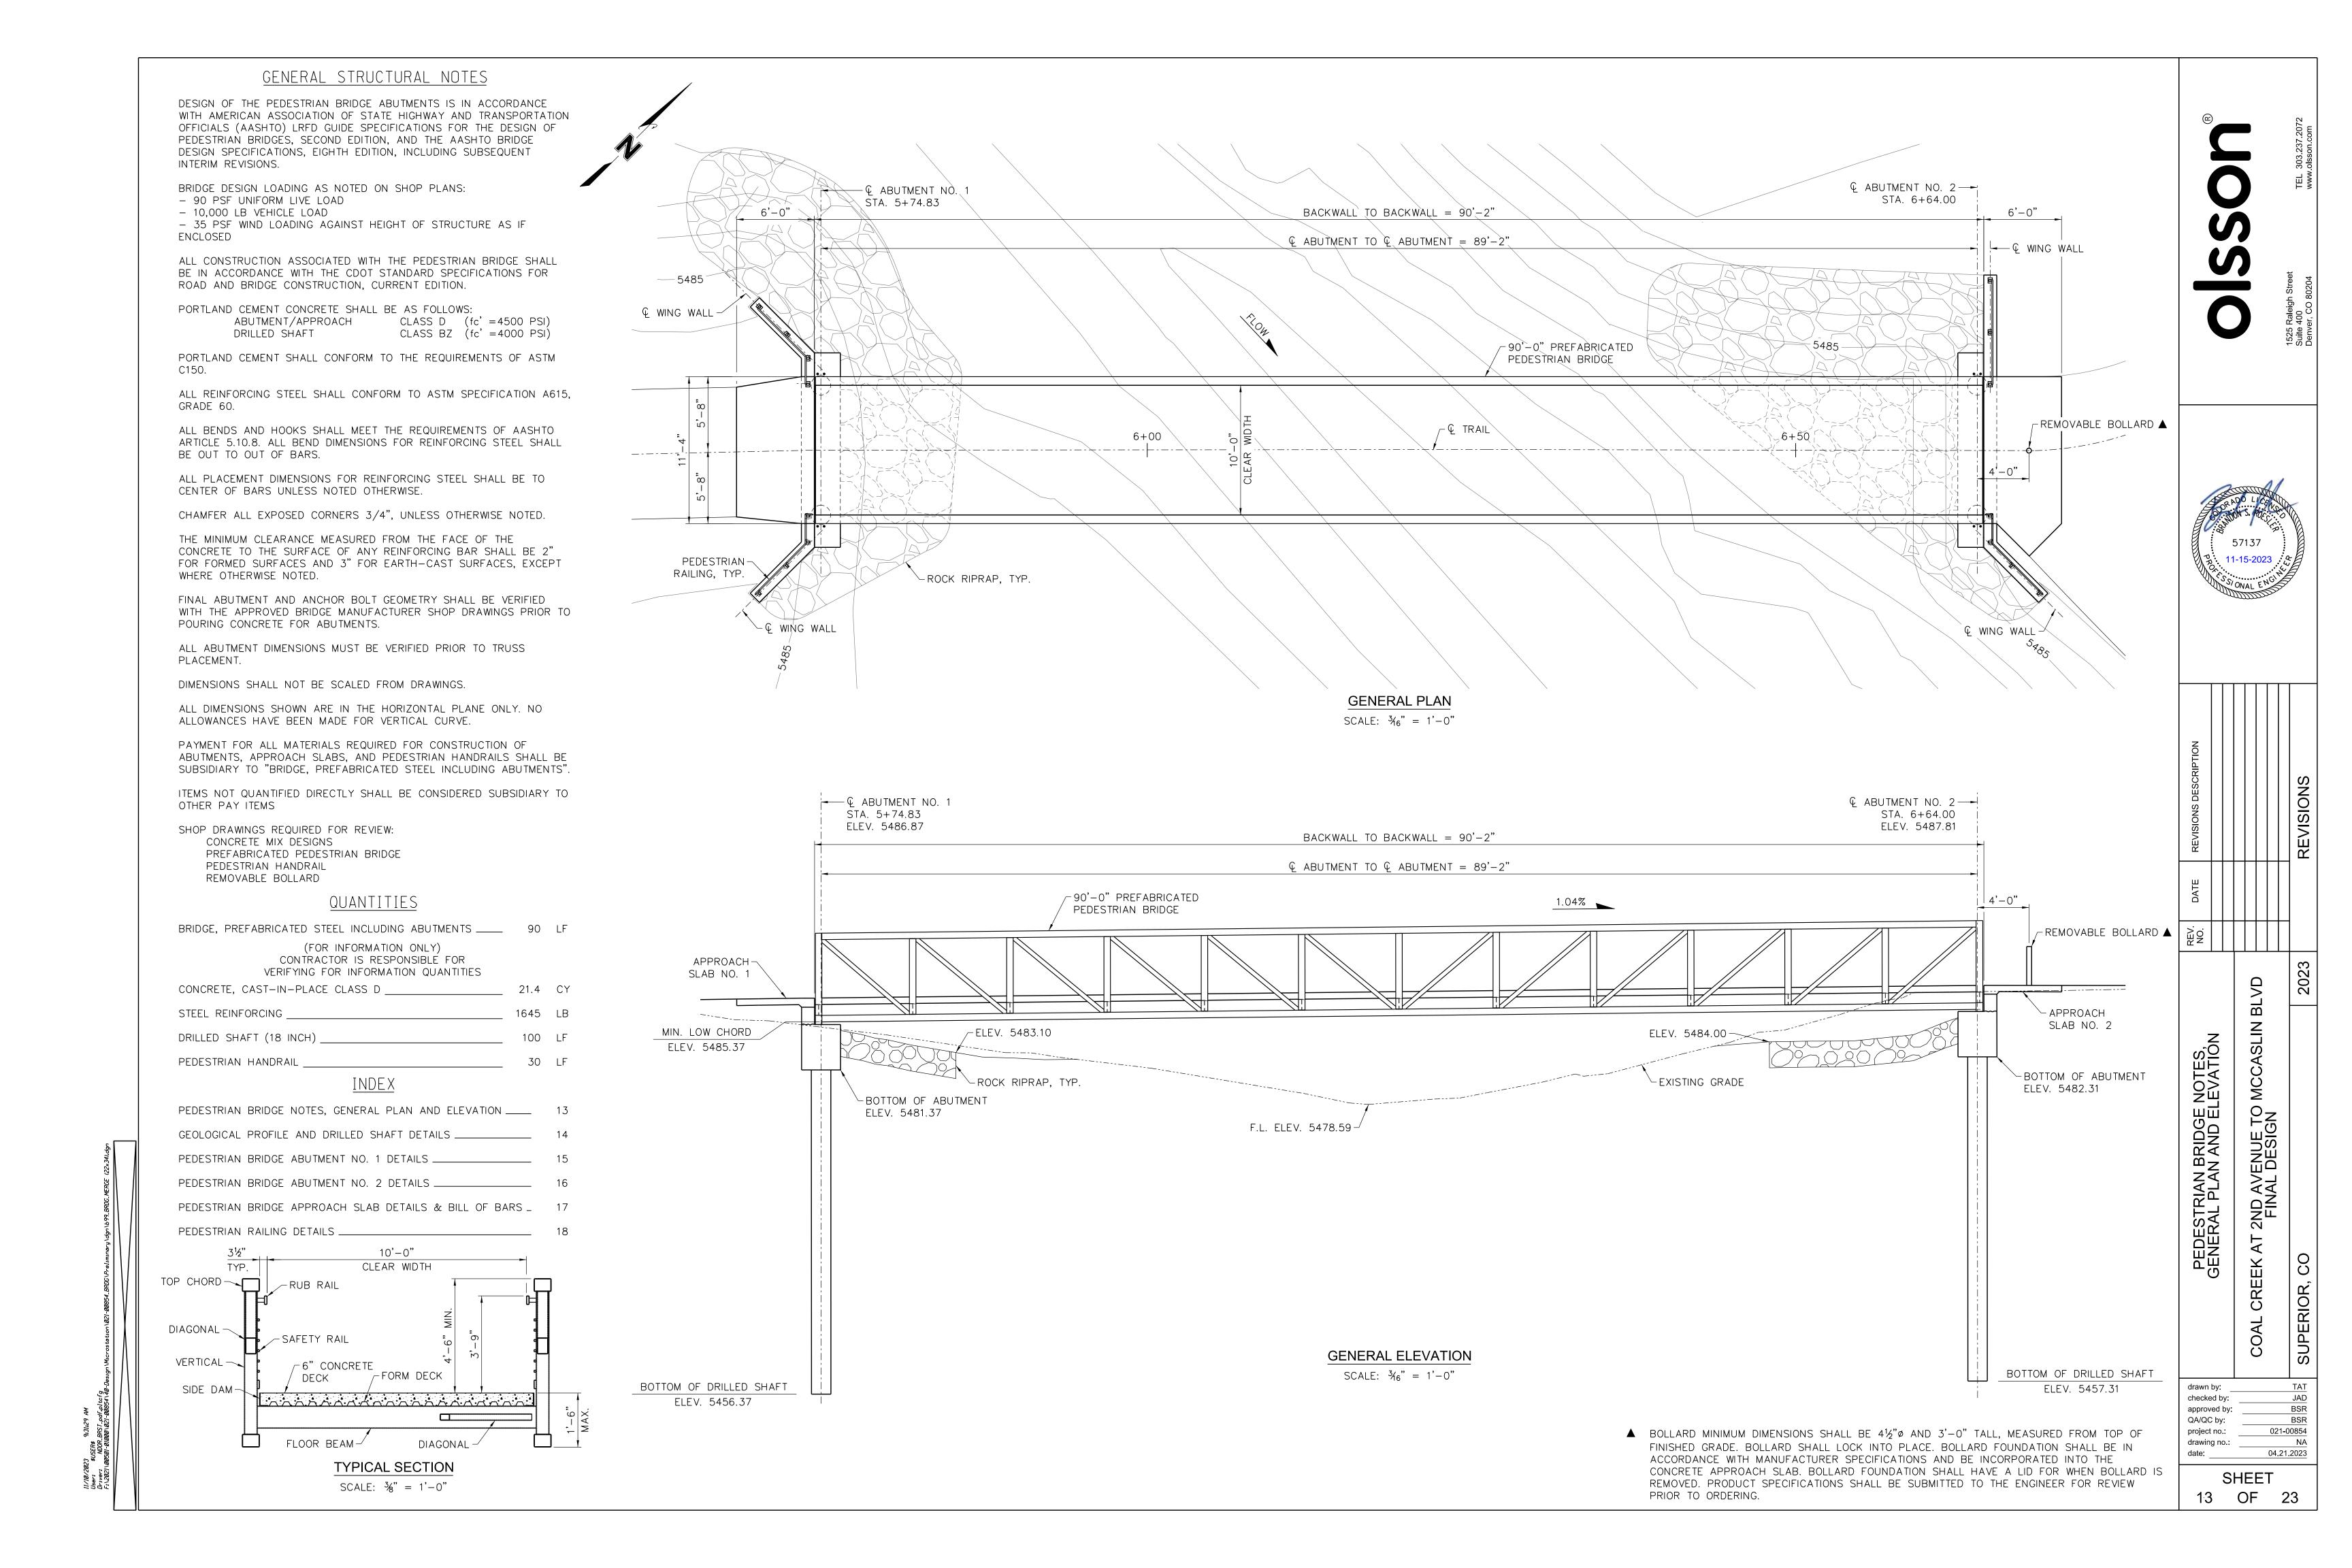

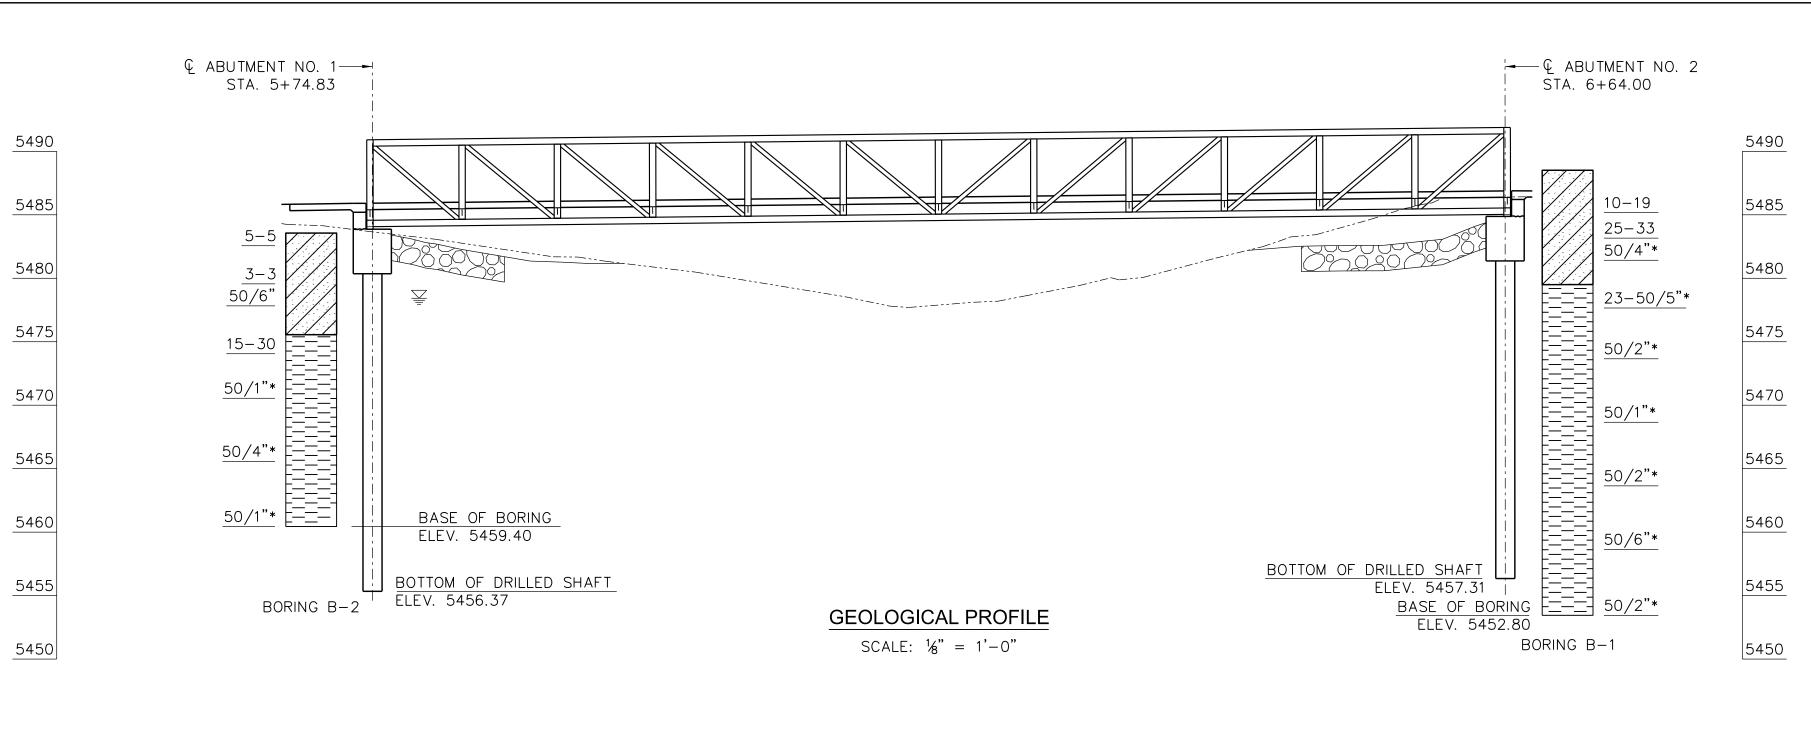

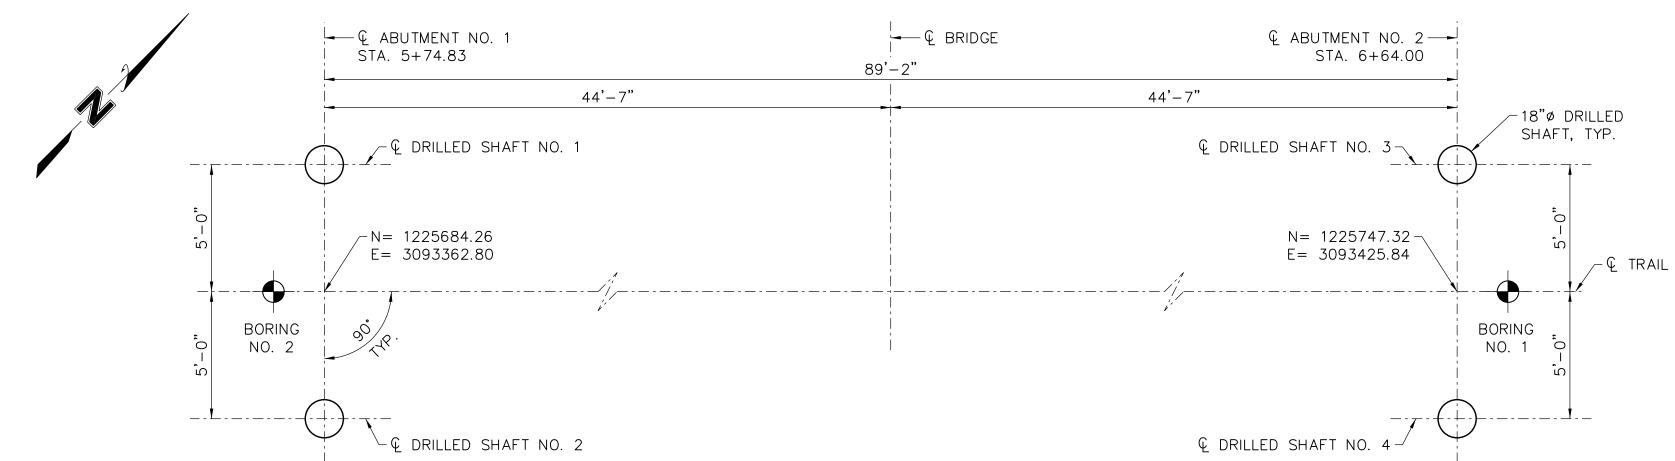

#### DRILLED SHAFT LAYOUT

SCALE:  $\frac{1}{4}$ " = 1'-0"

DRILLED SHAFT NOTES

DRILLED SHAFT CONSTRUCTION SHALL BE IN ACCORDANCE WITH RECOMMENDATIONS IN GEOTECHNICAL ENGINEERING

SPLICING OF VERTICAL BARS WILL NOT BE ALLOWED WITHOUT PRIOR APPROVAL FROM THE ENGINEER.

TOP OF DRILLED CAISSONS SHALL BE WITHING 2" OF PLAN AND SHALL NOT DEVIATE MORE THAN 1" IN 10'-0" FROM

CONTRACTOR SHALL BE RESPONSIBLE FOR PROVIDING SUPPORT FOR REINFORCING STEEL CAGES DURING FABRICATION, ERECTION AND CONCRETE PLACEMENT. PLANS SHOWING REINFORCING CAGE SUPPORT AND METHODS OF ERECTION SHALL BE SUBMITTED TO THE ENGINEER FOR REVIEW AND APPROVAL PRIOR TO CONSTRUCTION.

DRILLED SHAFT EXCAVATIONS SHALL BE COMPLETED WITH SINGLE FLIGHT AUGER, ROCK AUGER, OR BUCKET AUGER BITS TO THE SPECIFIED TIP ELEVATION.

AFTER EXCAVATION AND CLEANING, NO MORE THAN 1/2" OF LOOSE MATERIAL SHALL REMAIN ACROSS 50% OF THE DRILLED SHAFT BASE.

CONCRETE SHOULD BE AVAILABLE ON THE SITE AT THE TIME OF DRILLING SO THAT SHAFT HOLES CAN BE FILLED WITH CONCRETE IMMEDIATELY UPON COMPLETION OF DRILLING, CLEANING AND INSPECTION.

DRILLED SHAFT SHALL HAVE A MINIMUM OF 20'-0" PENETRATION BELOW LOWEST ADJACENT FINAL GRADE.

A REPRESENTATIVE OF THE GEOTECHNICAL ENGINEER SHALL BE ON SITE FOR DRILLED SHAFT INSTALLATION.


CONCRETE SHALL BE PLACED USING A BOTTOM HOPPER OR TREMIE PIPE TO PREVENT POTENTIAL AGGREGATE SEGREGATION OR SIDEWALL DISTURBANCE. A MINIMUM EMBEDMENT DEPTH OF 5 FT SHOULD BE MAINTAINED IF A TREMIE PIPE IS USED TO PLACE CONCRETE.

THE ANTICIPATED SUBSURFACE CONDITIONS AND DEPTHS WHERE SATISFACTORY BEARING MATERIAL MAY BE ENCOUNTERED ARE INDICATED. HOWEVER, NO WARRANTY OF SUBSURFACE CONDITIONS AND DEPTHS WHERE SATISFACTORY BEARING MATERIAL MAY BE ENCOUNTERED SHALL BE INFERRED. THE BOTTOM ELEVATION OF ANY SHAFT MAY BE RAISED OR LOWERED FROM THAT SHOWN ON THE PROJECT PLANS AND ORDERED BY THE ENGINEER. IF ANY SHAFT IS DEEPENED, THE REINFORCEMENT BARS SHALL BE EXTENDED ACCORDINGLY, AS DIRECTED BY THE ENGINEER.


ABUTMENTS TO BE SUPPORTED ON CAST-IN-PLACE CONCRETE DRILLED SHAFTS WITH A MINIMUM BEARING CAPACITY OF 91 KIPS.

DESIGN BEARING INCLUDES END BEARING AND SIDE FRICTION IN ALL LAYERS.

GRANULAR SOILS WERE ENCOUNTERED ON THE PROJECT SITE THAT ARE PRONE TO CAVING AND SLOUGHING. THE USE OF A TEMPORARY CASING MAY BE REQUIRED TO MAINTAIN BOREHOLE STABILITY.

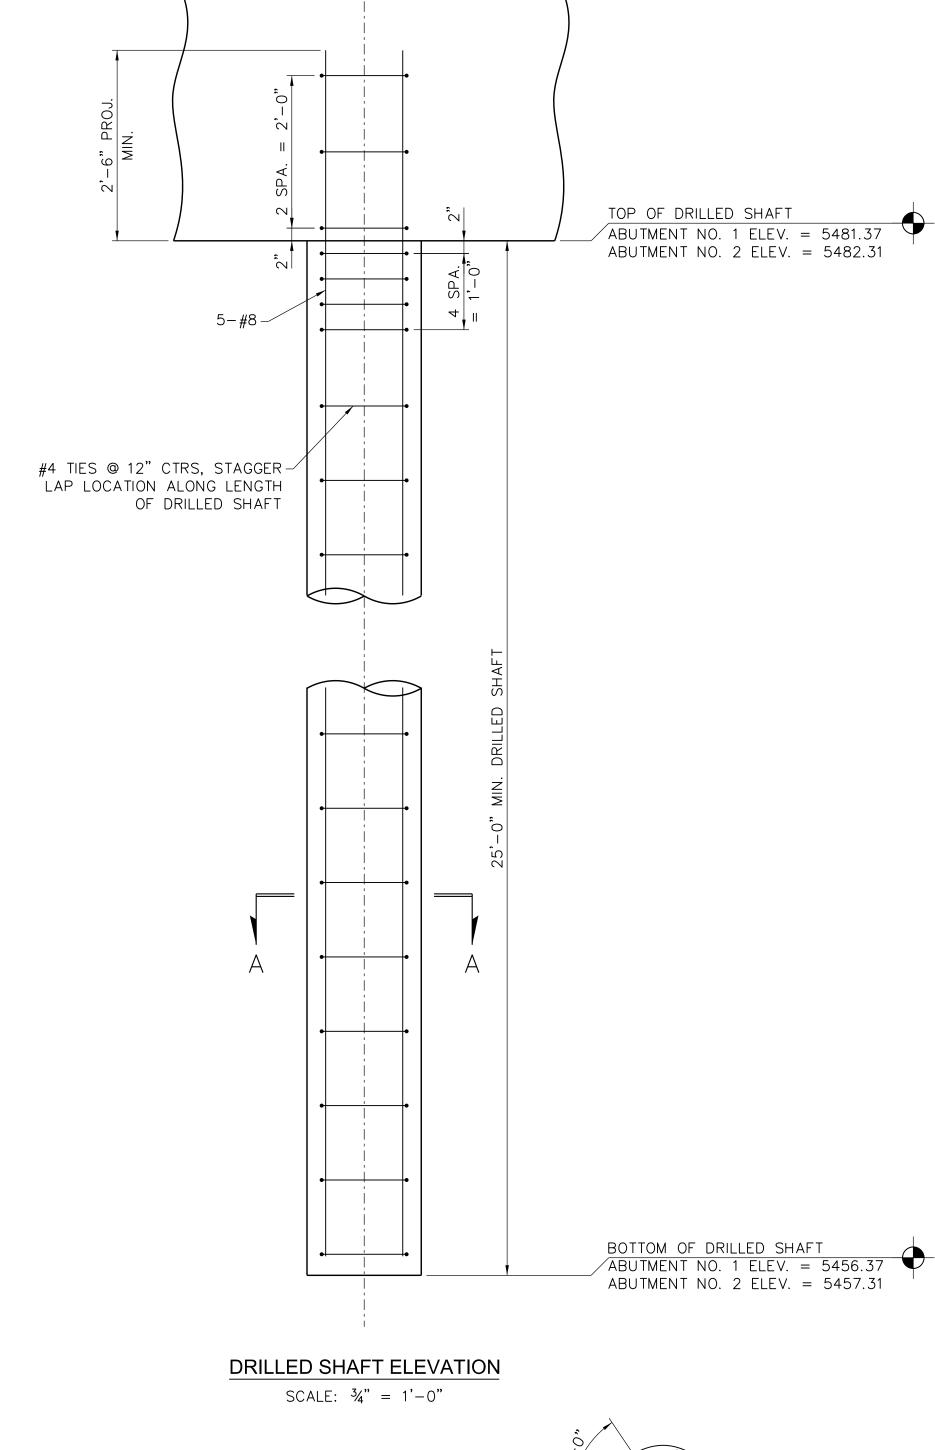

€ DRILLED SHAFT --

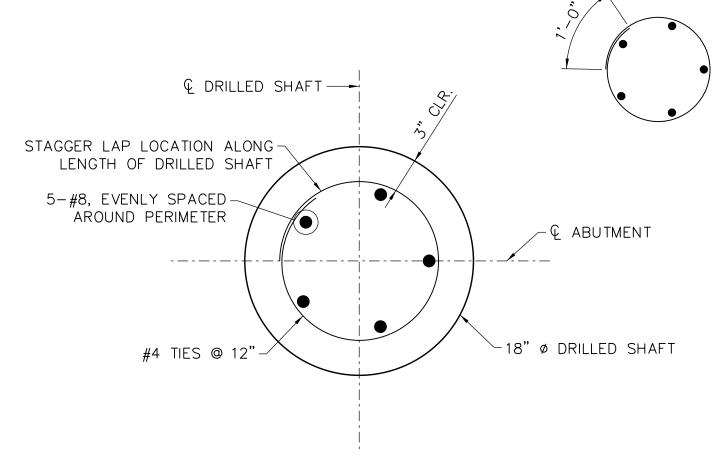

**SECTION A-A** SCALE:  $1\frac{1}{2}$ " = 1'-0"



DE DRILL AND

checked by: approved by: QA/QC by: 021-00854 project no...

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04.21.2023

CLAYSTONE

ACCORDANCE WITH ASTM D1586 PROCEDURES.

LOCATION.

SAND

SUBSOIL AT THE LOCATION INDICATED. NO GUARANTEE IS MADE THAT THE

SUBSOIL CONDITIONS VARY UNIFORMLY BETWEEN OR OUTSIDE THE GIVEN

THE BORINGS, AS LOGGED ON THE PLANS, REPERESENT THE CHARACTER OF THE

NUMBERS BESIDE THE BORINGS INDICATE THE NUMBER OF BLOWS REQUIRED TO


DRIVE A STANDARD PENETROMETER, OF 2" O.D. THE SECOND AND THIRD 6"


UNLESS OTHERWISE NOTED, USING A 140 LB HAMMER FALLING 30 INCHES IN


\* INDICATES MAXIMUM NUMBER OF BLOWS WAS ACHIEVED WITHOUT 6" MOVEMENT.

OPERATIONS. NOTE THAT NO WATER WAS ENCOUNTERED AT BORING HOLE NO. 1

¥ INDICATES ELEVATION AT WHICH WATER WAS ENCOUNTERED DURING DRILLING

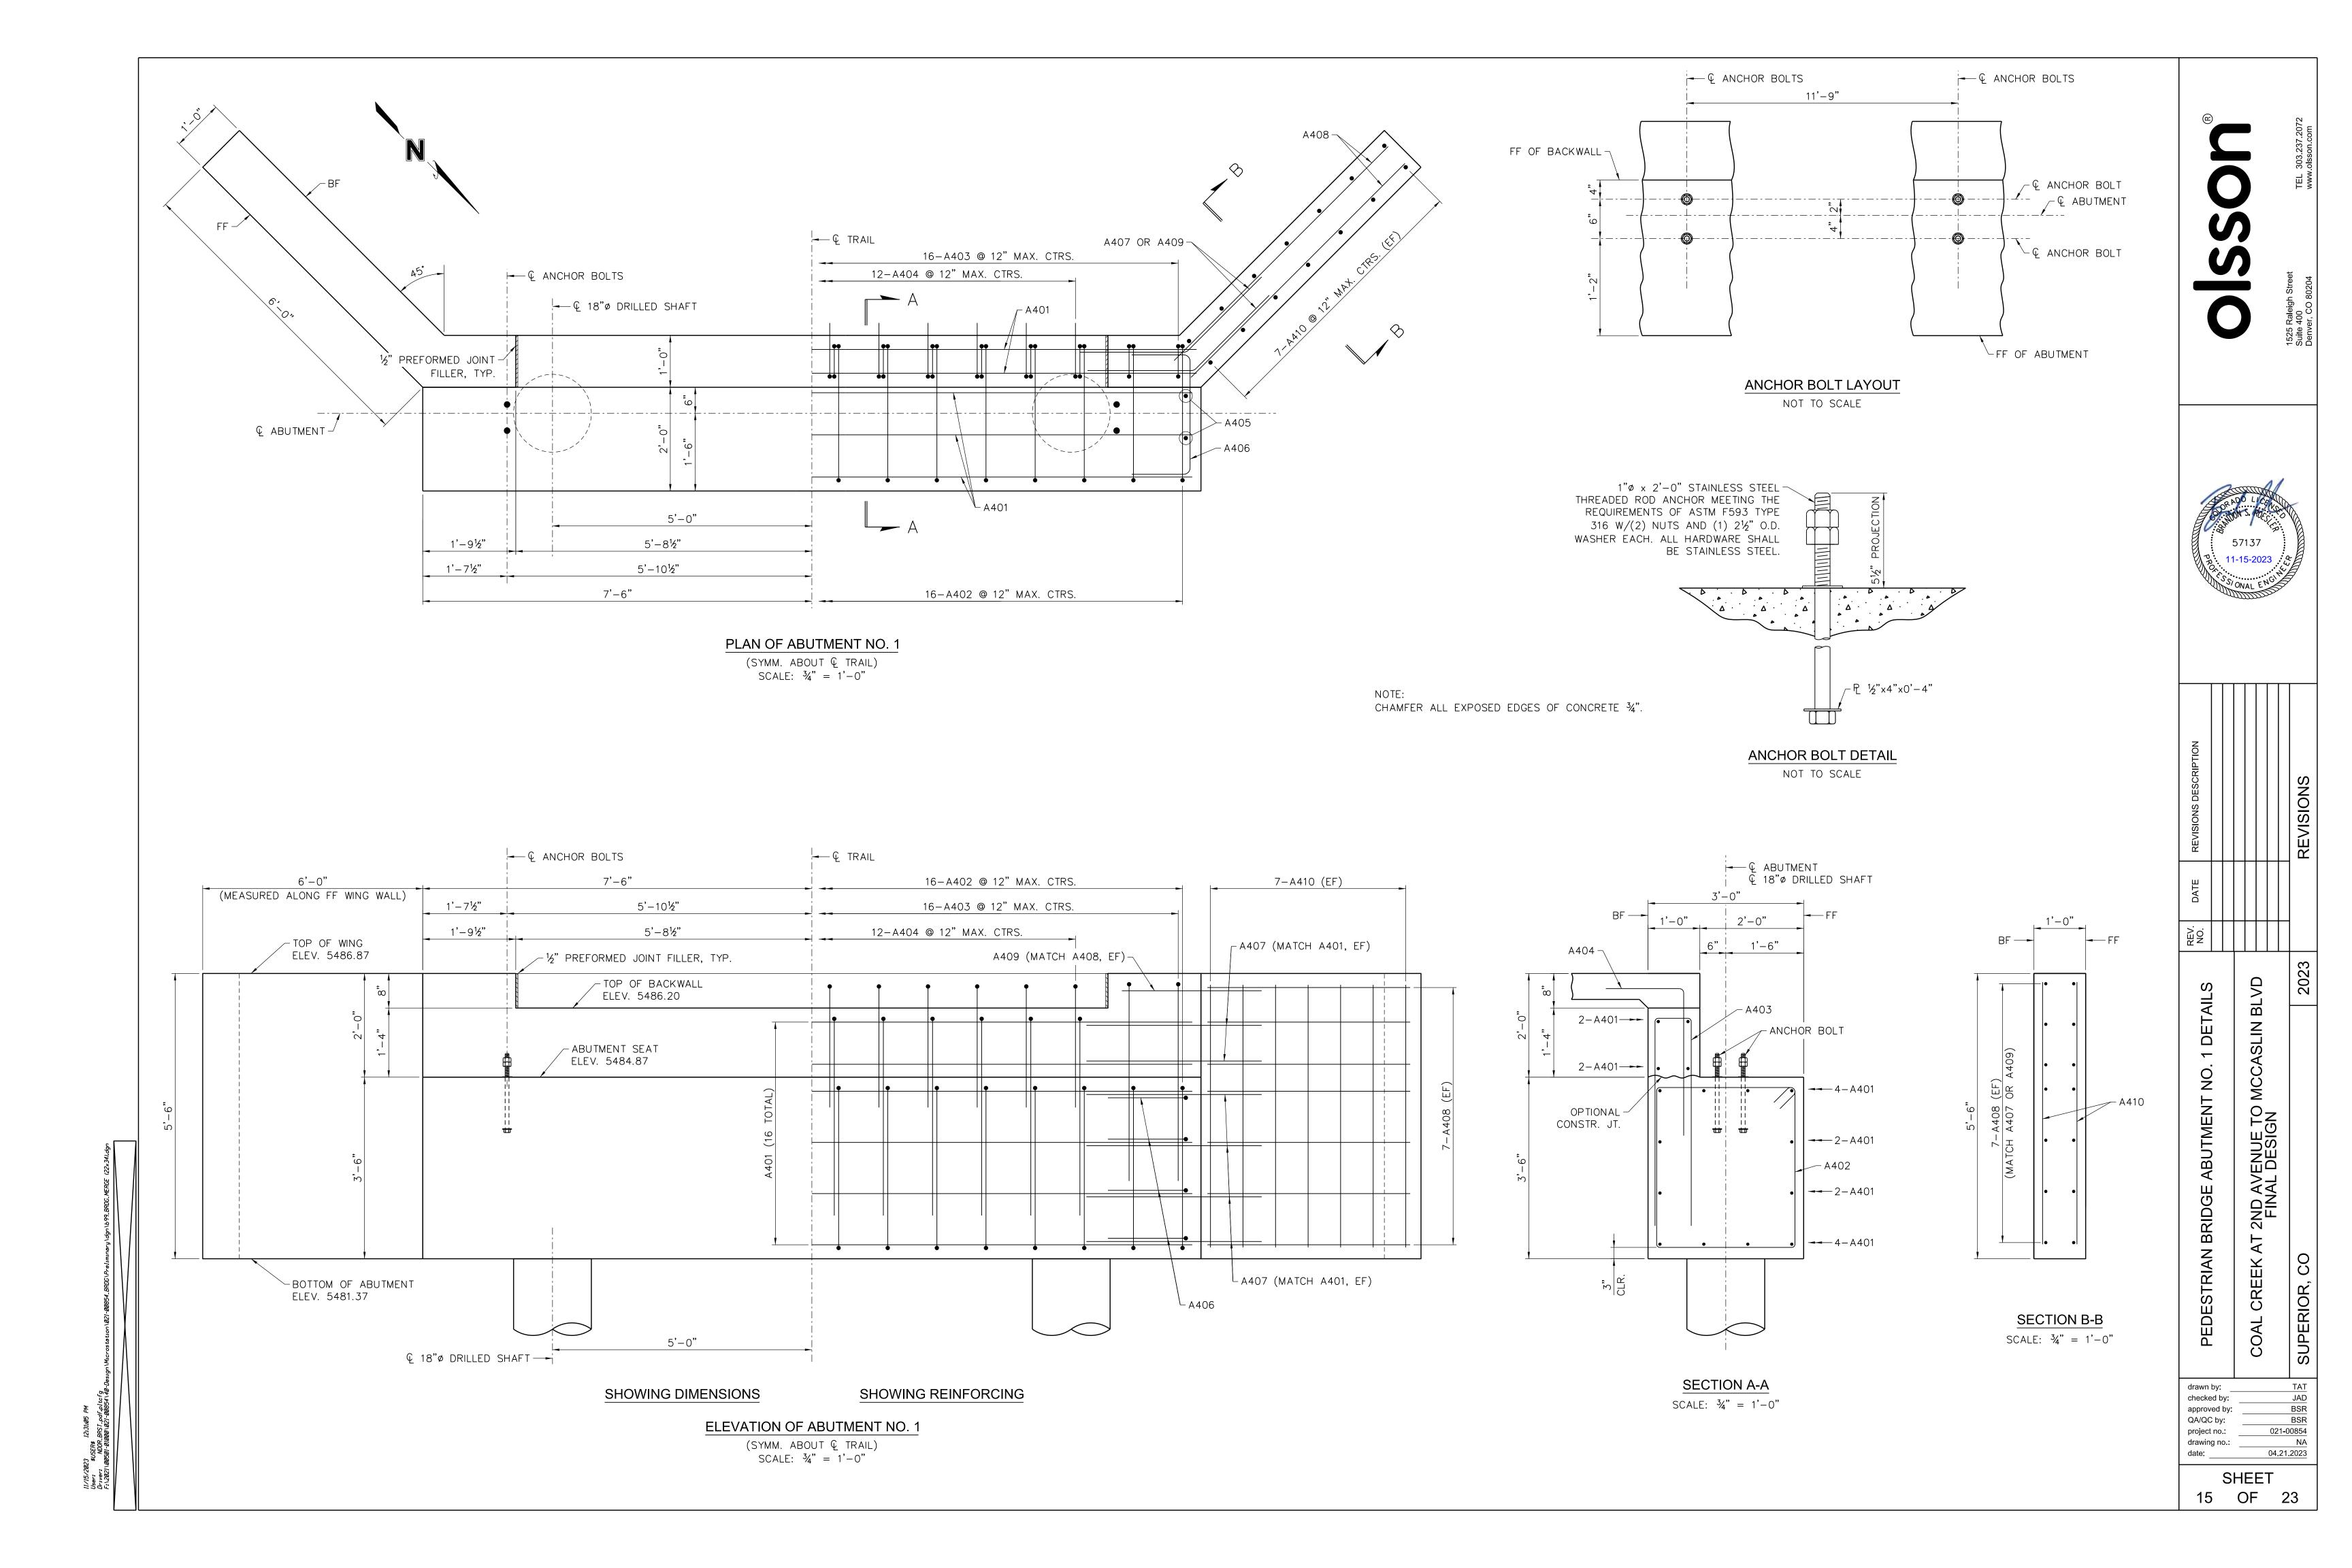

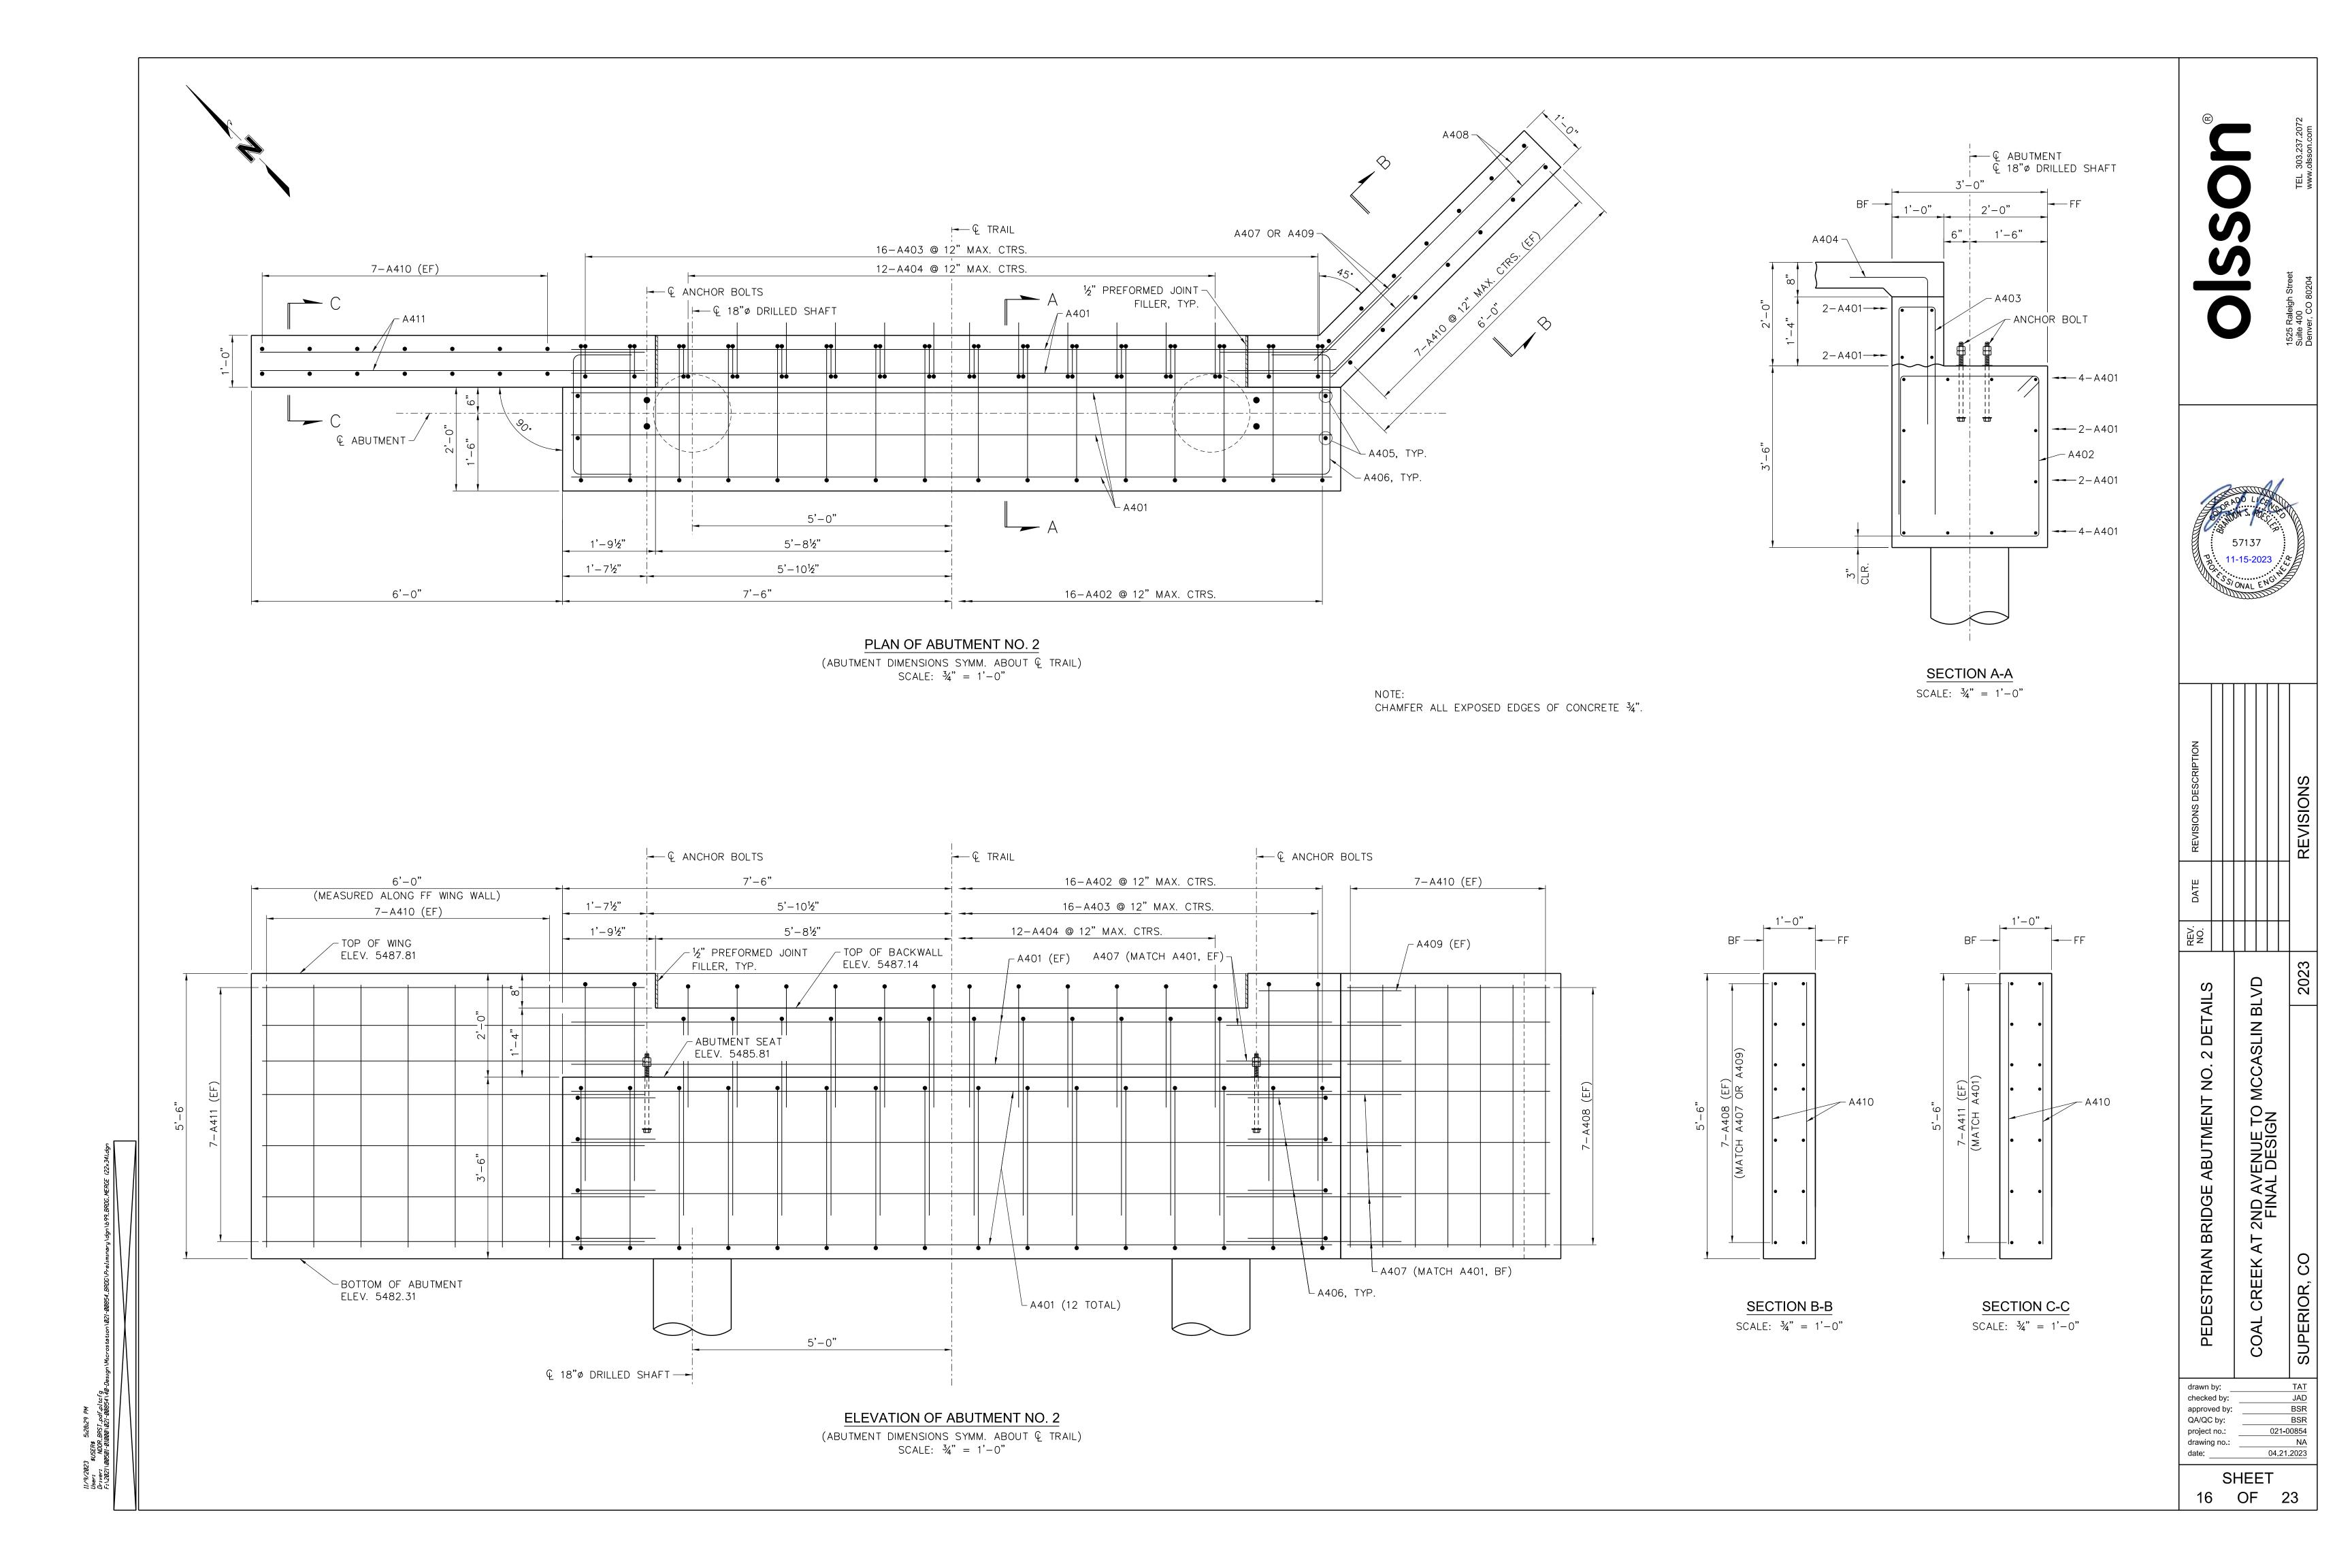


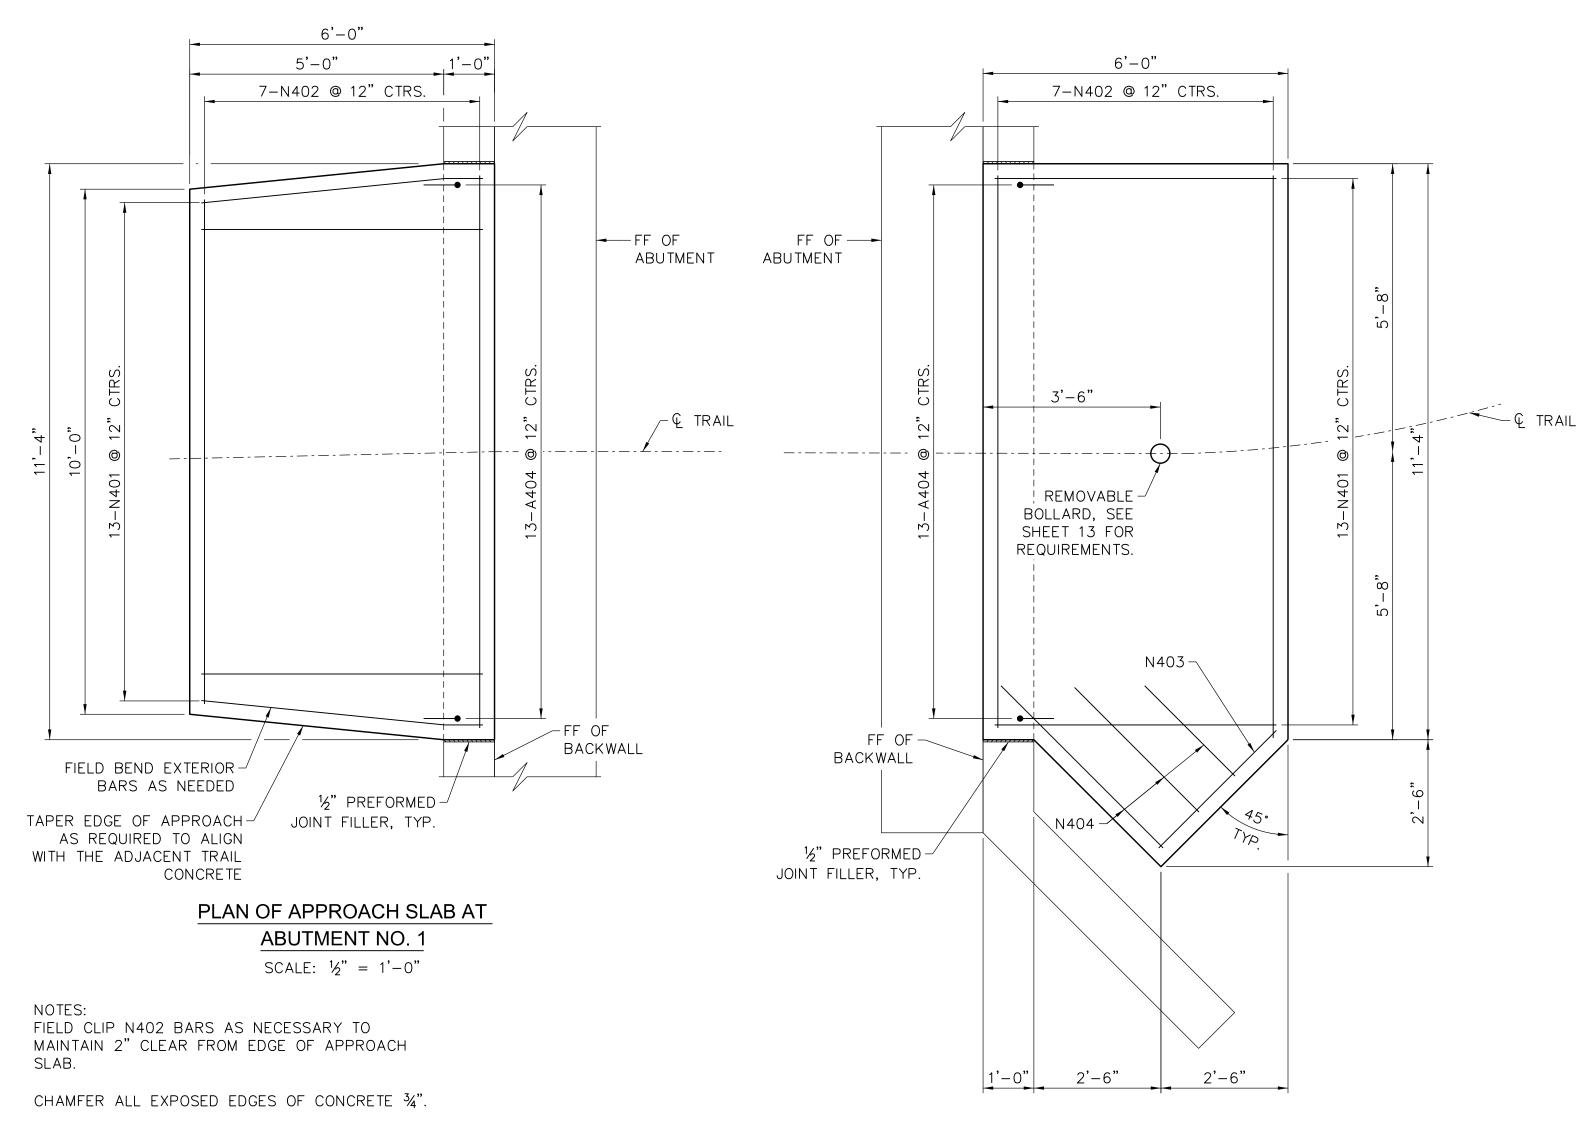

PLAN OF APPROACH SLAB AT

ABUTMENT NO. 2


SCALE: ½" = 1'-0"

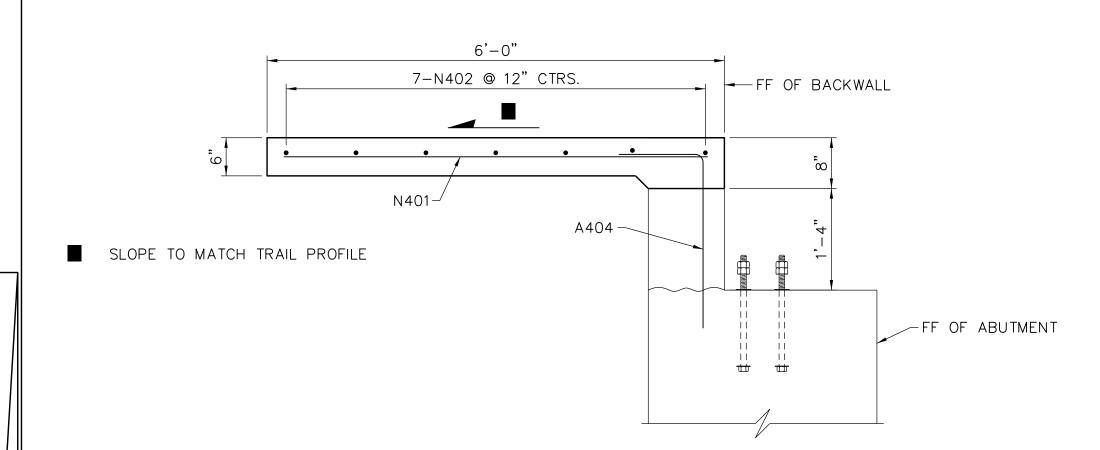


TYPICAL SECTION OF APPROACH SLABS

SCALE: ½" = 1'-0"

ABUTMENT NO. 1	MARK		LENGTH	TYPE	"A"	"B"	"C"	"D"	"E"	"F"	PIN	HOOK -	WEIGHT
		NO.											LB
	A401	16	14'-8"	STR									157 LE
	A402	16	12'-3"	107	3'-1"	2'-8"					2"	41/2"	131 LE
	A403	16	8'-8"	103	4'-0"	0'-8"	4'-0"				2"		93 LB
	A404	13	4'-4"	104	2'-0"	2'-4"					3"		38 LB
	A405	4	3'-1"	STR									9 LB
	A406	8	6'-8"	103	1'-10"	3'-0"	1'-10"				2"		36 LB
	A407	24	4'-0"	101	2'-0"	2'-0"	1'-5"				3"		65 LB
	A408	28	5'-10"	STR									110 LE
	A409	4	3'-3"	101	1'-3"	2'-0"	1'-3"				3"		9 LB
	A410	28	5'-1"	STR									96 LB
	SUBTOTAL =										TOTAL =	744 LE	
	A401	16	14'-8"	STR									157 LE
$_{N}$	A402	16	12'-3"	107	3'-1"	2'-8"					2"	41/2"	131 LE
[	A403	16	8'-8"	103	4'-0"	0'-8"	4'-0"				2"		93 LB
2 Z	A404	13	4'-4"	104	2'-0"	2'-4"					3"		38 LB
	A405	4	3'-1"	STR									9 LB
	A406	8	6'-8"	103	1'-10"	3'-0"	1'-10"				2"		36 LB
TME	A408	14	5'-10"	STR									55 LB
ABU	A410	28	5'-10"	STR									96 LB
SLAB NO. 1	A411	14	7'-5"	STR									70 LB
	SUBTOTAL =									685 LE			
	N401	13	5'-8"	STR									50 LB
	N402	7	11'-0"	STR									52 LB
											SUB	ΓΟΤΑL =	102 LE
APPROACH SLAB NO. 2	N401	13	5'-8"	STR									50 LB
	N402	7	11'-0"	STR									52 LB
	N403	1	3'-2"	STR									3 LB
	N404	3	3'-6", AVE.	STR									8 LB

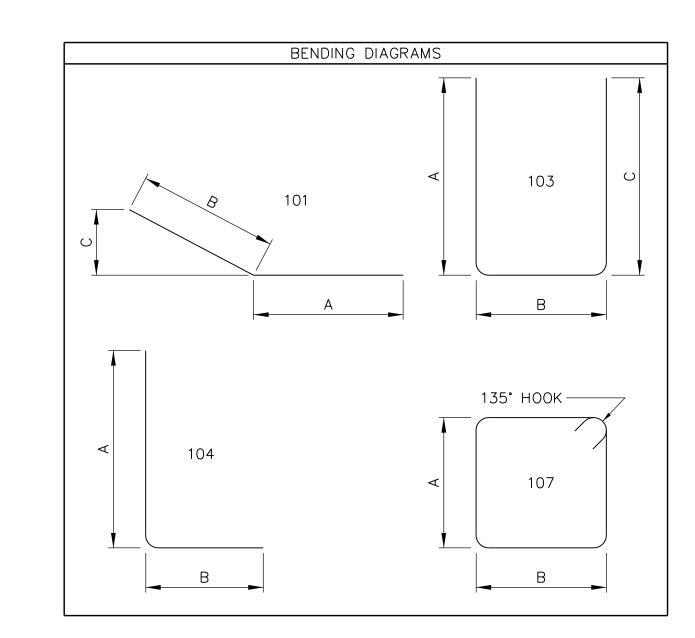

MARK	MAX	MIN	NO.	BARS
	LENGTH	LENGTH	OF SETS	PER SET
N404	4'-6"	2'-6"	1	3

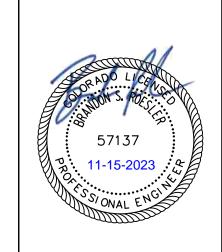

PEDESTRIAN BRIDGE APPROACH SLAB
DETAILS AND BILL OF BARS
CREEK AT 2ND AVENUE TO MCCASLIN BLVD
FINAL DESIGN
30R, CO
REVISIONS DESCRIPTION
FINAL DESIGN
2023
REVISIONS
FINAL DESIGN
2023
REVISIONS

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 drawn by:
 TAT

 checked by:
 JAD

 approved by:
 BSR


 QA/QC by:
 BSR


 project no.:
 021-00854

 drawing no.:
 NA

 date:
 04.21.2023

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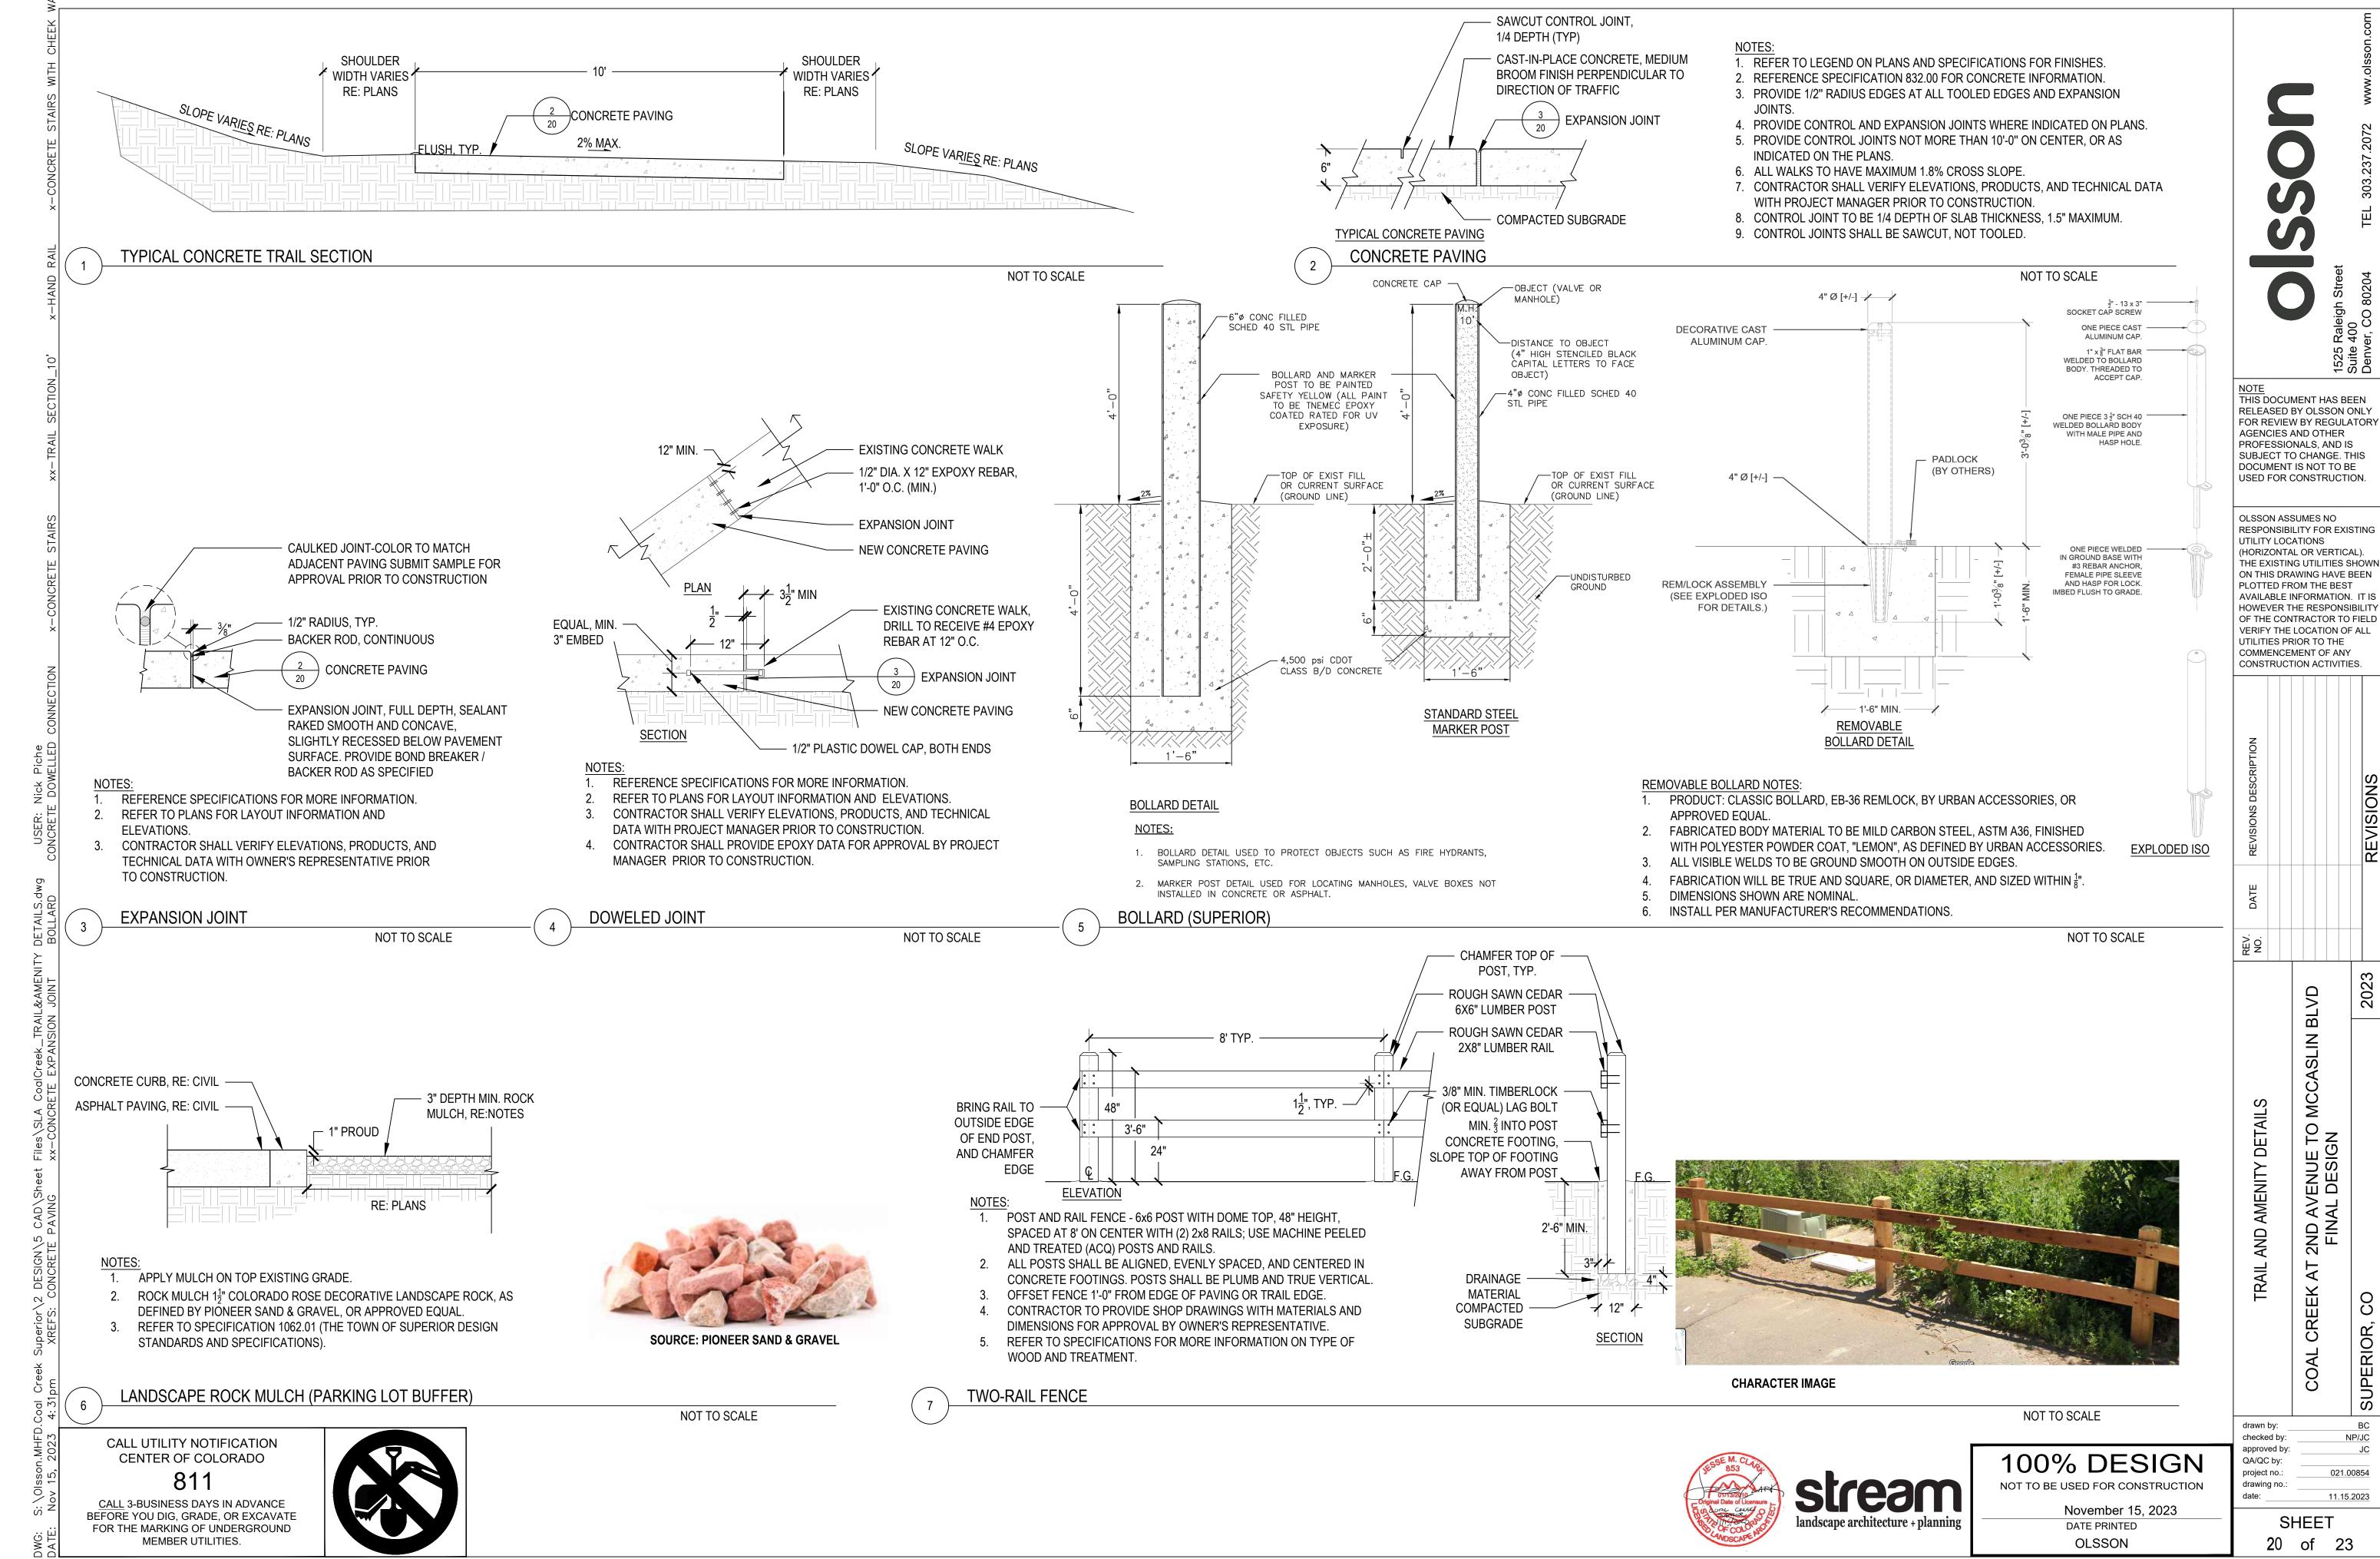


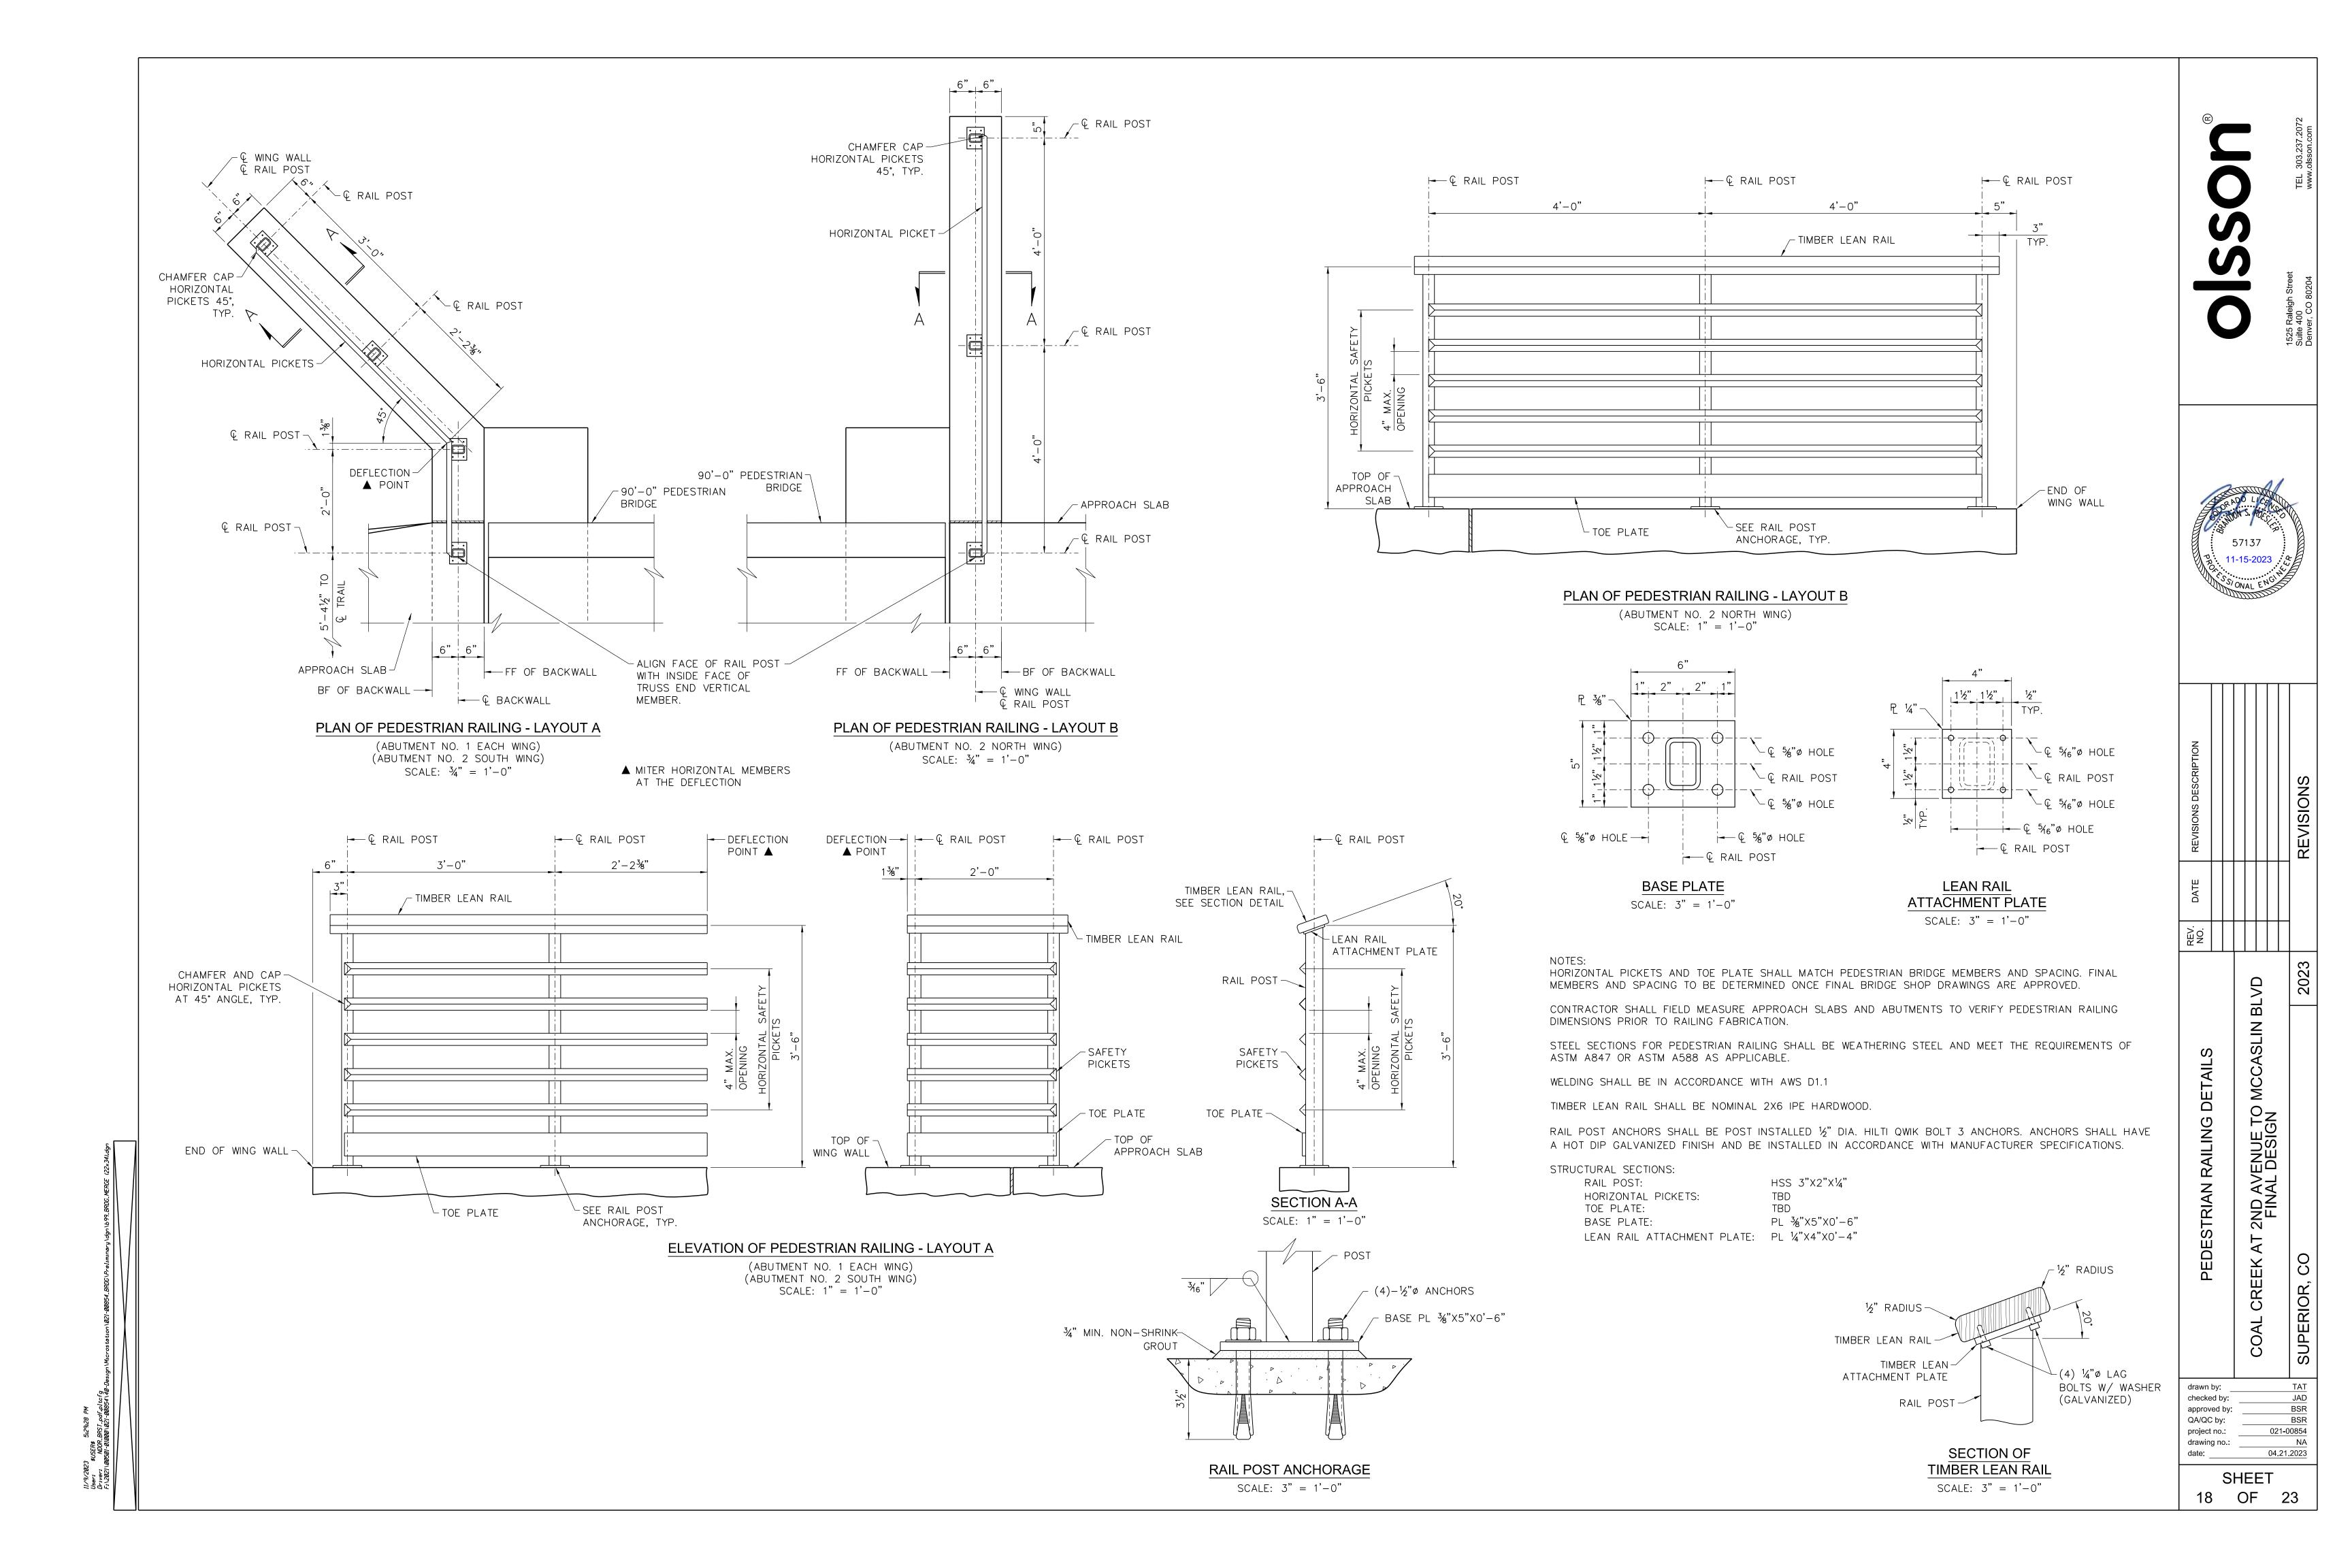

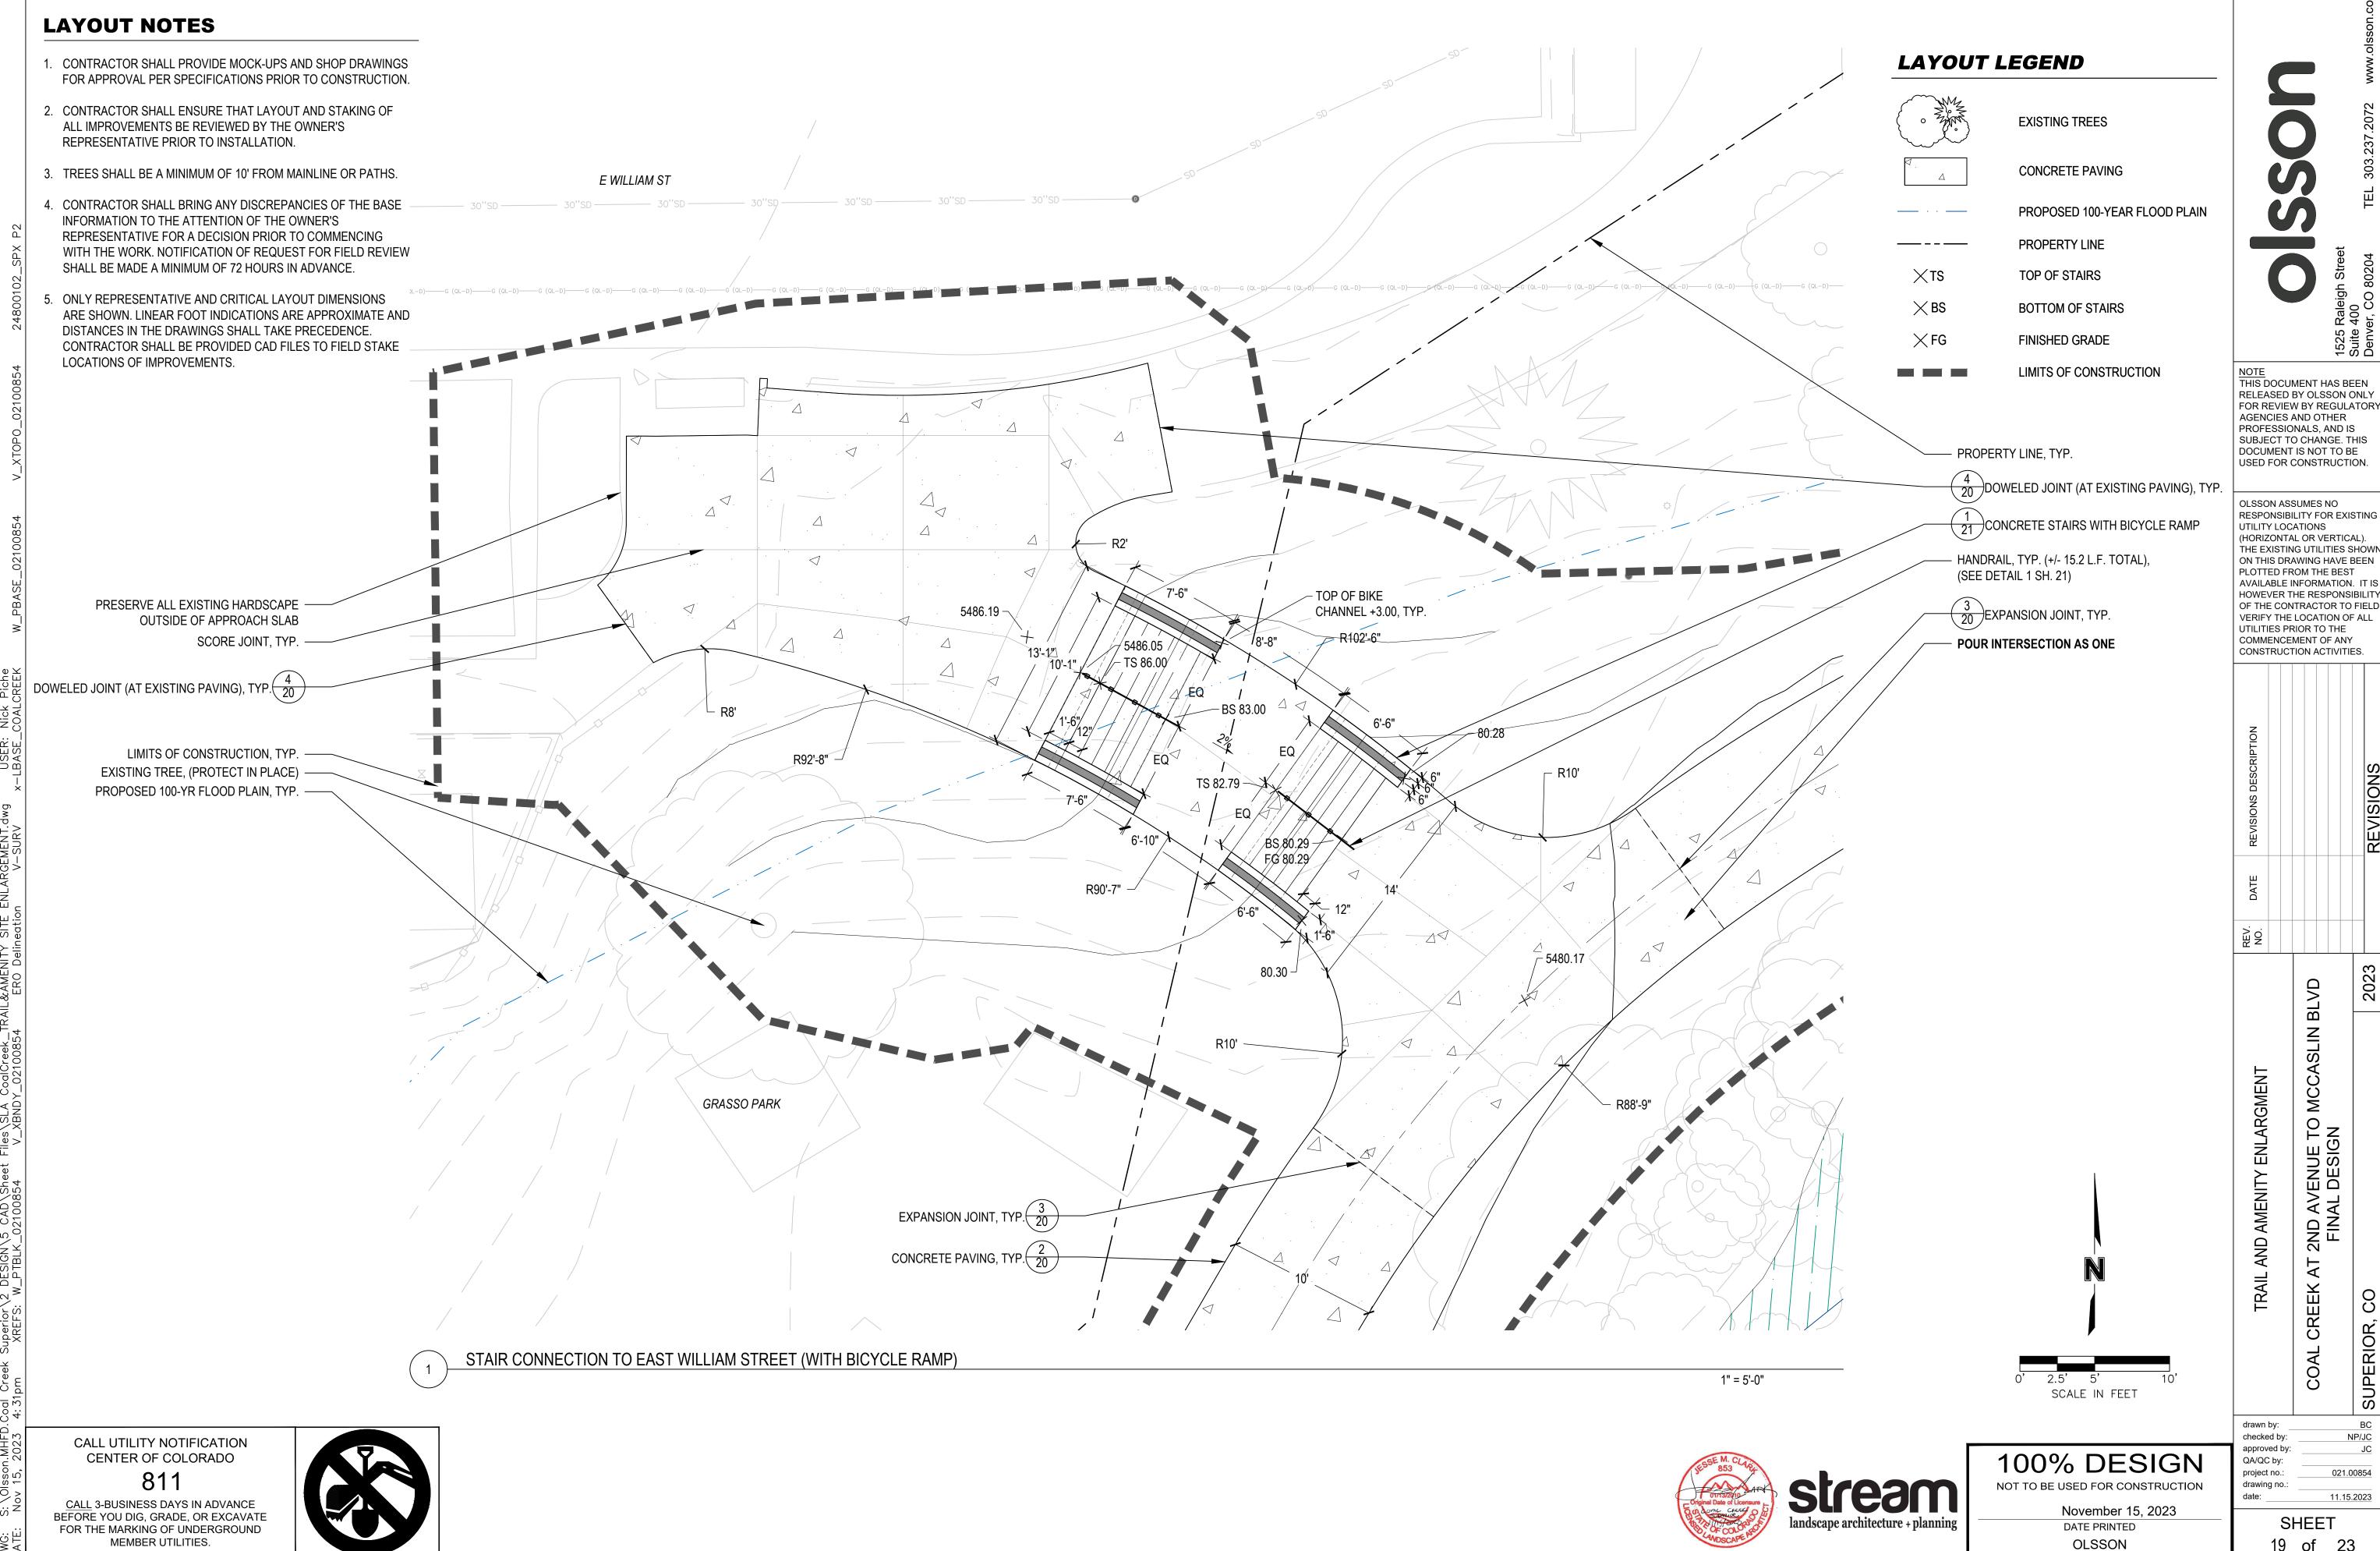
FOR REVIEW BY REGULATORY


RESPONSIBILITY FOR EXISTING (HORIZONTAL OR VERTICAL). THE EXISTING UTILITIES SHOWN ON THIS DRAWING HAVE BEEN AVAILABLE INFORMATION. IT IS HOWEVER THE RESPONSIBILITY OF THE CONTRACTOR TO FIELD VERIFY THE LOCATION OF ALL

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NP/JC



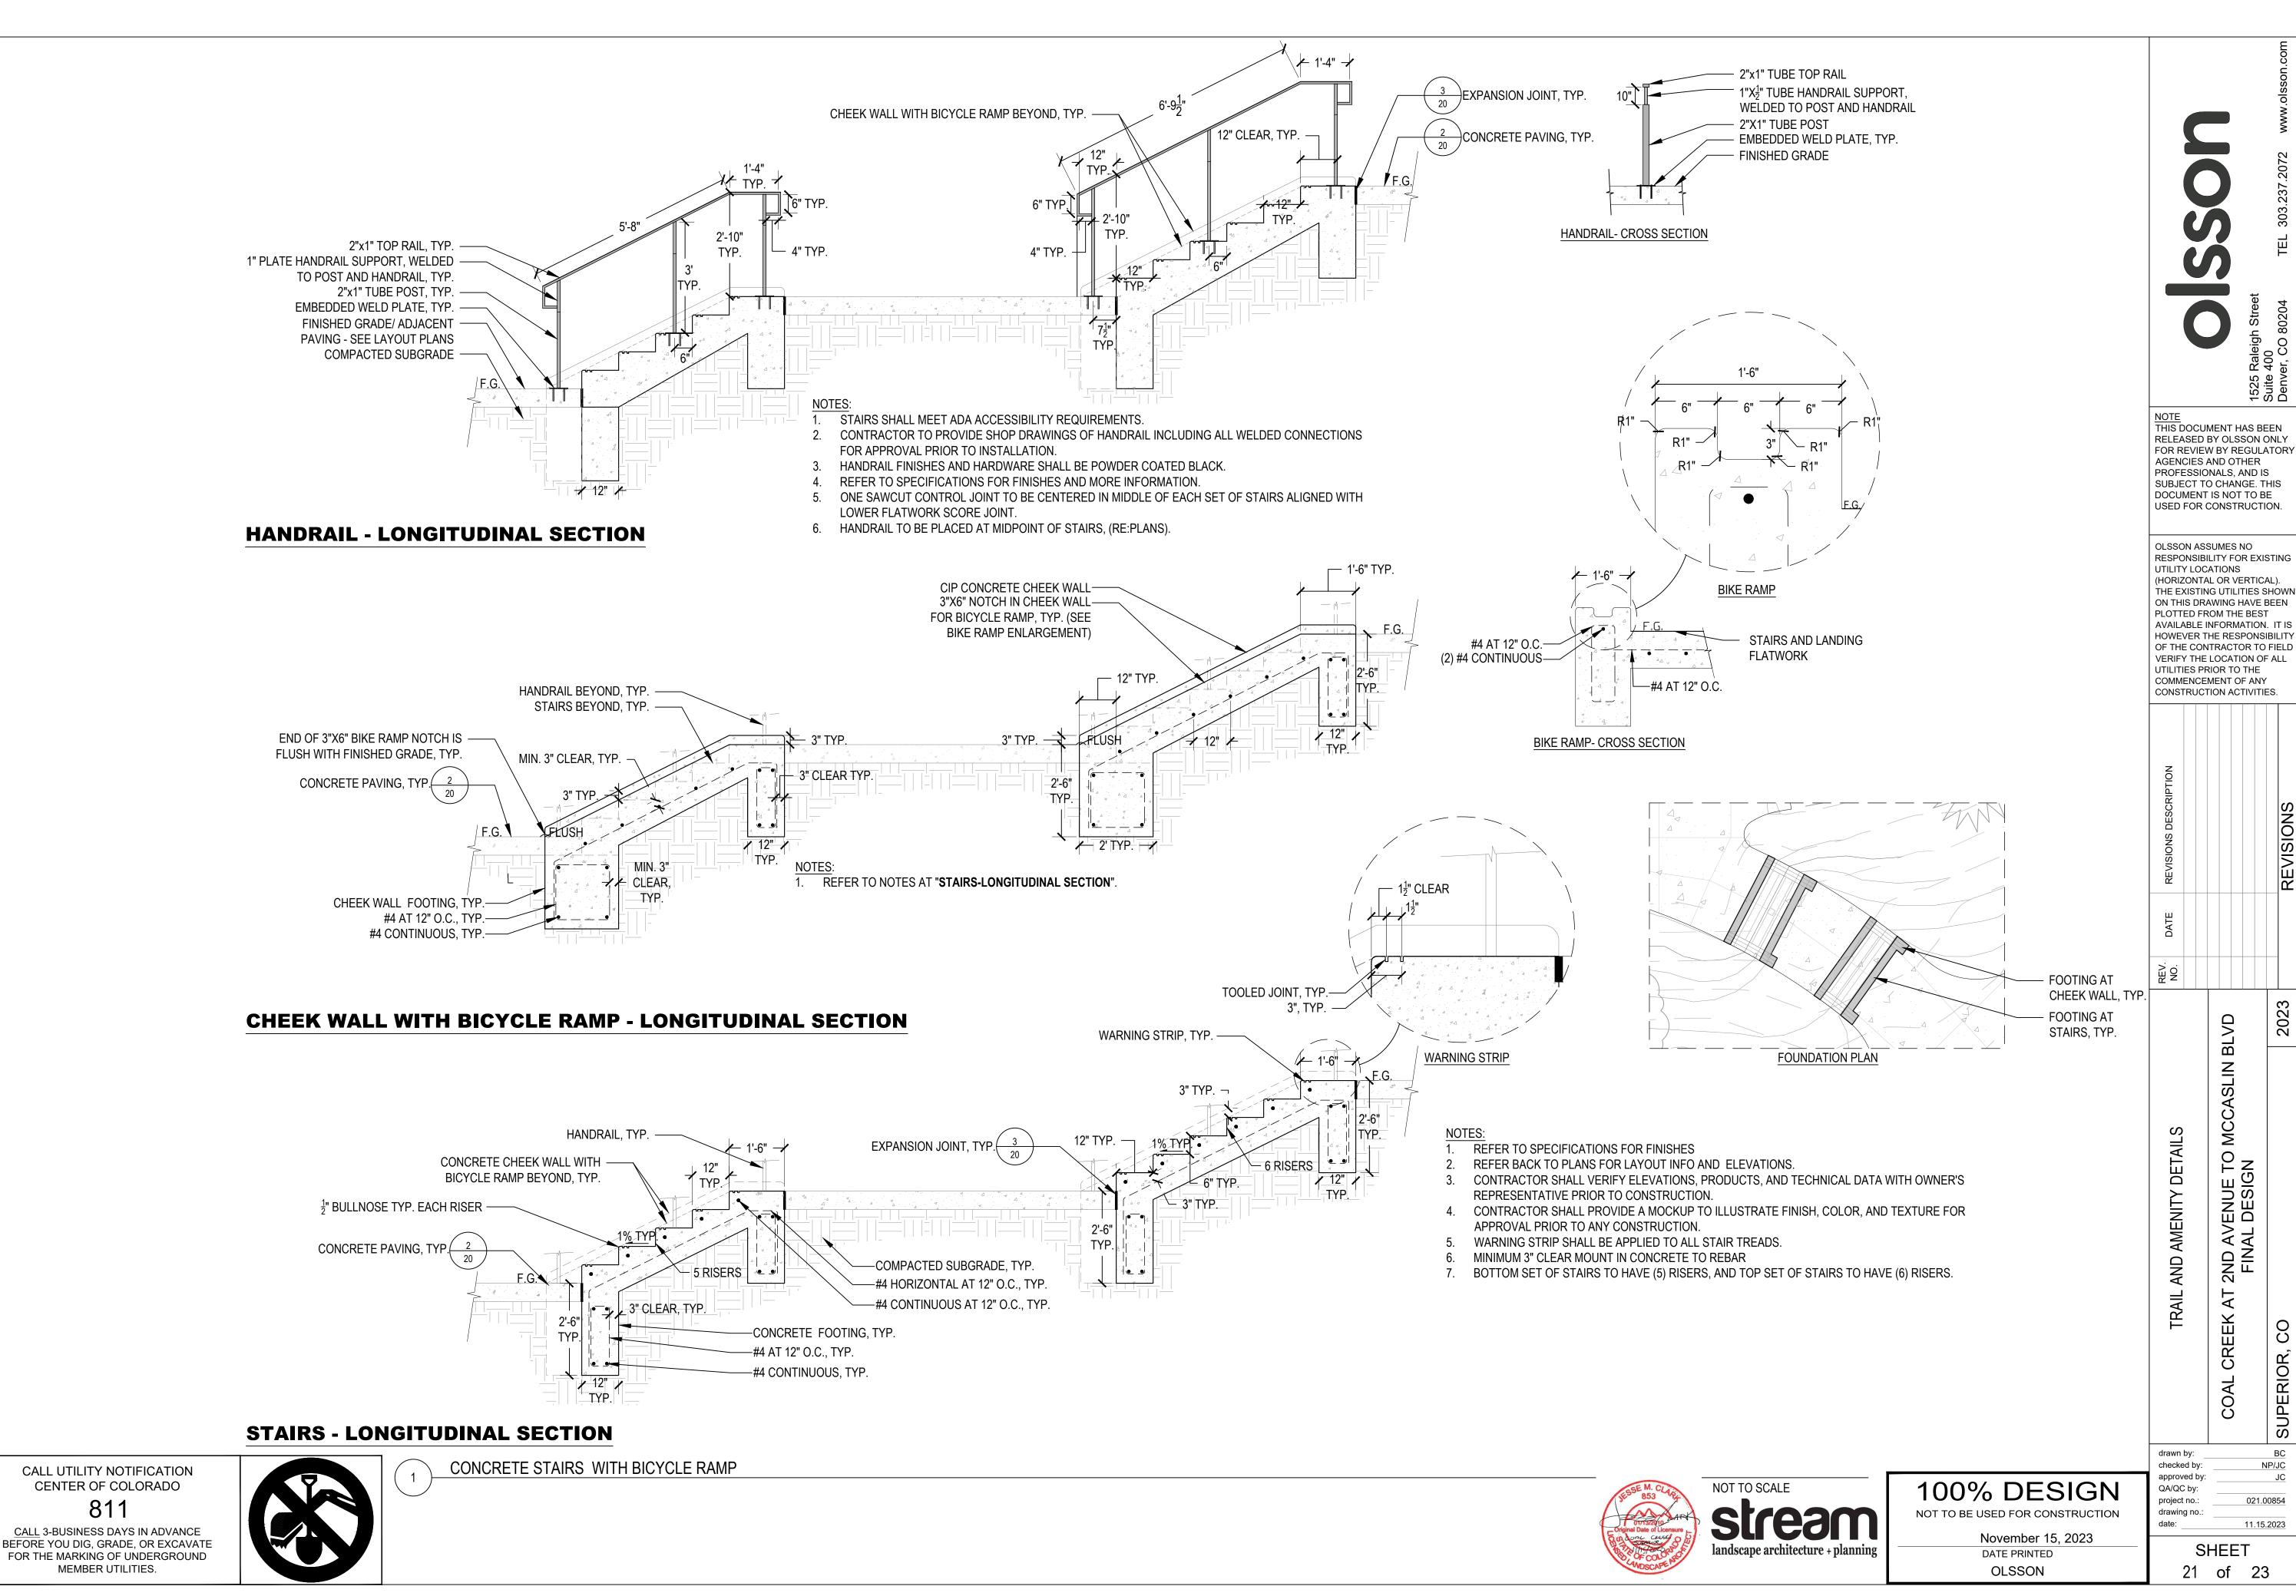

- 2. THE CONTRACTOR SHALL SUPPLY ALL PLANTS IN QUANTITIES SUFFICIENT TO COMPLETE THE WORK SHOWN ON THE PLAN. SHOULD ANY DISCREPANCIES EXIST BETWEEN QUANTITIES SHOWN IN THE PLANT LIST AND THOSE SHOWN IN THE DRAWINGS, THE DRAWINGS SHALL TAKE PRECEDENCE.
- 3. ALL PLANT MATERIAL SHALL BE REVIEWED BY THE OWNER'S REPRESENTATIVE PRIOR TO INSTALLATION. CONTRACTOR SHALL ENSURE PLANT MATERIAL MEET THE SPECIFICATIONS OF THE AMERICAN STANDARDS FOR NURSERY STOCK (LATEST EDITION) AS SET FORTH BY THE AMERICAN ASSOCIATION OF NURSERYMEN.
- 4. CONTRACTOR SHALL FURNISH PLANT MATERIALS FREE OF PESTS OR PLANT DISEASES. PRESELECTED OR "TAGGED" MATERIAL MUST BE INSPECTED BY THE CONTRACTOR AND CERTIFIED PEST AND DISEASE FREE. IT IS THE CONTRACTOR'S OBLIGATION TO WARRANTY ALL PLANT MATERIALS PER THE SPECIFICATIONS.
- 5. CONTRACTOR SHALL STAKE PLANT LOCATIONS FOR THE REVIEW BY THE OWNER'S REPRESENTATIVE. PRIOR TO DIGGING PLANTING PITS. THE CONTRACTOR SHALL RELOCATE ANY PLANT AS DIRECTED BY THE OWNER'S REPRESENTATIVE PRIOR TO PLANTING AT NO ADDITIONAL COST TO THE OWNER.
- 6. CONTRACTOR SHALL SOD AND MULCH AREAS NOTED WITHIN THE CONSTRUCTION LIMITS. ANY LANDSCAPE AREAS BEYOND DISTURBED BY CONSTRUCTION OPERATIONS, NOT DIRECTED BY OWNER'S REPRESENTATIVE, SHALL BE REPAIRED OR REPLACED AT THE CONTRACTOR'S EXPENSE. THE CONTRACTOR SHALL CONFINE ALL OPERATIONS TO THE CONSTRUCTION LIMITS SHOWN. THE CONTRACTOR WILL STAKE THE SODDING LIMITS AND OBTAIN REVIEW FROM THE OWNER'S REPRESENTATIVE PRIOR TO SODDING.
- 7. CONTAMINATION OF PLANTING MIX/TOPSOIL TO REMAIN DURING CONSTRUCTION WILL REQUIRE COMPLETE REPLACEMENT AT CONTRACTOR'S EXPENSE.
- 8. CONTRACTOR SHALL EVALUATE EXISTING PLANT MATERIAL DESIGNATED FOR REMOVAL WITH OWNER'S REPRESENTATIVE. FOLLOWING REVIEW, THE CONTRACTOR SHALL TRANSPLANT ANY PLANT MATERIAL IDENTIFIED AS WORTHY. IF TRANSPLANT CANNOT BE ACCOMPLISHED IN A TIMELY FASHION, CONTRACTOR SHALL APPROPRIATELY STORE THE PLANT MATERIAL AND TRANSPLANT AT A TIME TO BE DETERMINED BY THE OWNER'S REPRESENTATIVE. CONTRACTOR SHALL PROVIDE THESE SERVICES AT NO ADDITIONAL COST TO OWNER.
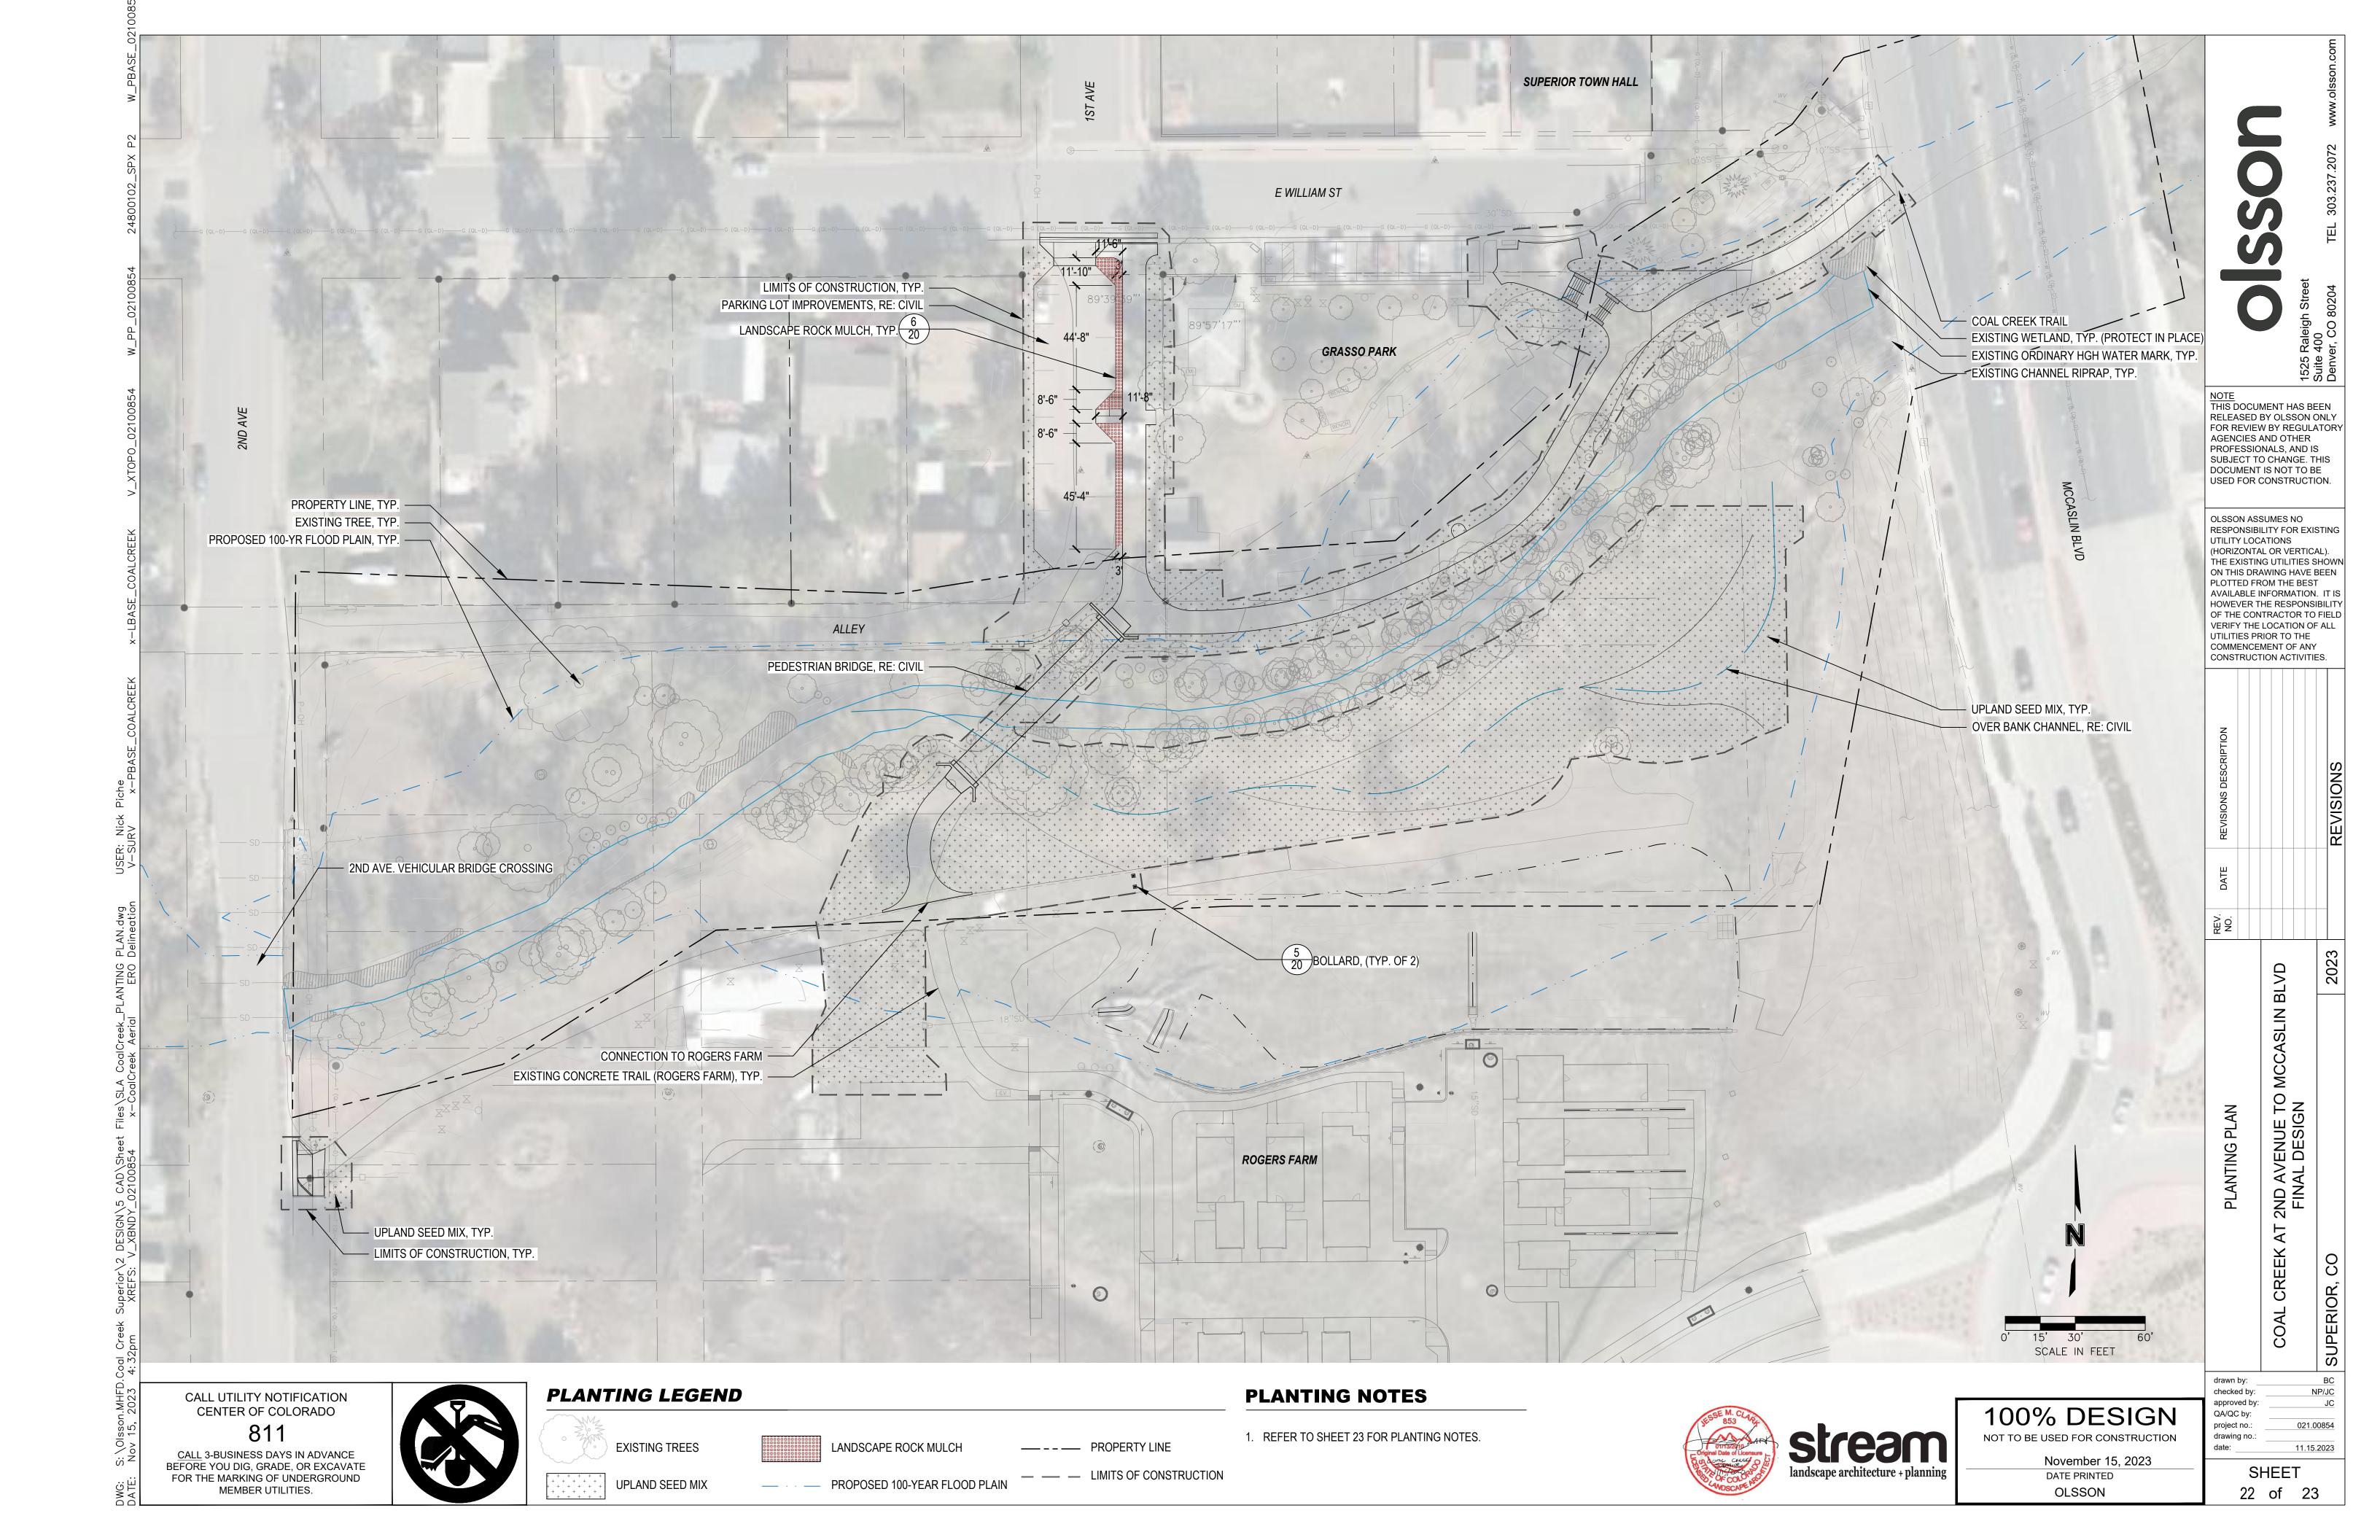
#### **PLANTING SCHEDULE**

SCIENTIFIC NAME AND VARIETY	COMMON NAME	PLS lbs/ac	PLS/sq ft	% of PLS/sq ft
GRAMINOIDS				
Achnatherum hymenoides	INDIAN RICEGRASS	1.61	6	4
Buchloe dactyloides 'Top Gun'	BUFFALOGRASS	14.00	18	12
Bouteloua curtipendula 'Butte'	SIDEOATS GRAMA	2.74	12	8
Bouteloua gracilis 'Lovington'	BLUE GRAMA	0.95	18	12
Elymus trachycaulus ssp. trachycaulus 'San Luis'	SLENDER WHEATGRASS	1.64	6	4
Koeleria macrantha	PRAIRIE JUNEGRASS	0.11	6	4
Nassella viridula 'Lodorm'	GREEN NEEDLEGRASS	1.41	6	4
Pascopyrum smithii 'Arriba'	WESTERN WHEATGRASS	7.03	15	10
Schizachyrium scoparium	LITTLE BLUESTEM	1.01	6	4
Sorghastrum nutans	YELLOW INDIANGRASS	1.54	6	4
Sporobolis airoides	ALKALI SACATON	0.15	6	4
Stipa comata	NEEDLE AND THREAD	2.27	6	4
	GRAMINOID TOTAL	34.46	111	74
FORBS				
Asclepias tuberosa	BUTTERFLY MILKWEED	2.85	5	3
Castilleja linariifolia	WYOMING INDIAN PAINTBRUSH	0.04	5	3
Cleome serrulata	ROCKY MOUNTAIN BEEPLANT	2.03	3	2
Dalea purpurea	PURPLE PRAIRIE CLOVER	1.19	8	5
Heterotheca villosa	HAIRY GOLDENASTER	0.78	6	4
Mentzelia decapetala	TEN-PETAL BLAZING STAR	0.65	5	3
Oenothera caespitosa	EVENING PRIMROSE	0.20	6	4
Penstemon angustifolius	BROADBEARD BEARDTONGUE	0.59	3	2
	FORB TOTAL	8.32	39	26
	MIX TOTAL	42.78	150	

CALL UTILITY NOTIFICATION CENTER OF COLORADO

CALL 3-BUSINESS DAYS IN ADVANCE BEFORE YOU DIG, GRADE, OR EXCAVATE FOR THE MARKING OF UNDERGROUND MEMBER UTILITIES.



100% DESIGN NOT TO BE USED FOR CONSTRUCTION

> November 15, 2023 DATE PRINTED OLSSON

checked by: approved by: QA/QC by: project no.: 021.00854 drawing no.:

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NOTE THIS DOCUMENT HAS BEEN RELEASED BY OLSSON ONLY FOR REVIEW BY REGULATORY

OLSSON ASSUMES NO RESPONSIBILITY FOR EXISTING UTILITY LOCATIONS (HORIZONTAL OR VERTICAL). THE EXISTING UTILITIES SHOWN ON THIS DRAWING HAVE BEEN PLOTTED FROM THE BEST AVAILABLE INFORMATION. IT IS HOWEVER THE RESPONSIBILITY OF THE CONTRACTOR TO FIELD VERIFY THE LOCATION OF ALL UTILITIES PRIOR TO THE COMMENCEMENT OF ANY CONSTRUCTION ACTIVITIES.

AGENCIES AND OTHER

PROFESSIONALS, AND IS SUBJECT TO CHANGE. THIS

DOCUMENT IS NOT TO BE

USED FOR CONSTRUCTION.

BLVD

PLANTING NOTES AND SCHEDULE 2ND AVENUE TO I FINAL DESIGN

NP/JC

11.15.2023