SUPERIOR TOWN CENTER

FINAL DEVELOPMENT PLAN 1 PHASE 3 (MCCASLIN ROUNDABOUT)

SUPERIOR, COLORADO



PHASE 3 (MCCASLIN ROUNDABOUT) SUPERIOR TOWN CENTER

REVISIONS						
NO.	DESCRIPTION	DA				
1	TECHNICAL CORRECTIONS	8-17-				
_						
_		-				
-		_				

COVER SHEET



MIG, INC. 158 FILLMORE STREET STE. 400 DENVER. CO 80206

(303)440-9200

PREPARED FOR: STC METROPOLITAN DISTRICT #2

141 UNION BLVD., STE. LAKEWOOD, CO 80228

PREPARED BY:

LANDMARK CONSULTING 9555 GENESEE AVE., STE. 200 SAN DIEGO, CA 92121 (858)587-8070


CIVIL RESOURCES, LLC

CLANTON & ASSOCIATES 4699 NAUTILUS COURT SOUTH STE. 102 BOULDER, CO 80301 (303)530-7229

323 5TH STREET P.O. BOX 680 FREDERICK, CO 80530 (303)833-1416

HYDROSYSTEMS—KDI, INC. 860 TABOR STREET STE. 200 LAKEWOOD, CO 80401 (303)980-5327 NAME: 184-1 CV1.DW0 CV1.0



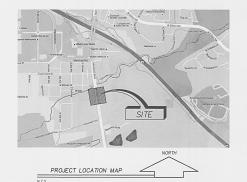

PLANNING COMMISSION CERTIFICATE:

| doy of | Sunt | 2012, by the Town of Superior Planning Commission, Resolution No. PC 1 | Series 2012

Executed this 31st day of August , 2016. Clint Folsom Town of Superior

NOTARIAL CERTIFICATE

STATE OF Colorado)

County of Boulder)

The foregoing certificate of ownership was acknowledged before me this

31 st day of August , 2016, by Clint Folsom

by Clint terson.

My commission expires: 2-5-17

PHYLLIS L MARDIN STANDARY FULLIC STANDARY FUL

Memo of Record Recording #0354/131
Dates 9/1/2016

Physics L'Hardin

CERTIFICATE OF OWNERSHIP AND DEDICATION: RC SUPERIOR, LLC, a Delaware limited liability company II Holdings, LLC, a Delaware limited liability company, Its sole Member By: Avanti Strategic Land Investors VII, LLLLP., a Delaware limited liability company, Its sole Member By: Avanti Strategic Land Investors VII, LLLLP., a Delaware limited

liability limited partnership, its sole Member By: Avanti Properties Group II, LLLLP., a Delaware limited liability limited partnership, its Managing General Partner By: Avanti Management Corporation, a Florida corporation, its sole

I certify that I, AC Supera LLC, am the sole owner of the property

The foregoing certificate of deducation and ownership was acknowledged before me this 25 day of August 20 16 by Andrew DuBill, Vice President My commission expires: May 28, 2019 Sout & Maraba

Approved by the Board of Trustees of the Town of Superior, State of Colgradia Mitgess my hand the corporate seal of the Town of Superior

day of August , 2016

ertify that this instrument as approved by (Resolution/Ordinance) No. 40, Series 20 16 , was filed in my office on the 25th day of August 2016 at 2100

Witness my hand the corporate seal of the Town of Superior

Ellerdin Clint Folsom

Mayor

day of August, 2016

JANET R. MORALES
Notary Public
NOTARY PUBLIC STATE OF FEZOTOS
EXPIRES: 05/28/2019

Mortgagees or Lien Holders

General Partner

consent to this plan.

Executed this 25

STATE OF FLORIDA)

county of ORange)

BOARD OF TRUSTEES CERTIFICATE:

o'clock am/pm

and

P:\184-1 SUPERIOR TOWN CENTER\D PLANNING AND ENGINEERING\CONTRACT DOCUMENTS\184-1 CVI.DWG 8/12/2016 7:59 AM

SHEET 1 OF 25

SUPERIOR TOWN CENTER

FINAL DEVELOPMENT PLAN 1 PHASE 3 (MCCASLIN ROUNDABOUT)

SUPERIOR, COLORADO

SUPERIOR TOWN CENTER FDP 1 PHASE 3 (MCCASLIN ROUNDABOUT

REVISIONS

DESIGNED BY:	XXX	DATE: <u>AUG. 12</u>
DRAWN BY:	XXX	SCALE: AS NOTI
CHECKED BY:	XXX	AS NOTI
10B NO · 18/	1_1	

DWG NAME: 184-1 CV1.DWG

COVER SHEET

CV1.0

Know what's **below**. **Call** before you dig.

MIG, INC.

DENVER, CO 80206

LAKEWOOD, CO 80401

(303)440-9200

(303)980-5327

158 FILLMORE STREET STE. 400

HYDROSYSTEMS-KDI, INC.

860 TABOR STREET STE. 200

PRFPARFD FOR:

PREPARED BY:

SAN DIEGO, CA 92121

FREDERICK, CO 80530

BOULDER, CO 80301

(303)530-7229

(858)587-8070

323 5TH STREET

P.O. BOX 680

(303)833-1416

141 UNION BLVD., STE. 150 LAKEWOOD, CO 80228

LANDMARK CONSULTING

CIVIL RESOURCES, LLC


CLANTON & ASSOCIATES

4699 NAUTILUS COURT SOUTH STE. 102

9555 GENESEE AVE., STE. 200

STC METROPOLITAN DISTRICT #2

Sheet List Table SHEET NAME **COVER SHEET** C1.0 CONTEXT PLAN CONTOUR ELEVATION PLAN CHANNELIZATION PLAN CHANNELIZATION PLAN CH1.2 CHANNELIZATION PLAN CHANNELIZATION PLAN CHANNELIZATION DETAILS CHANNELIZATION DETAILS SIGNING PLAN SIGNING PLAN SIGNING SCHEDULE PARTIAL UTILITY PLAN PARTIAL UTILITY PLAN OVERALL LIGHTING PLAN LIGHTING PLAN LIGHTING PLAN LIGHTING DETAILS OVERALL LANDSCAPE PLAN L1.1 LANDSCAPE PLAN LANDSCAPE PLAN LANDSCAPE NOTES & DETAILS **IRRIGATION NOTES & SCHEDULE** IRRIGATION PLAN IRRIGATION PLAN

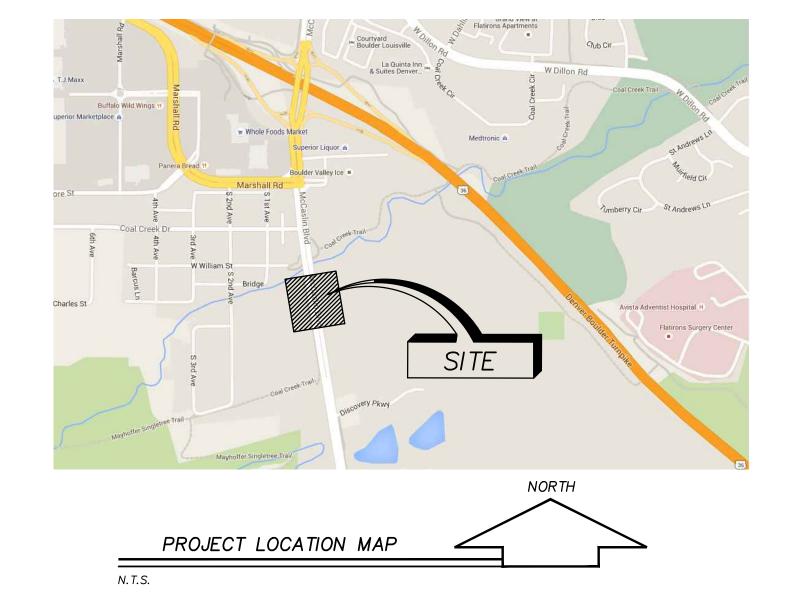

Notary Public

Mortgagees or Lien Holders

BOARD OF TRUSTEES CERTIFICATE:

Approved by the Board of Trustees of the Town of Superior, State of Colorado. Witness my hand the corporate seal of the Town of Superior _____, day of _____, 20____.

Attest: ______ Town Clerk

CERTIFICATE OF OWNERSHIP AND DEDICATION: RC SUPERIOR, LLC, a

By: Superior Town Center ASLI VII Holdings, LLC, a Delaware limited

By: Avanti Strategic Land Investors VII, L.L.L.P., a Delaware limited

By: Avanti Properties Group II, L.L.L.P., a Delaware limited liability

By: Avanti Management Corporation, a Florida corporation, its sole

Executed this _____, 20_____

The foregoing certificate of deducation and ownership was acknowledged

before me this _____, 20____,

_____, am the sole owner of the property

Delaware limited liability company

liability company, its sole Member

General Partner

consent to this plan.

STATE OF _____)

County of _____)

liability limited partnership, its sole Member

limited partnership, its Managing General Partner

TOWN CLERK CERTIFICATE

I certify that this instrument as approved by (Resolution/Ordinance) No. _____, Series 20_____, was filed in my office on the _____, 20____, at _____ o'clock am/pm.

Witness my hand the corporate seal of the Town of Superior _____, day of _____, 20____.

Town Clerk

PLANNING COMMISSION CERTIFICATE: Recommended approved this _____ day of _____, 20__, by the Town of Superior Planning Commission, Resolution No. PC_____ Series 20__

CERTIFICATE OF OWNERSHIP:

I certify that I,_____, am an owner representativer of the property and consent to this plan.

Executed this _____, 20____,

Town of Superior

NOTARIAL CERTIFICATE

STATE OF ______)

County of ______)

The foregoing certificate of ownership was acknowledged before me this


) ss.


_____ day of ______, 20___, by _____.


My commission expires: ______


Notary Public


P:\184-1 SUPERIOR TOWN CENTER\D PLANNING AND ENGINEERING\CONTRACT DOCUMENTS\184-1 CV1.DWG 8/12/2016 7:59 AM

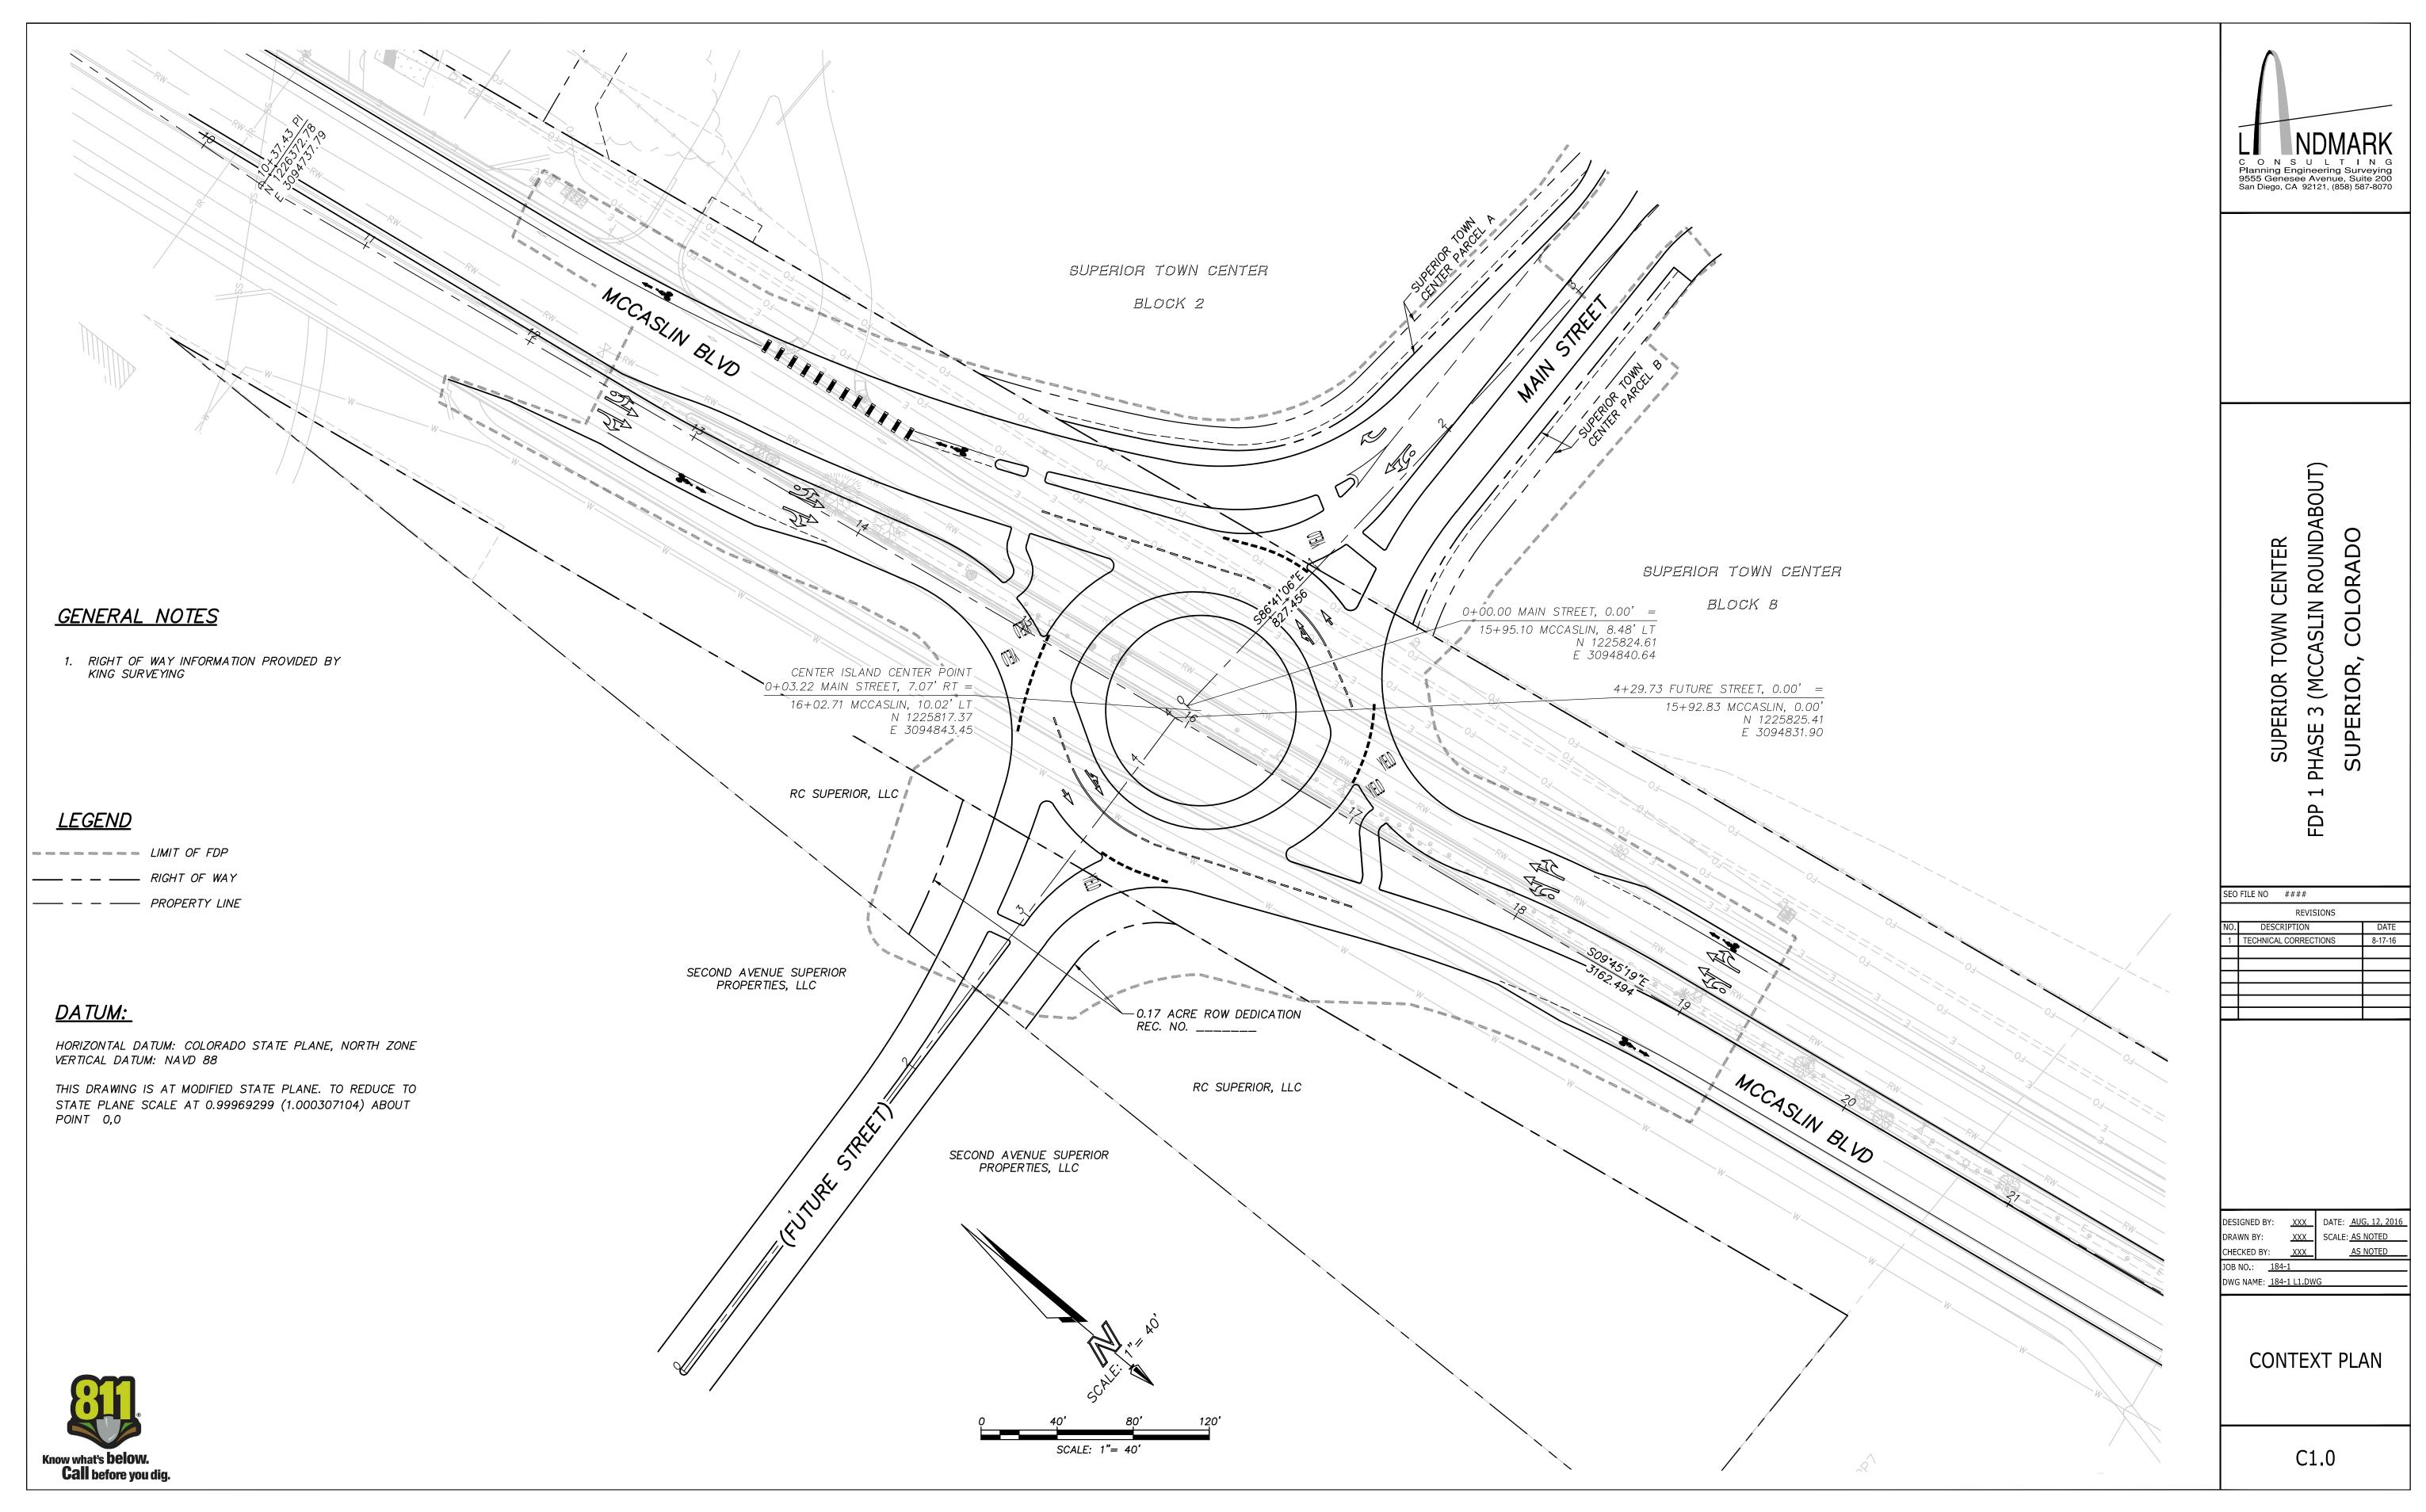


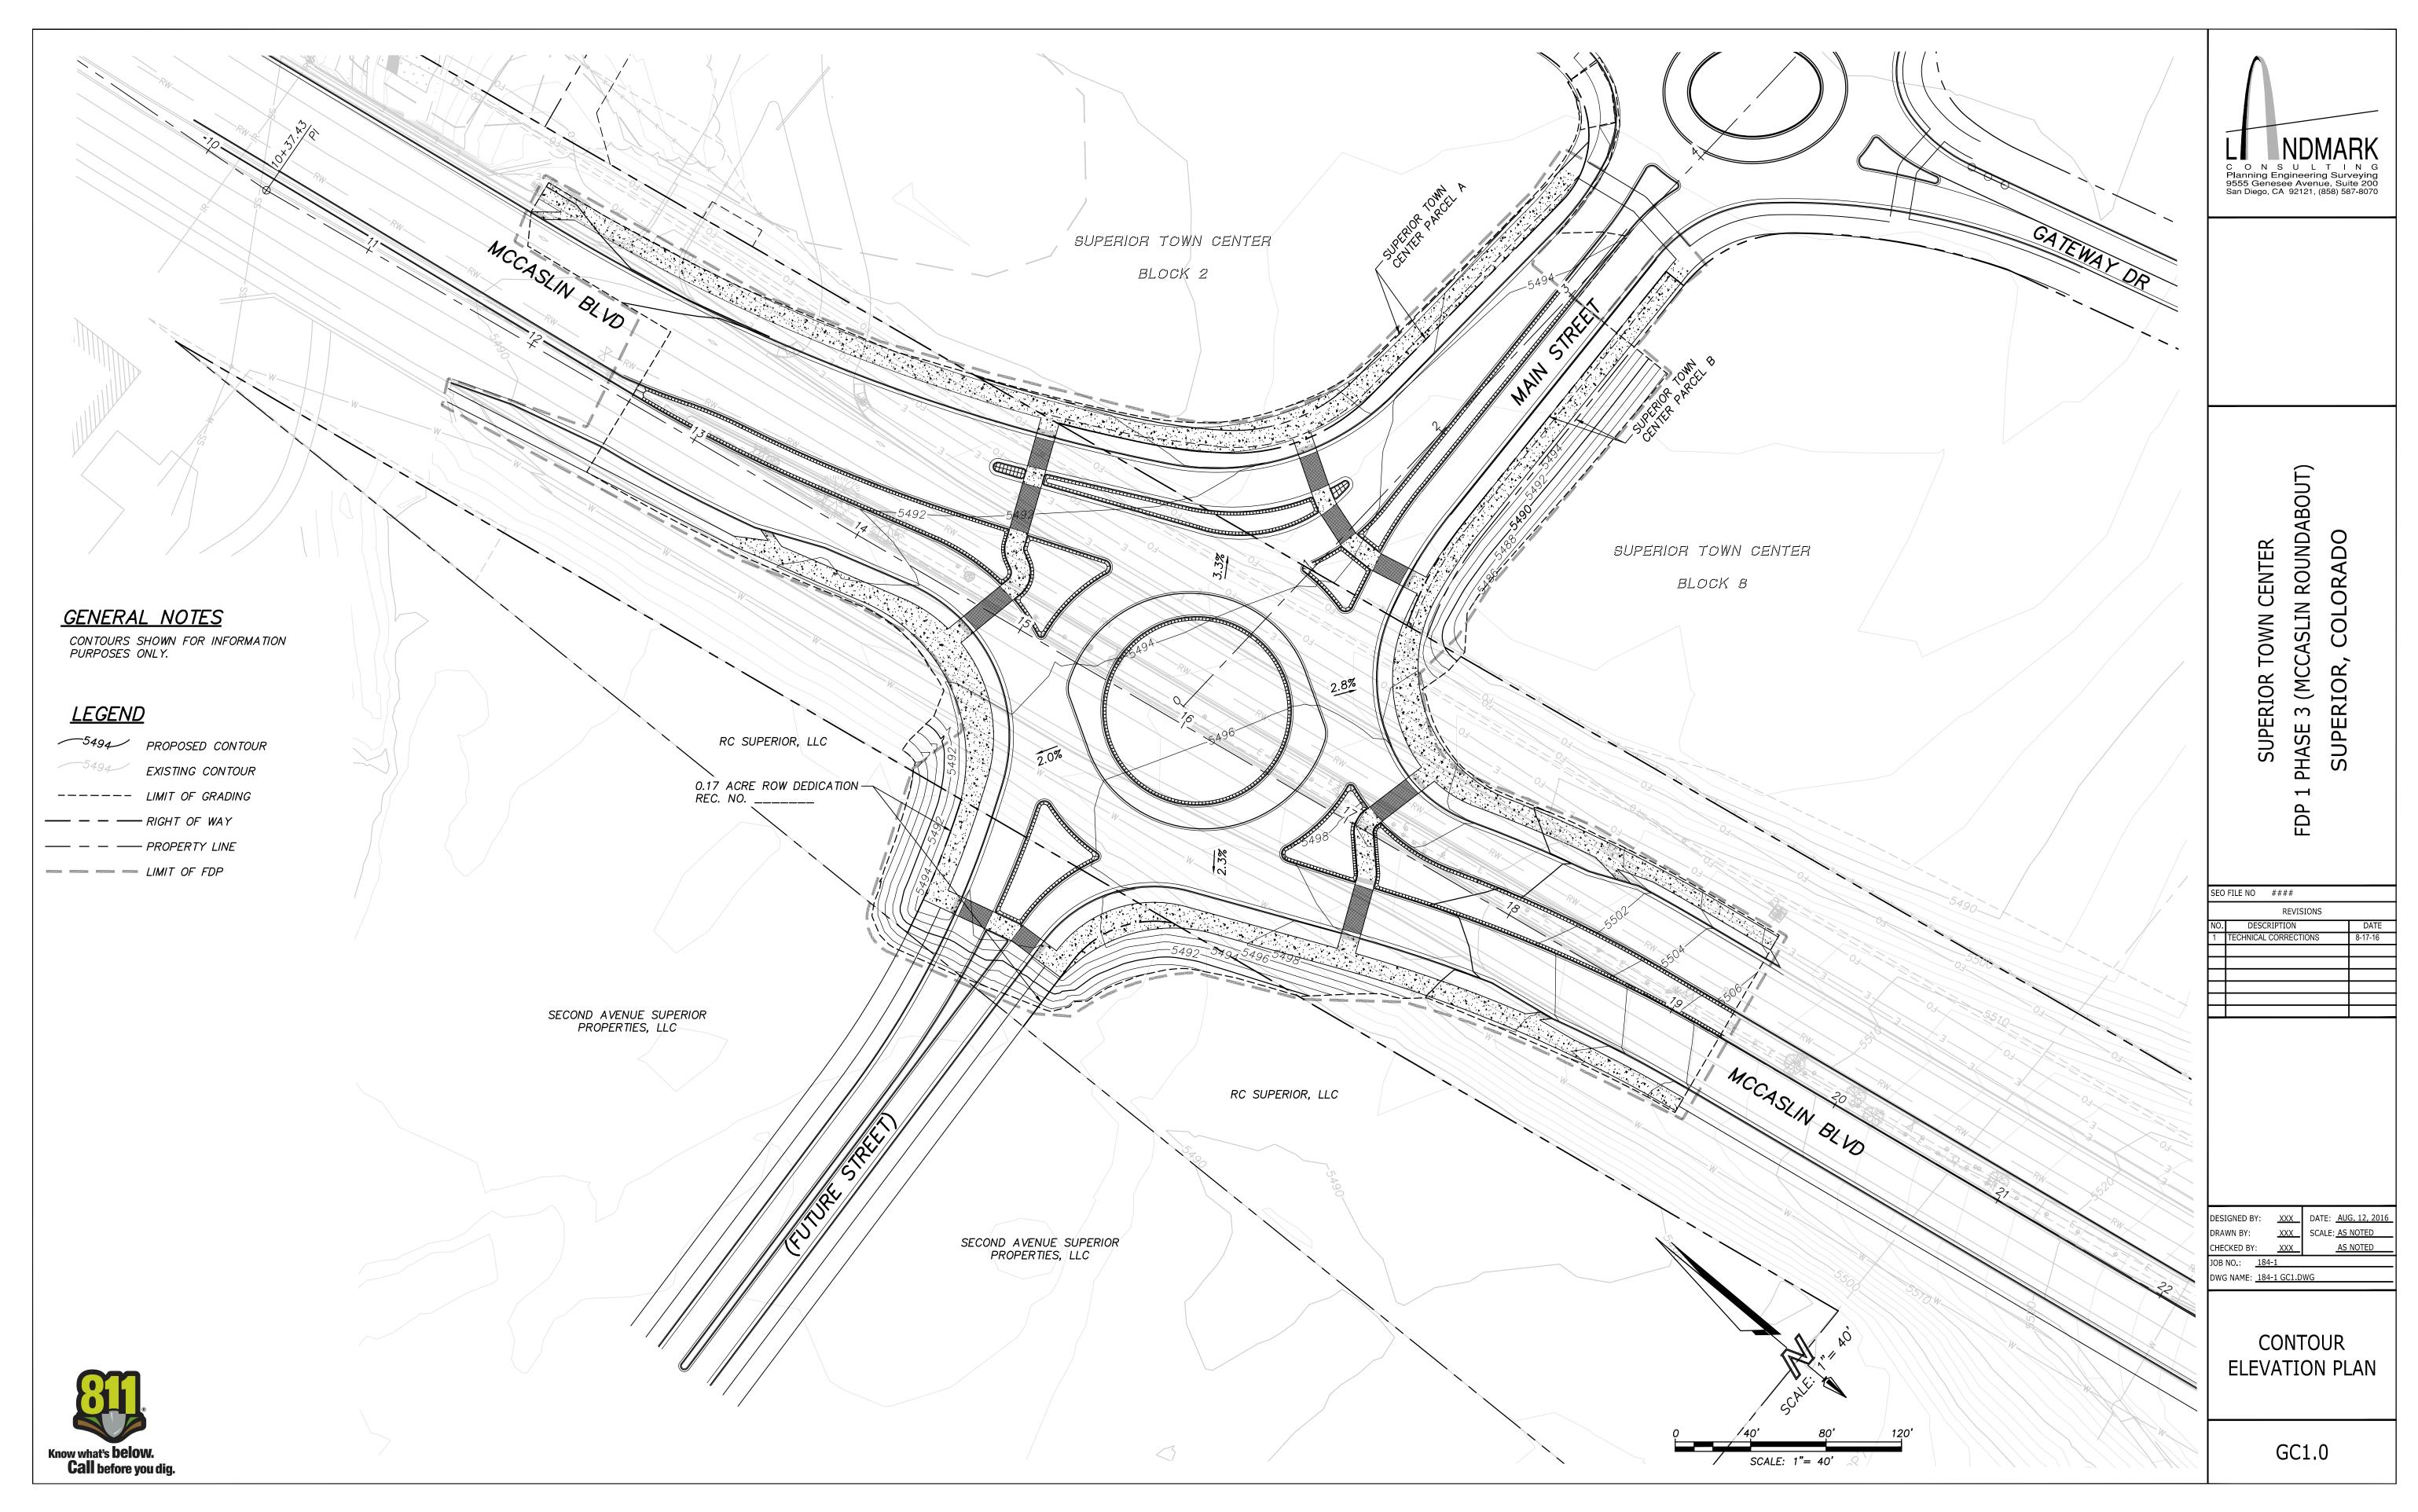


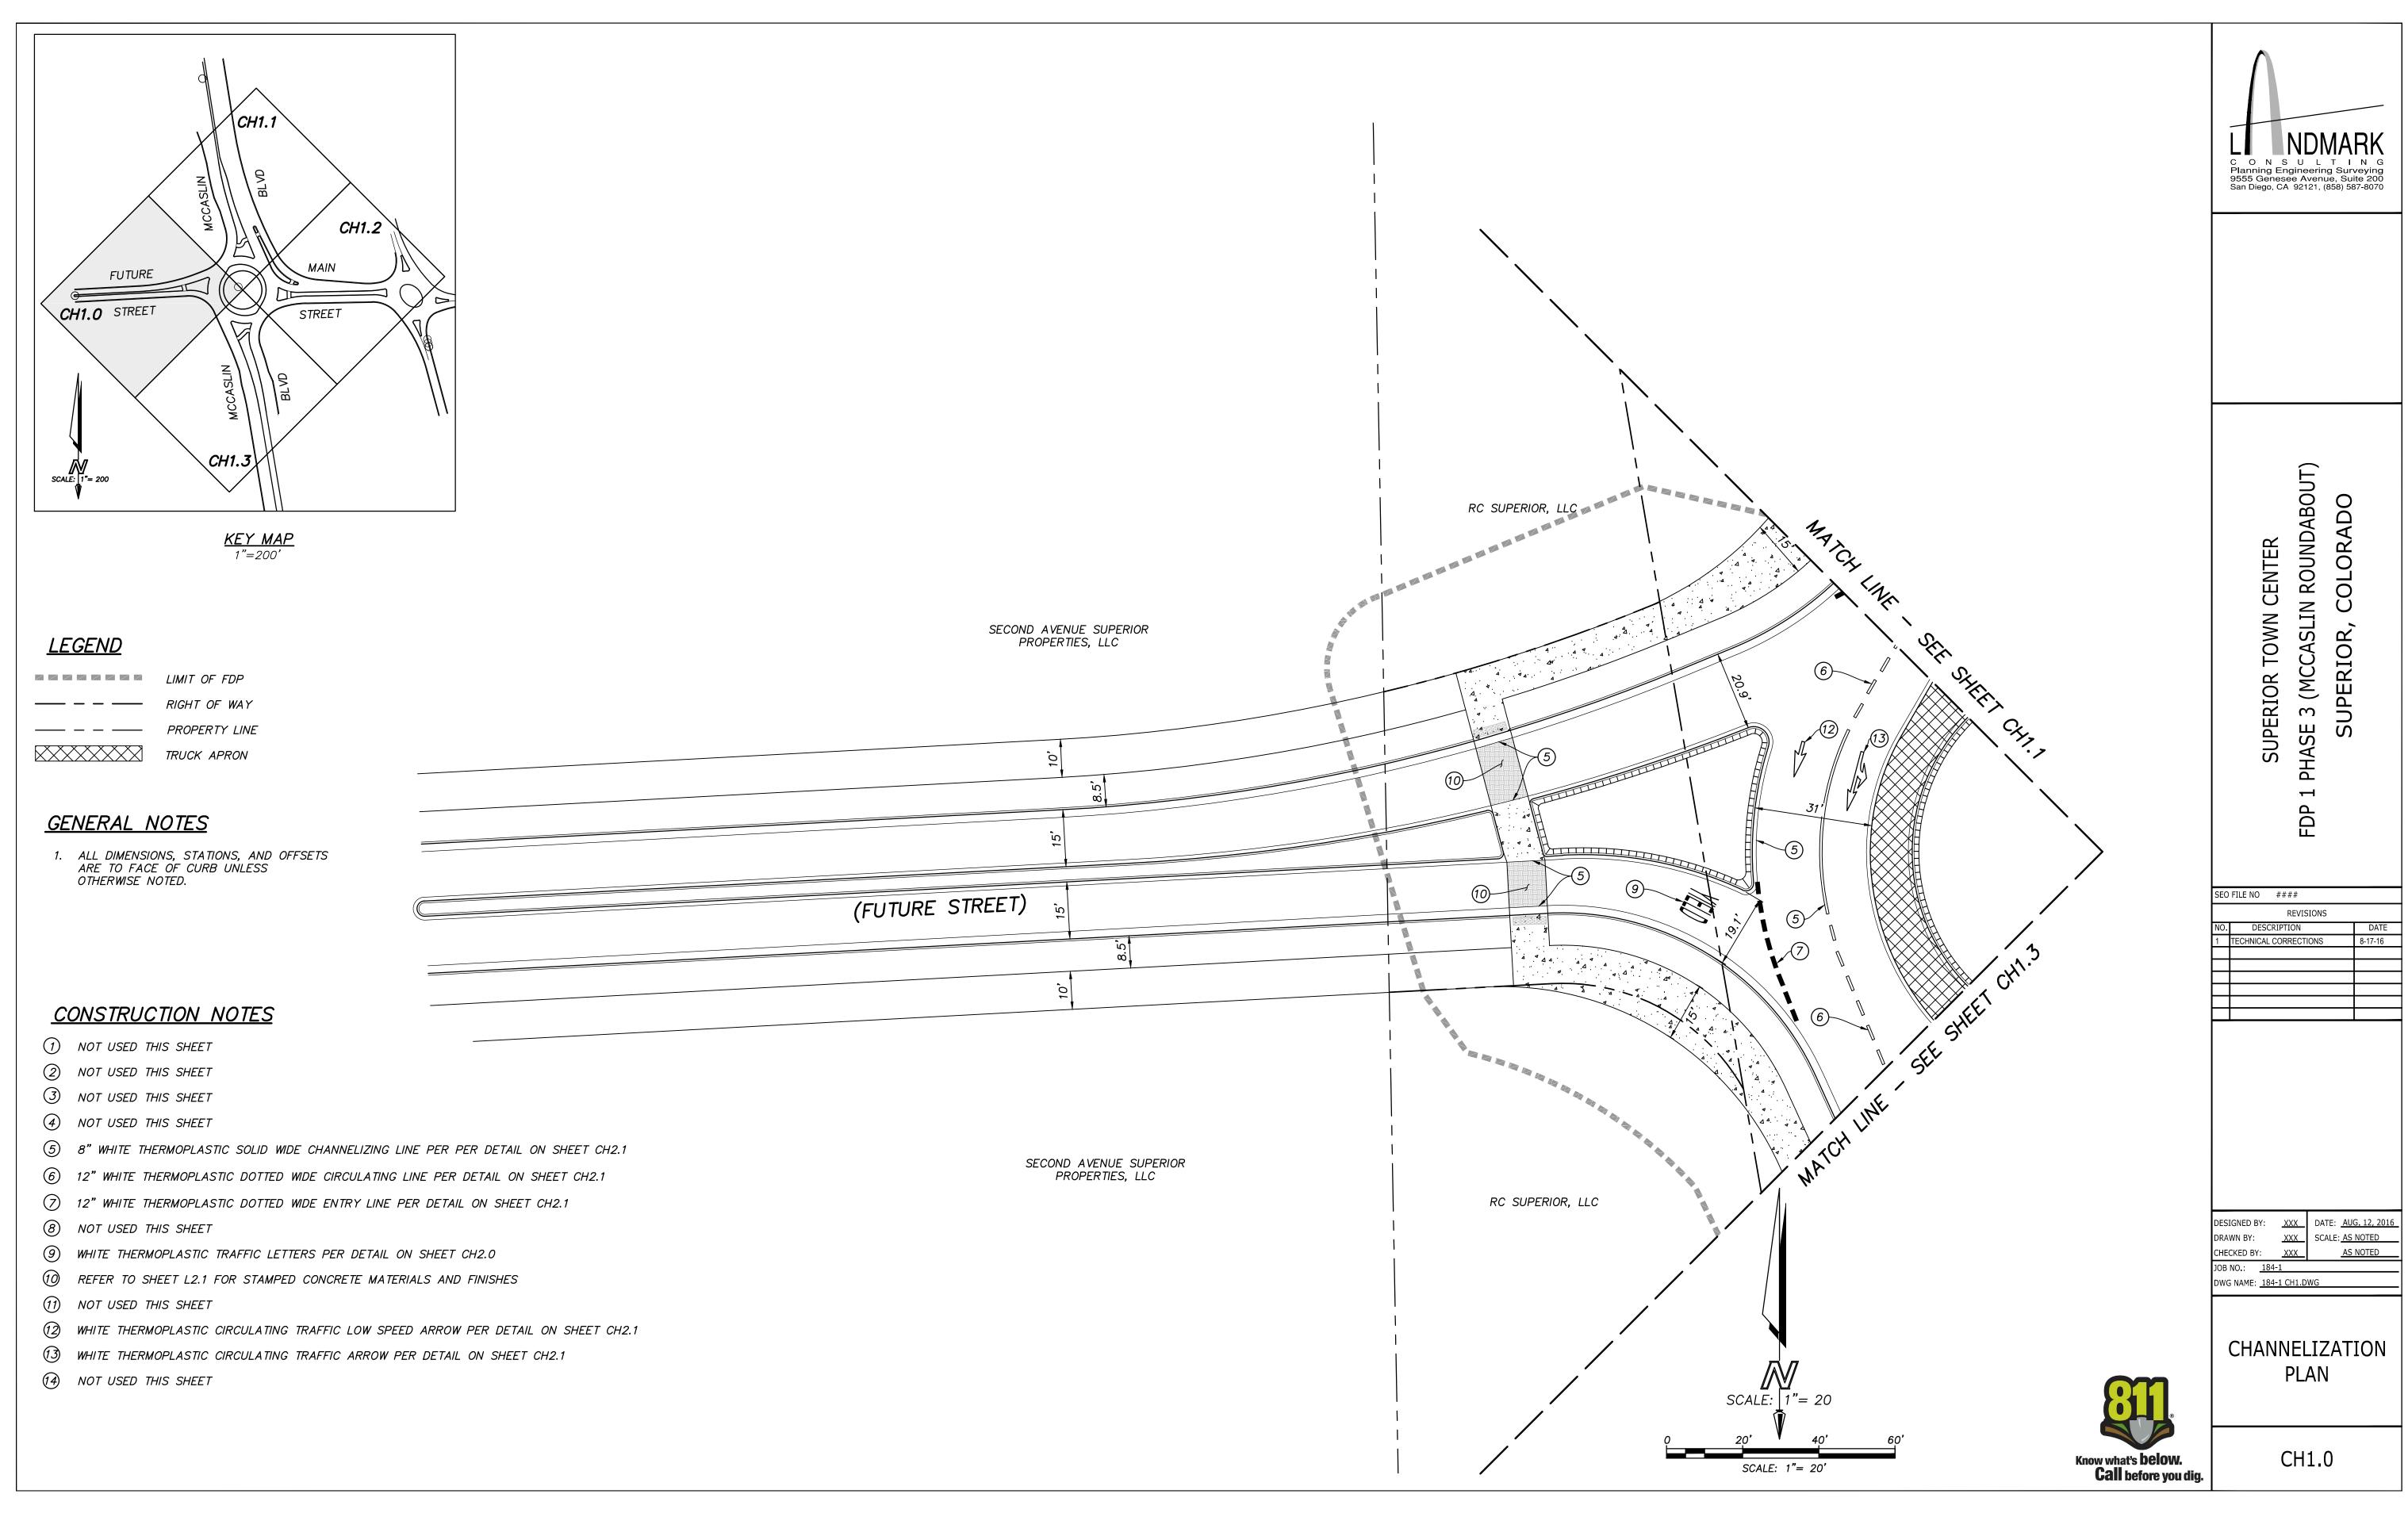

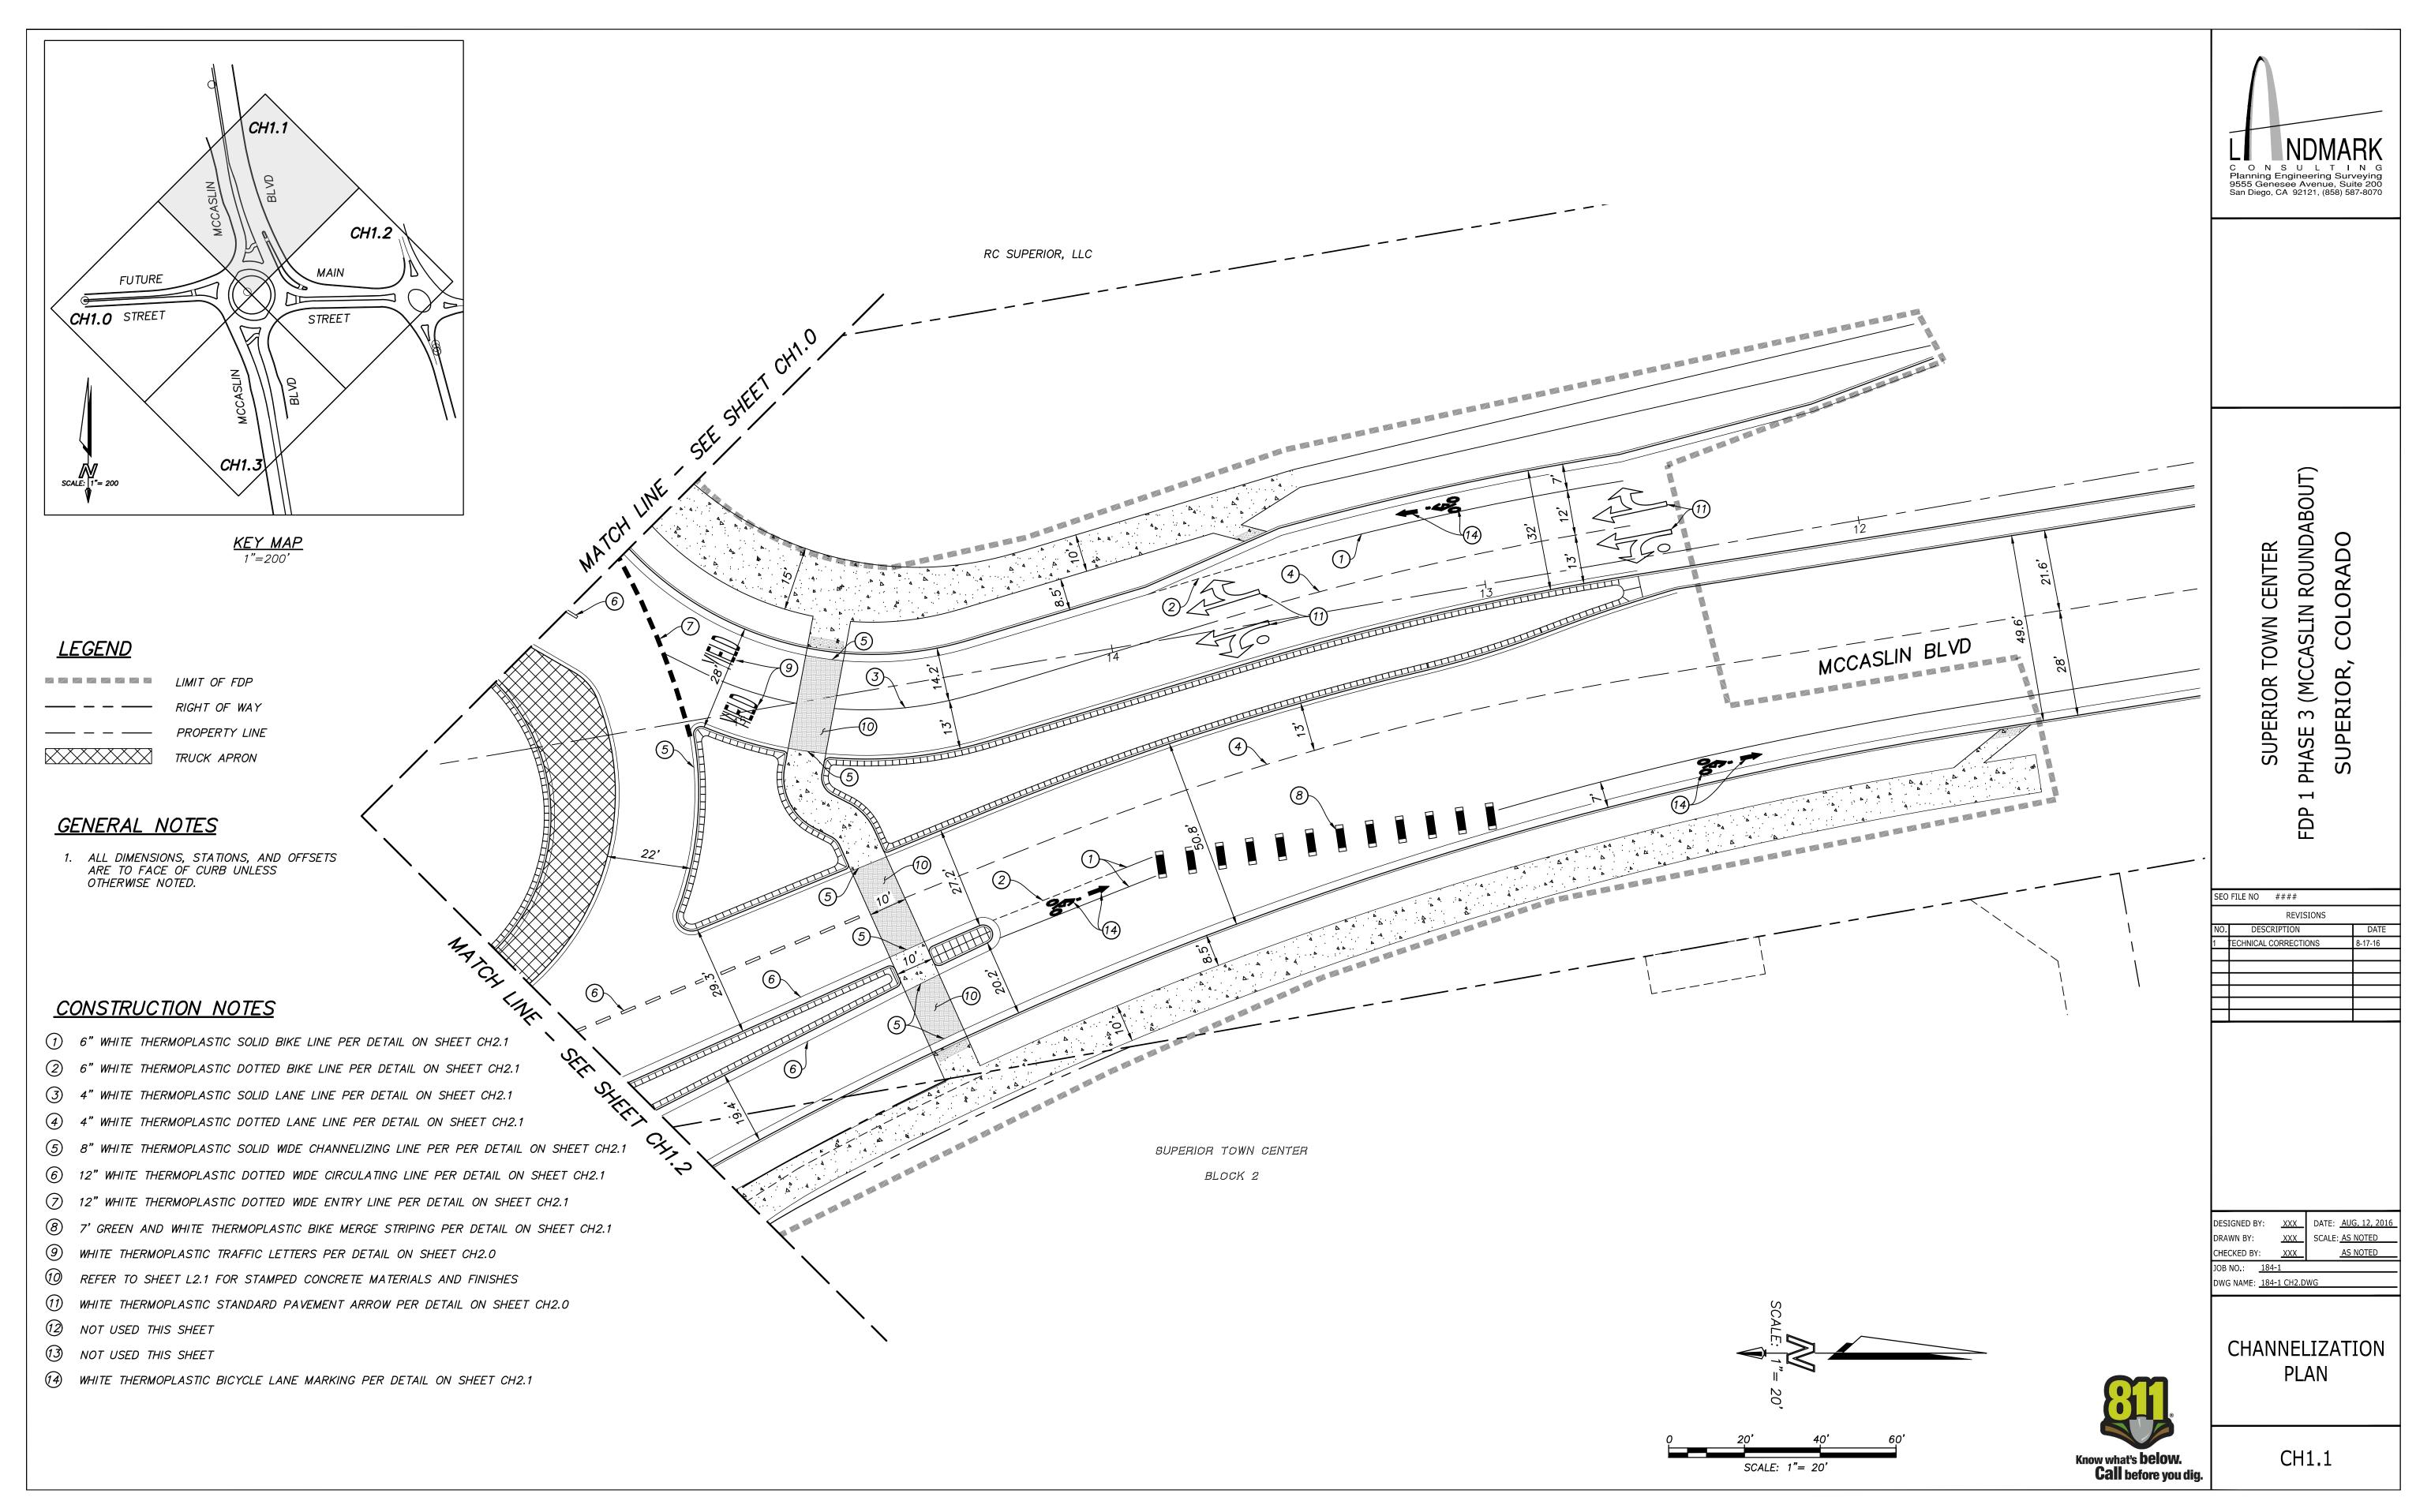

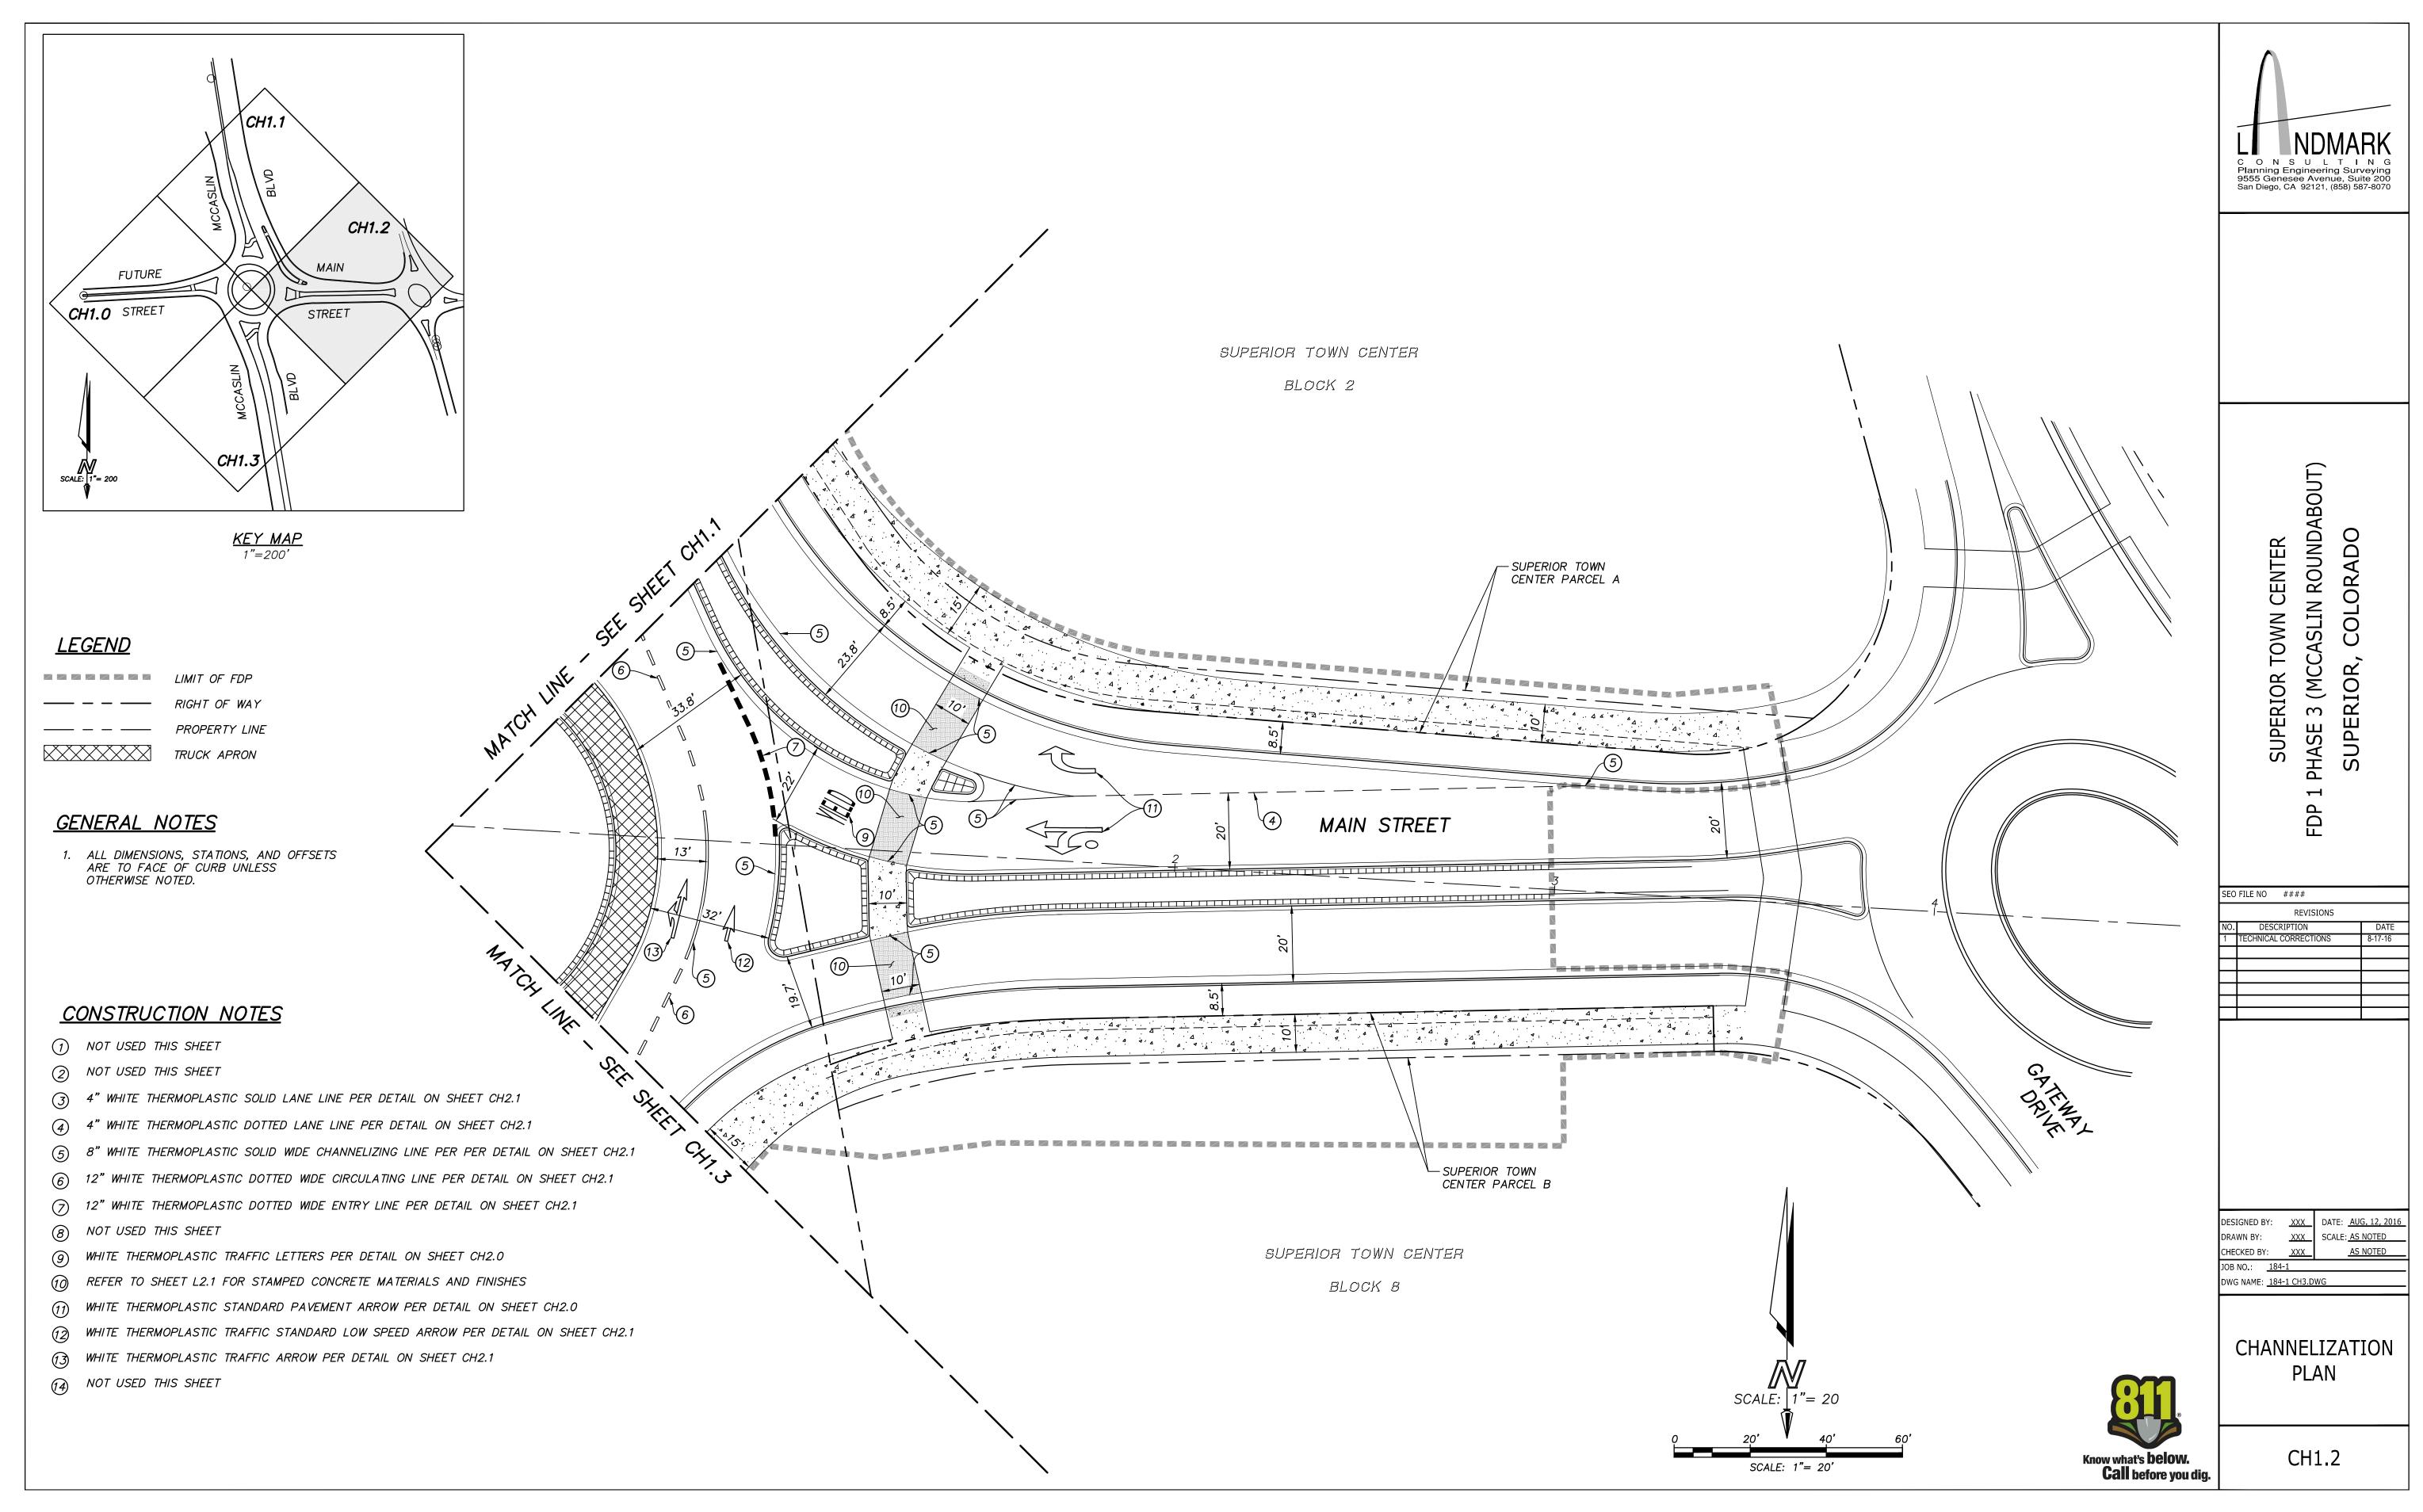

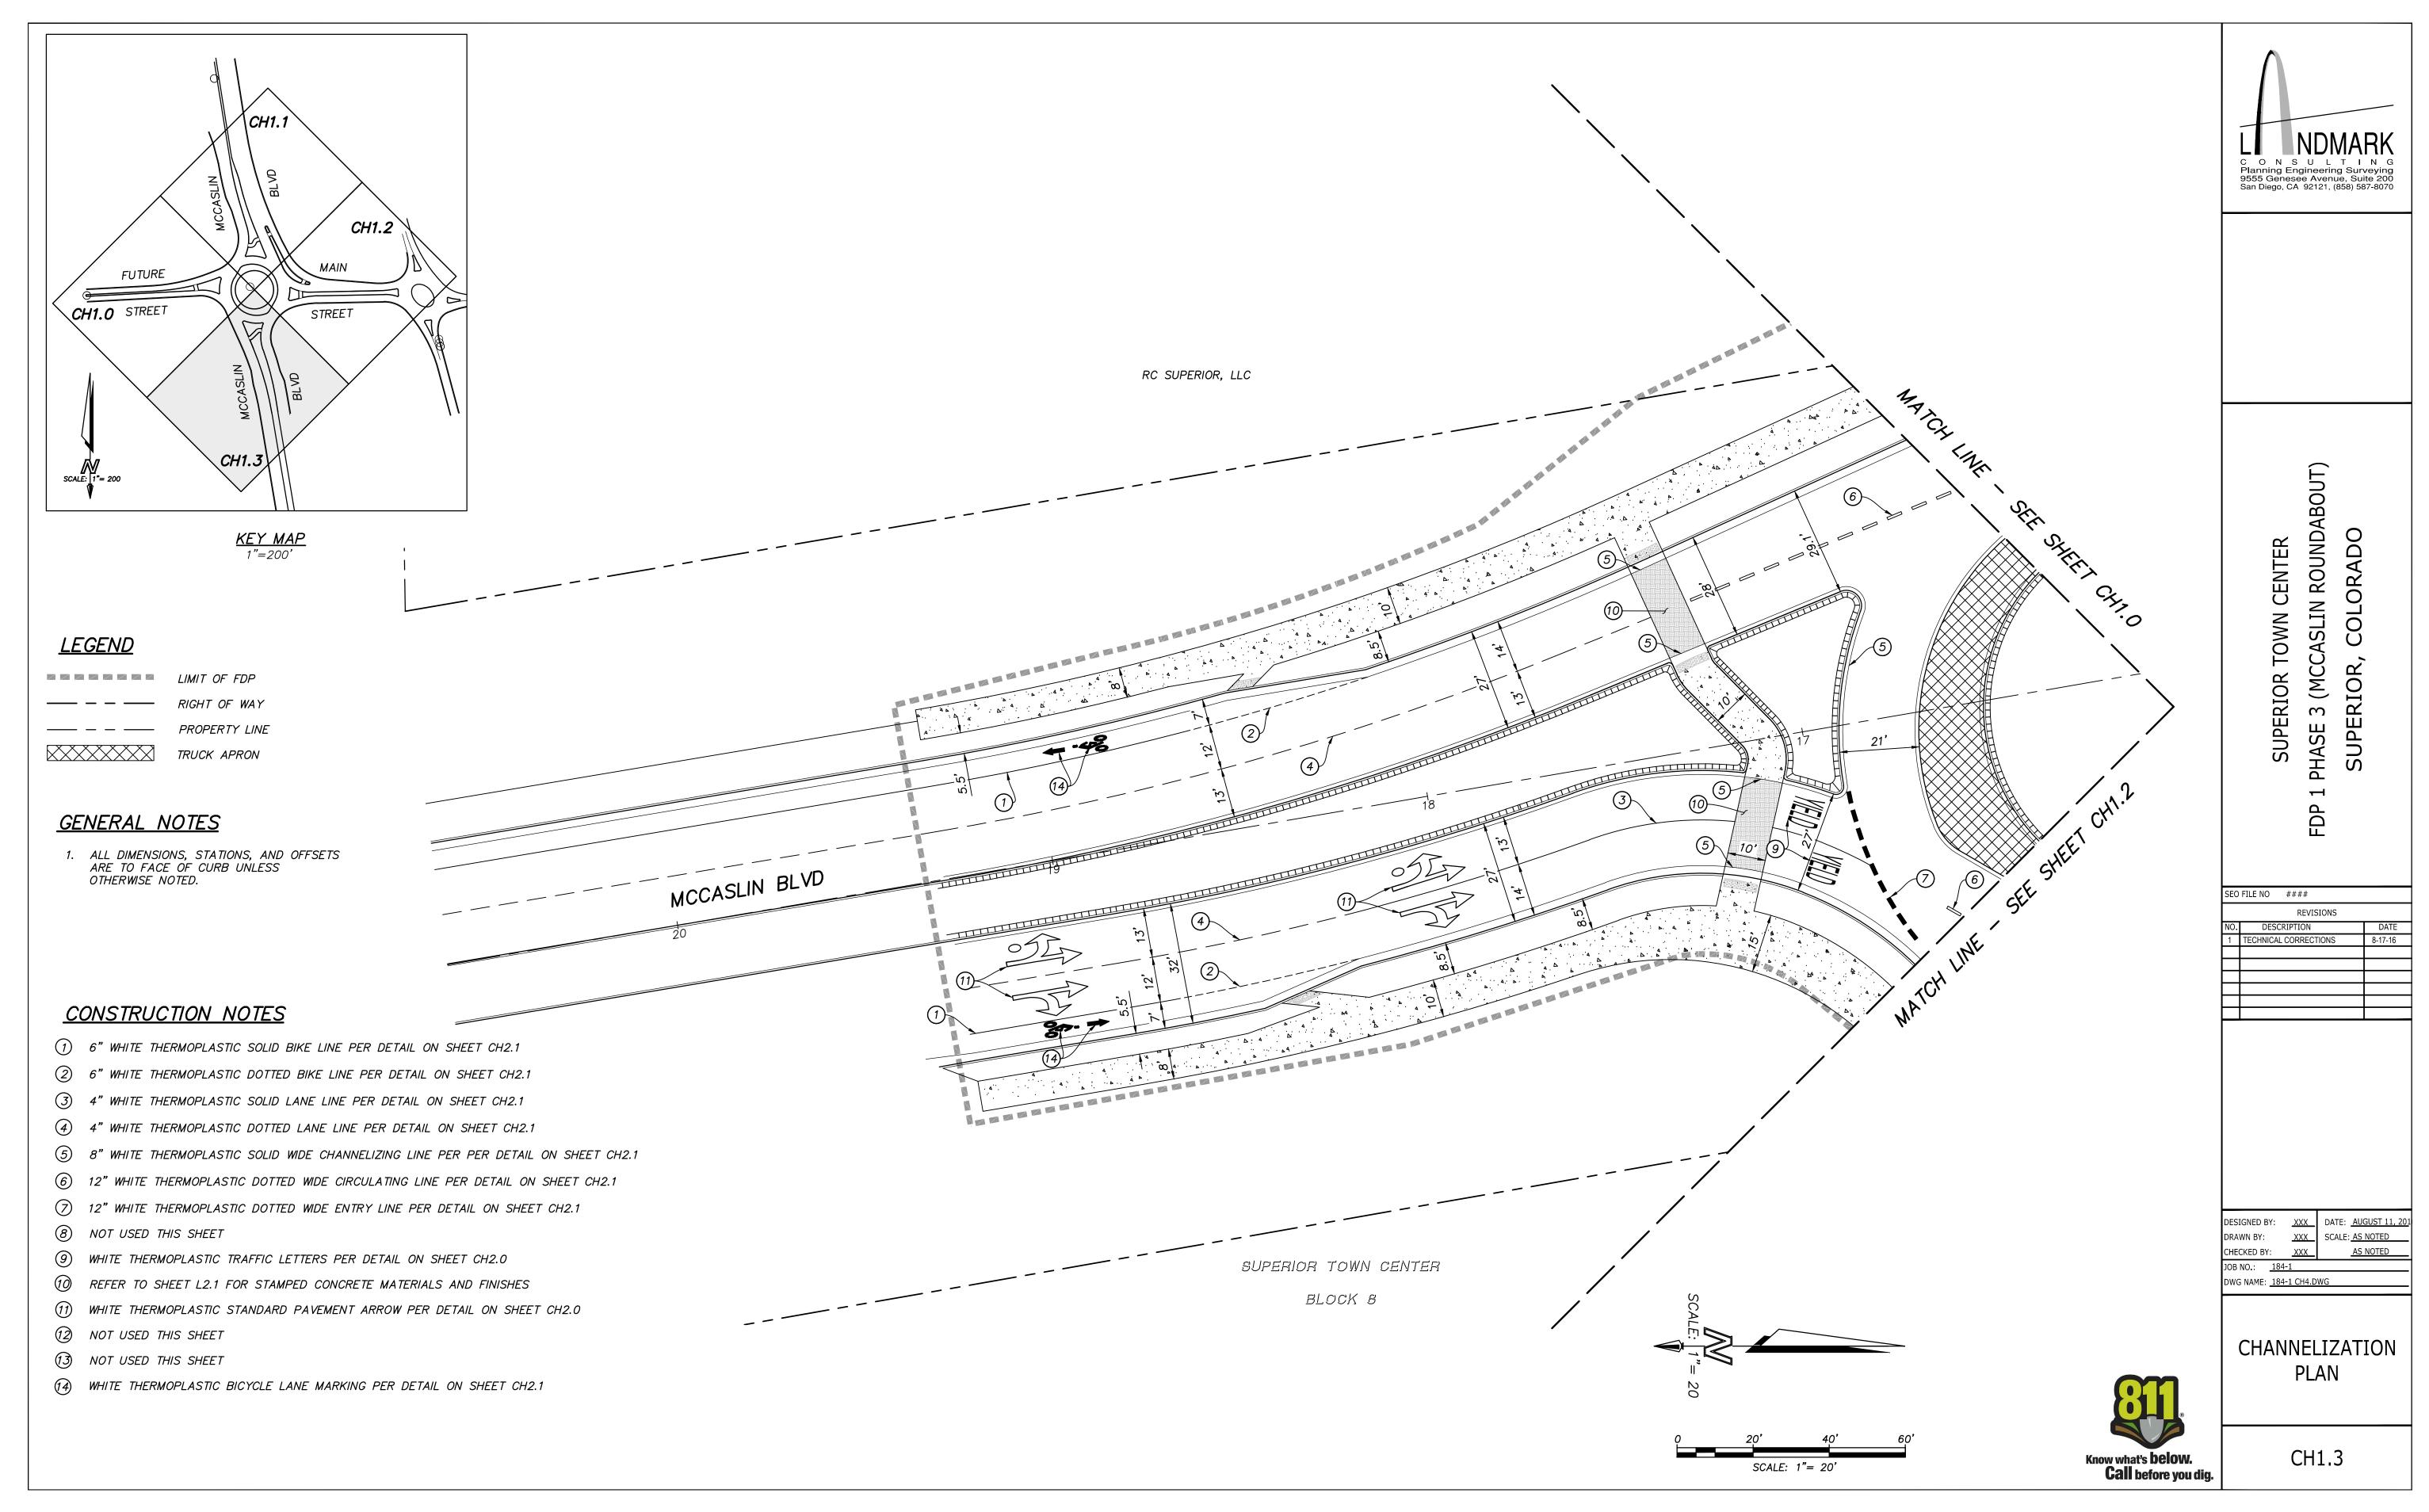


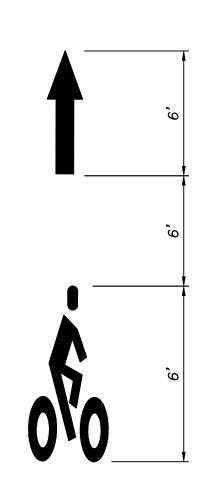


BICYCLE LANE MARKING PER CODOT FIGURE 14-10

WHITE THERMOPLASTIC BICYCLE SYMBOL

NOT TO SCALE

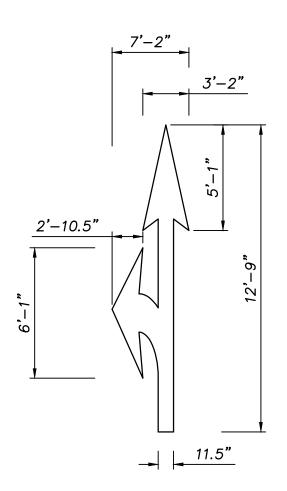

CIRCULATING TRAFFIC ARROW SEE STANDARD PLAN CODOT S-627-1 SHEET 5

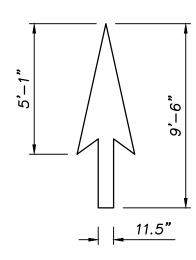



CIRCULATING STANDARD LOW SPEED ARROW SEE STANDARD PLAN CODOT S-627-1 SHEET 5


THERMOPLASTIC CIRCULATING TRAFFIC ARROWS


NOT TO SCALE

NOTE: ALL DIMENSIONS IN FEET

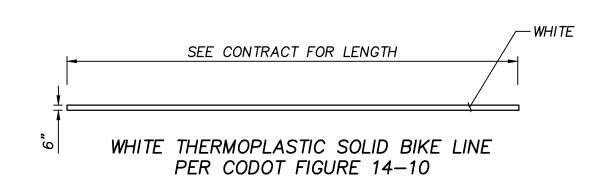

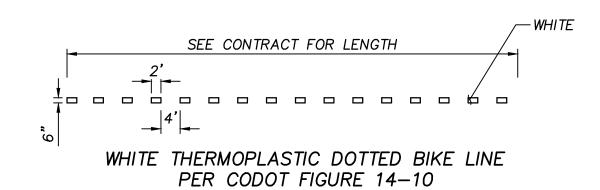


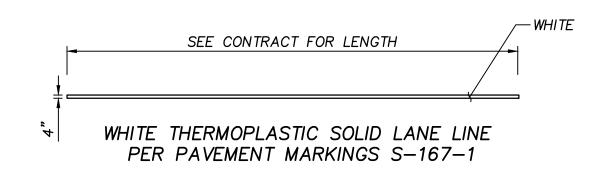


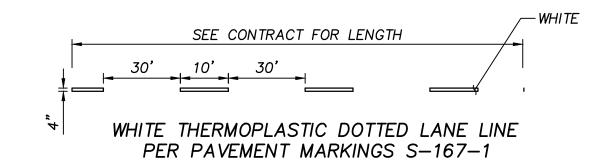



WHITE THERMOPLASTIC SOLID WIDE CHANNELIZING LINE PER PAVEMENT MARKINGS S-627-1

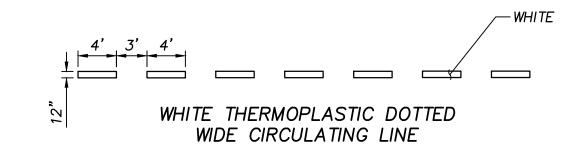

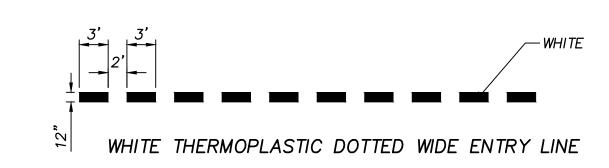





SUPERIOR TOWN CENTER
FDP 1 PHASE 3 (MCCASLIN ROUNDABOUT)
SUPERIOR, COLORADO

SEO	FILE NO ####	
	REVISIONS	
VO.	DESCRIPTION	DATE

DESIGNED BY: XXX DATE: AUG. 12, 2016

DRAWN BY: XXX SCALE: AS NOTED

CHECKED BY: XXX AS NOTED


JOB NO.: 184-1


DWG NAME: 184-1 CD2.DWG

CHANNELIZATION DETAILS

CH2.1



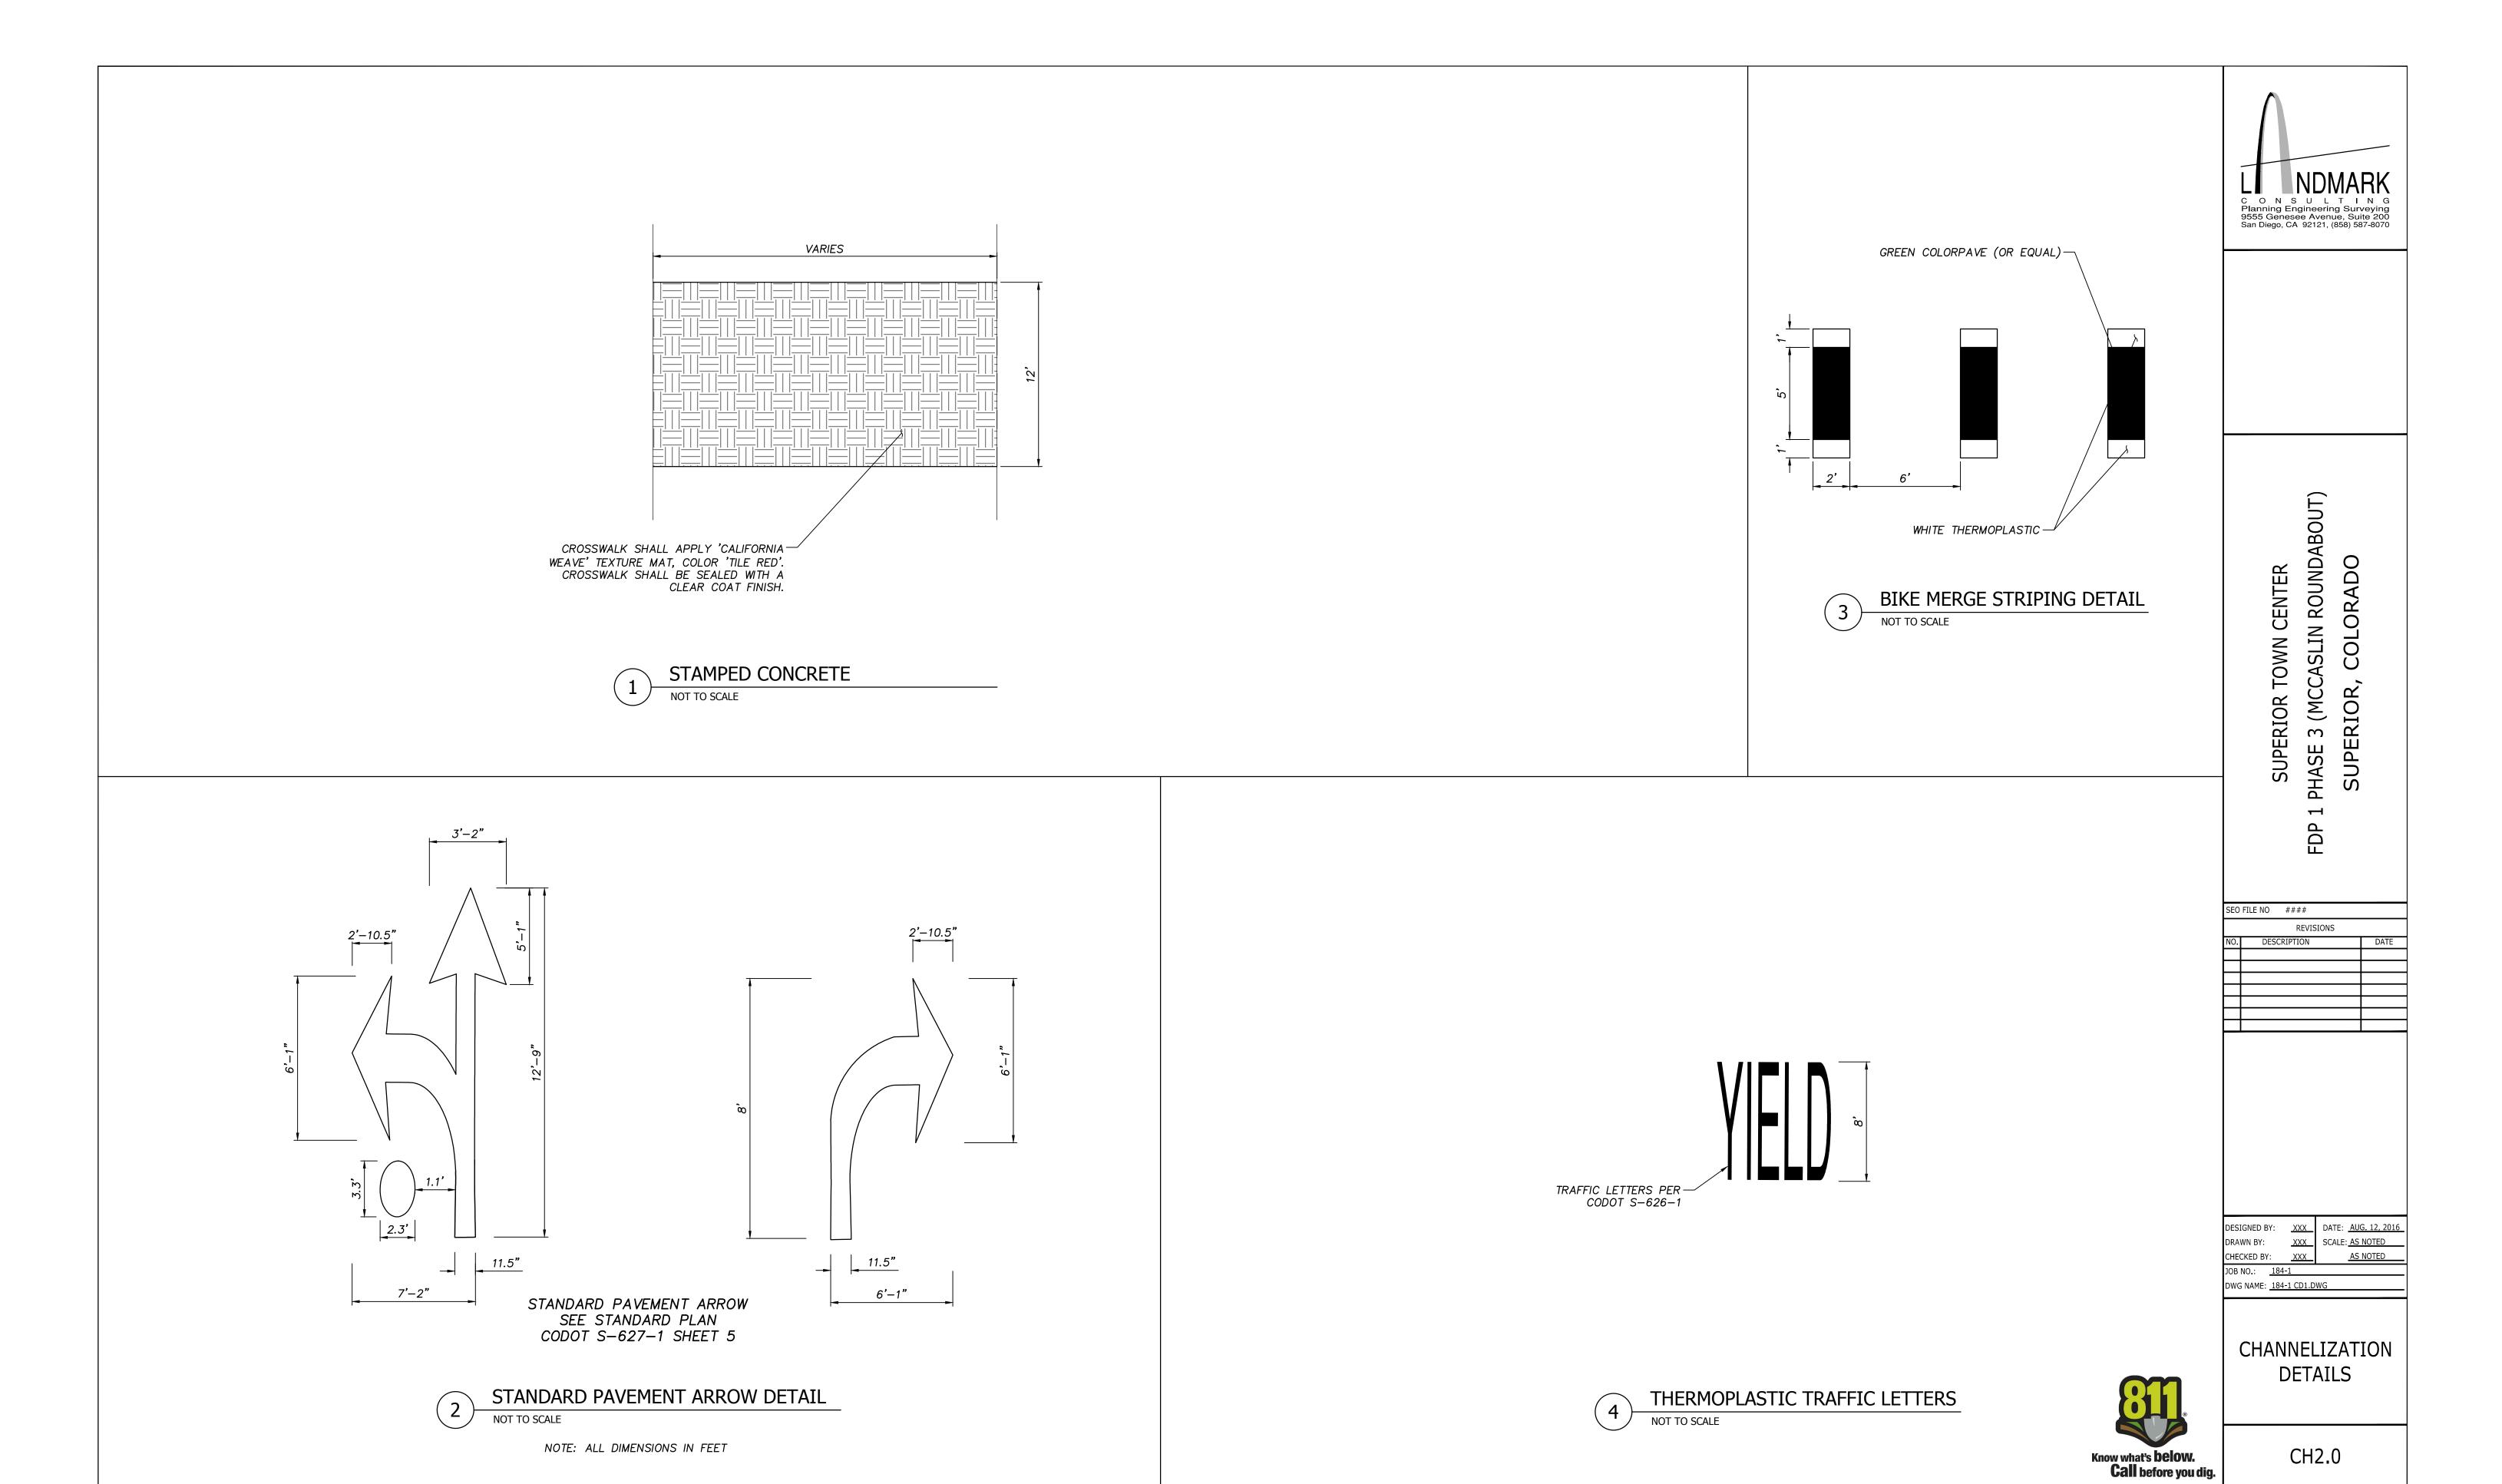

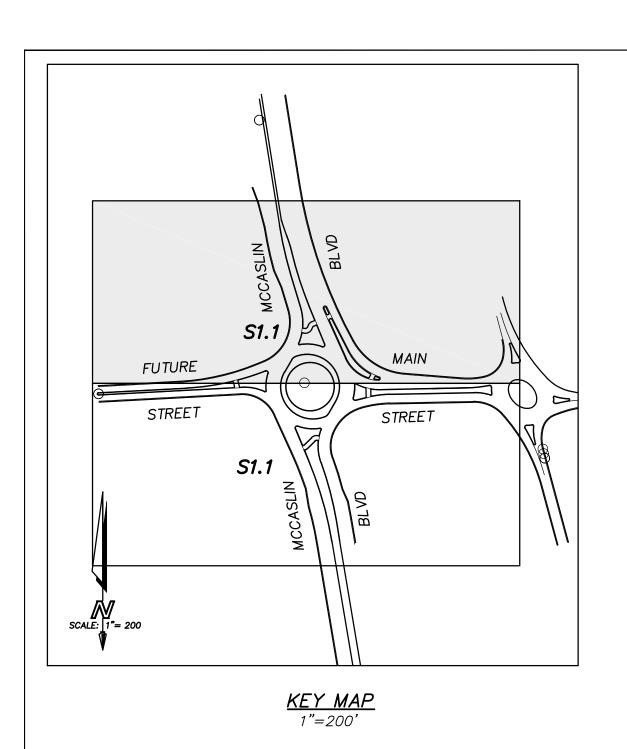

GENERAL NOTES

- 1. SIGN POST LOCATIONS SHALL BE APPROVED BY ENGINEER PRIOR TO EXCAVATION
- 2. SEE SHEET SD1 FOR SIGN SCHEDULE AND SIGN DETAILS
- 3. SIGN POSTS SHALL BE STEEL SIGN SUPPORT TYPE ____ PER ___
- 4. TRAFFIC SIGNS SHALL BE PER MUTCD, EXCEPT AS NOTED

<u>LEGEND</u>

PROPOSED SIGN

LIMIT OF FDP

- - RIGHT OF WAY

---- PROPERTY LINE

SUPERIOR TOWN CENTER
FDP 1 PHASE 3 (MCCASLIN ROUNDABOUT)
SUPERIOR, COLORADO

C O N S U L T I N G Planning Engineering Surveying 9555 Genesee Avenue, Suite 200 San Diego, CA 92121, (858) 587-8070

SEO FI	LE NO ####	
	REVISIONS	
NO.	DESCRIPTION	
\perp		
_		_





DESIGNED BY:		XXX	DATE:	AUG. 12, 2016
DRAWN BY:		XXX	SCALE:	AS NOTED
CHECKED BY:		XXX_		AS NOTED
JOB NO.:	184-1			
DWG NAME:	184-1	S1 DW	/G	

SIGNING PLAN

Know what's **below. Call** before you dig.

S1.0

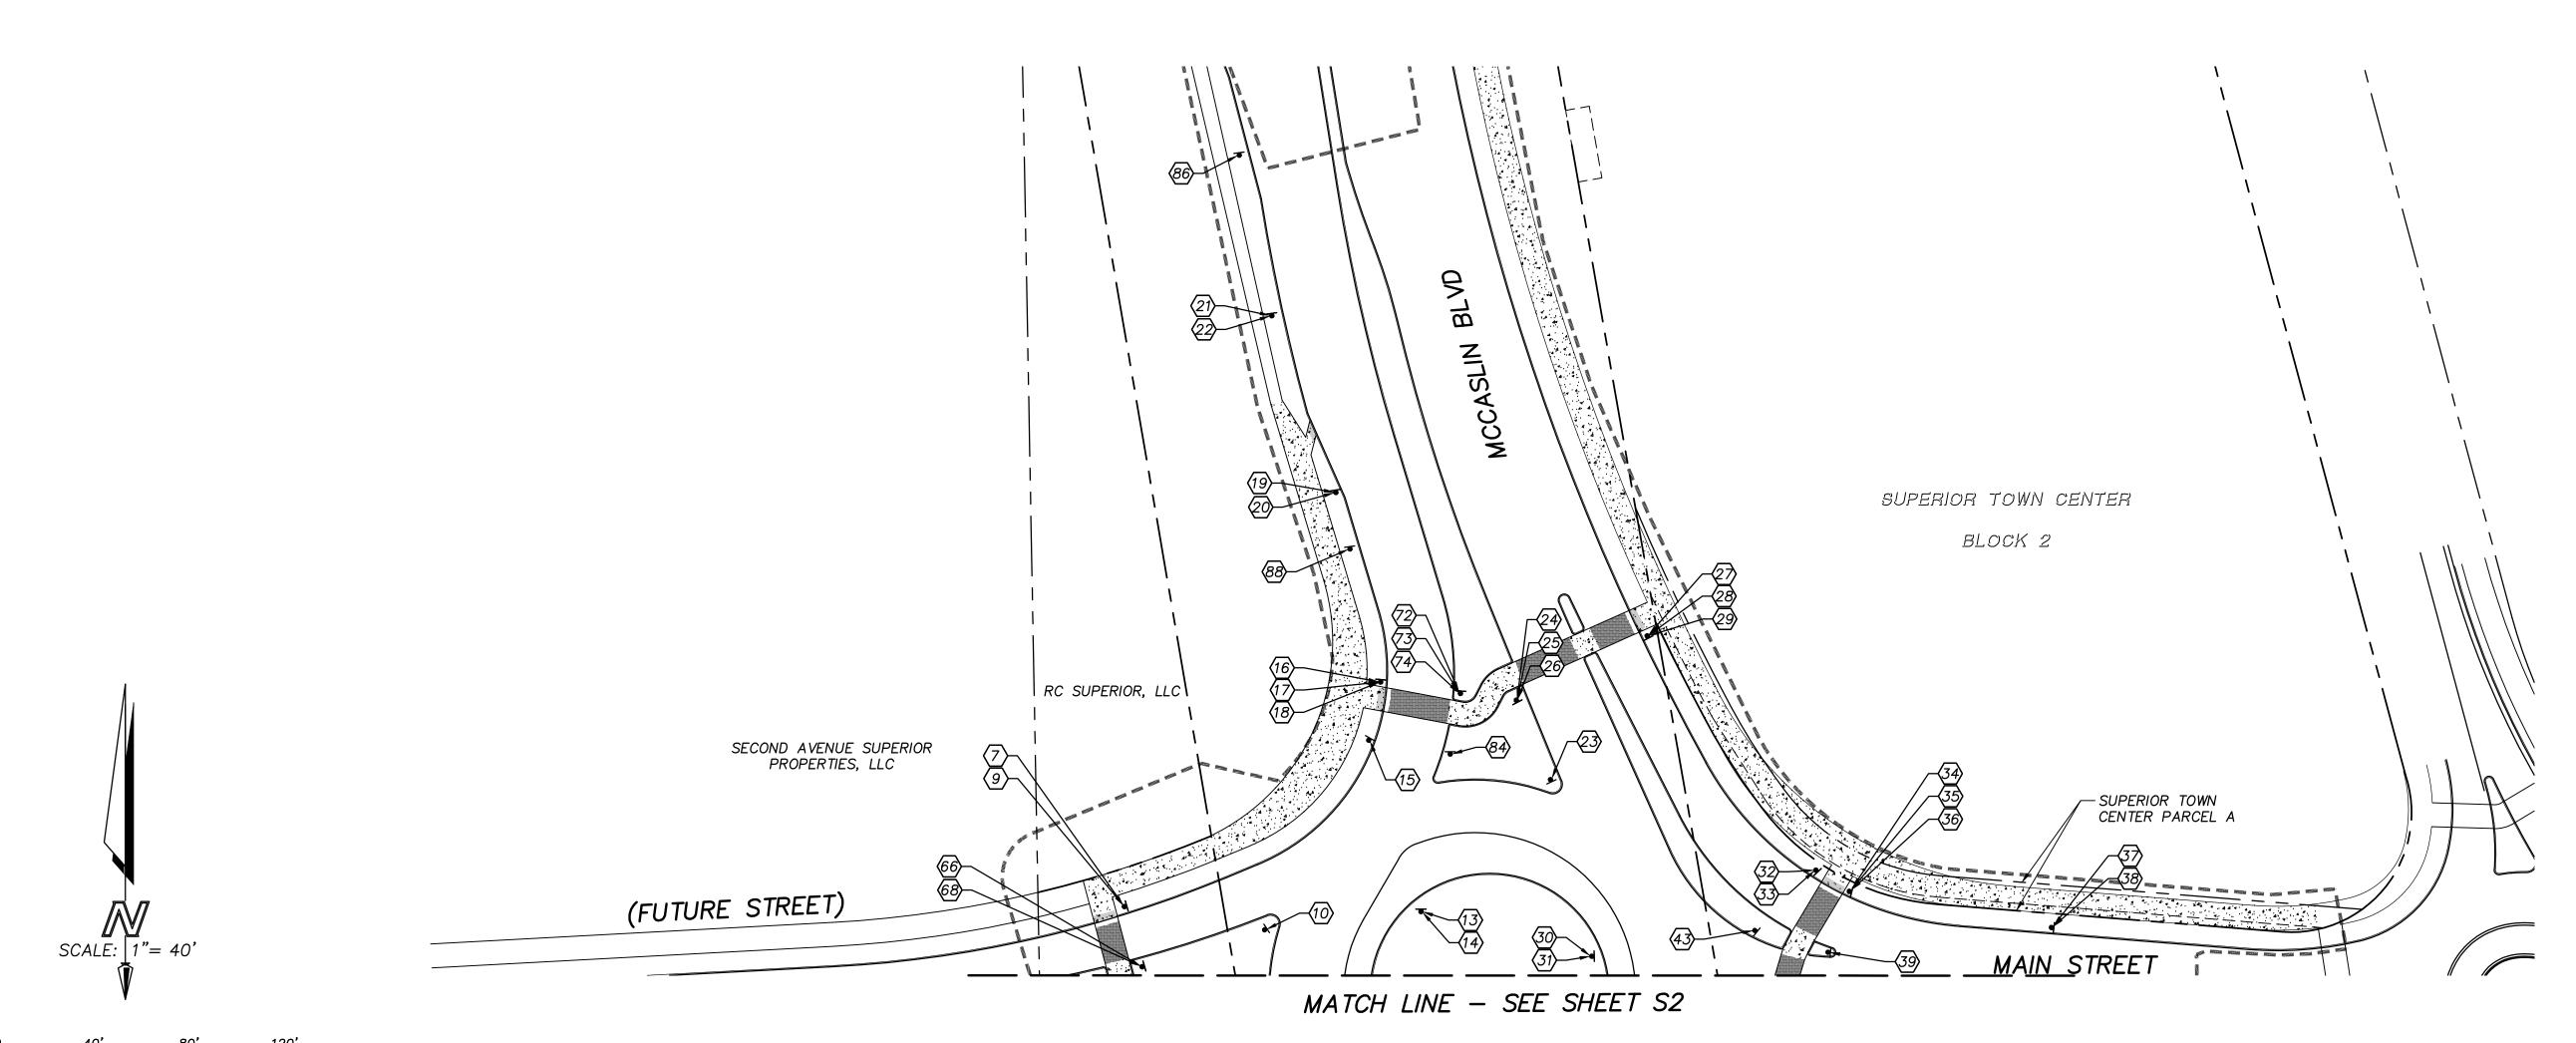

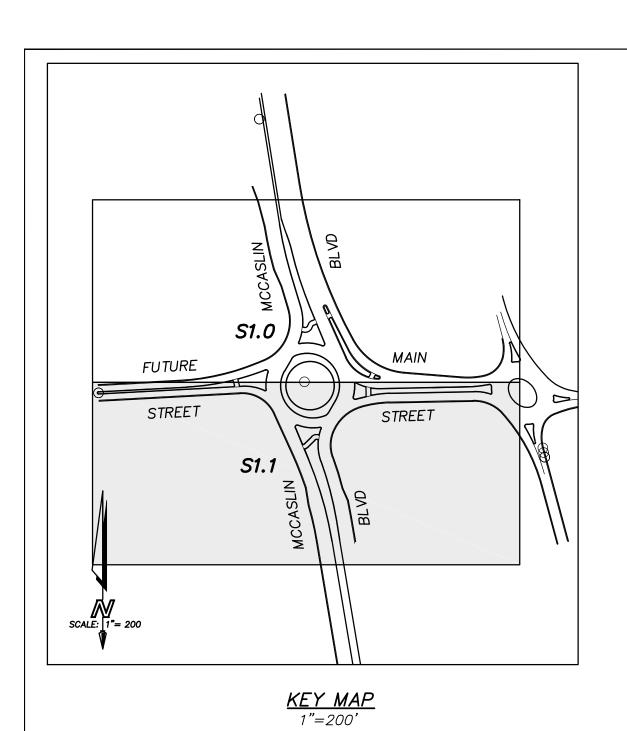

SCALE: 1"= 40'

GENERAL NOTES

- 1. SIGN POST LOCATIONS SHALL BE APPROVED BY ENGINEER PRIOR TO EXCAVATION
- 2. SEE SHEET SD2.0 FOR SIGN SCHEDULE AND SIGN DETAILS
- 3. SIGN POSTS SHALL BE STEEL SIGN SUPPORT TYPE ____ PER ___
- 4. TRAFFIC SIGNS SHALL BE PER MUTCD, EXCEPT AS NOTED

<u>LEGEND</u>

PROPOSED SIGN

LIMIT OF FDP

- - - RIGHT OF WAY

---- PROPERTY LINE

SUPERIOR TOWN CENTER
FDP 1 PHASE 3 (MCCASLIN ROUNDABOUT)
SUPERIOR, COLORADO

C O N S U L T I N G Planning Engineering Surveying 9555 Genesee Avenue, Suite 200 San Diego, CA 92121, (858) 587-8070


SEO	FILE NO #	###		
		REVISIO	NS	
NO.	DESCRI	PTION	ĺ	[

DESIGNED BY: XXX DATE: AUG. 12, 201
DRAWN BY: XXX SCALE: AS NOTED
CHECKED BY: XXX AS NOTED

DWG NAME: <u>184-1 S2.DWG</u>

SIGNING PLAN

Know what's **below. Call** before you dig.

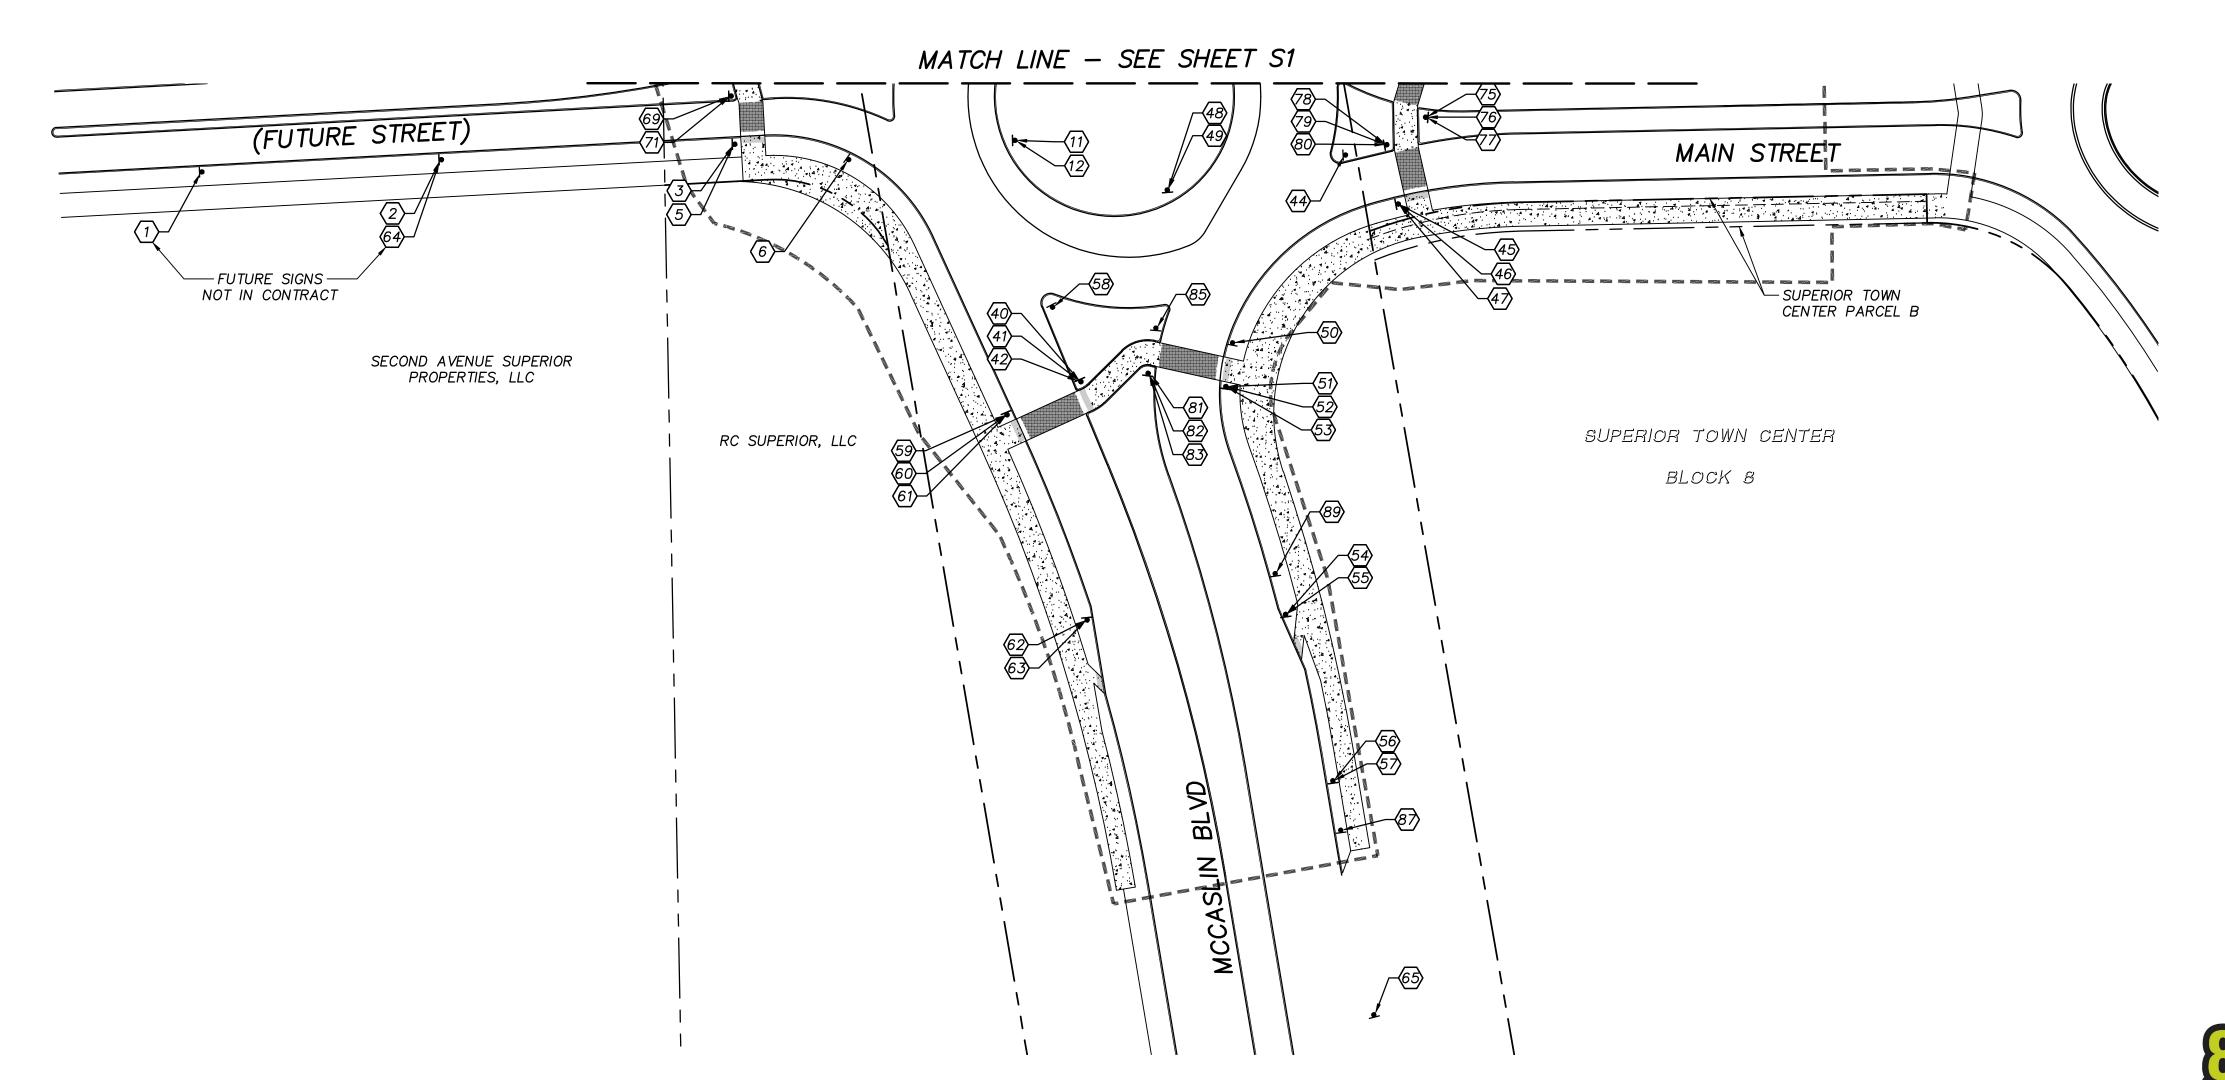

SIGN SCHEDULE							
SIGN #	STATION	OFFSET	SIGN TYPE	SIGN SIZE	POST INFO	DESCRIPTION	REMARKS
1	0+59.50	19.68 R	R3-8	36"X36"		ADVANCED ROUNDABOUT SIGN	FUTURE (NIC)
2	1+59.38	19.95 R	W2-6	36"X36"		CIRCULAR INTERSECTION	FUTURE (NIC)
3	2+81.79	20.06 R	W16-7P (LEFT)	24"X12"		ADVANCED SUPPLEMENTAL ARROW	PROPOSED
4						NOT USED	,
5	2+81.79	20.06 R	W11-2	30"X30"		ADVANCED PEDESTRIAN CROSSING	PROPOSED
6	3+28.86	28.99 R	R1-2	30"X30"		YIELD	PROPOSED
7	2+90.37	35.60 L	W16-7P (LEFT)	30"X30"		ADVANCED SUPPLEMENTAL ARROW	PROPOSED
8						NOT USED	
9	2+90.37	35.60 L	W11-2	30"X30"		ADVANCED PEDESTRIAN CROSSING	PROPOSED
10	3+48.37	22.74 L	STANDARD	48"X9"		(FUTURE STREET)	FUTURE (NIC)
11	3+98.44	24.68 R	R6-4(A)	12"X24"		CHEVRON	PROPOSED
12	3+98.44	24.68 R	R6-1 (RIGHT)	12"X24"		ONE WAY	PROPOSED
13	15+64.32	12.48 R	R6-4(A)	12"X24"		CHEVRON	PROPOSED
14	15+64.32	12.48 R	R6-1 (RIGHT)	12"X24"		ONE WAY	PROPOSED
15	14+90.07	21.88 R	R1-2	30"X30"		YIELD	PROPOSED
16	14+66.95	12.87 R	W16-7P (LEFT)	24"X12"		ADVANCED SUPPLEMENTAL ARROW	PROPOSED
17	14+66.95	12.87 R	RRFB-XL	7"X3"		RECTANGULAR RAPID FLASH BEACON	PROPOSED
18	14+66.95	12.87 R	W11-2	30"X30"		ADVANCED PEDESTRIAN CROSSING	PROPOSED
19	13+85.74	17.86 R	R3-17BP	30"X12"		BIKE LANE SUPPLEMENTAL ENDS	PROPOSED
20	13+85.74	17.86 R	R3-17	30"X24"		BIKE LANE	PROPOSED
21	13+08.43	31.73 R	W13-1	24"X24"		20 MPH	PROPOSED
22	13+08.43	31.73 R	W2-6	36"X36"		CIRCULAR INTERSECTION	PROPOSED
23	15+19.15	50.19 L	STANDARD	48"X9"		MCCASLIN BLVD.	PROPOSED
24	14+84.05	41.76 L	W16-7P (RIGHT)	24"X12"		ADVANCED SUPPLEMENTAL ARROW	PROPOSED
25	14+84.05	41.76 L	RRFB-XL	7"X3"		RECTANGULAR RAPID FLASH BEACON	PROPOSED
26	14+84.05	41.76 L	W11-2	30"X30"		ADVANCED PEDESTRIAN CROSSING	PROPOSED
27	14+66.86	100.21 L	W16-7P (LEFT)	24"X12"		ADVANCED SUPPLEMENTAL ARROW	PROPOSED
28	14+66.86	100.21 L	RRFB-XL	0"X3"		RECTANGULAR RAPID FLASH BEACON	PROPOSED
29	14+66.86	100.21 L	W11-2	30"X30"		ADVANCED PEDESTRIAN CROSSING	PROPOSED
30	0+44.99	10.72 L	R6-4(A)	12"X24"		CHEVRON	PROPOSED
31	0+44.99	10.72 L	R6-1 (RIGHT)	12"X24"		ONE WAY	PROPOSED
32	1+36.40	52.01 L	R3-17	30"X24"		BIKE LANE	PROPOSED
33	1+36.40	52.01 L	R3-17B	30"X12"		BIKE LANE SUPPLEMENTAL AHEAD	PROPOSED
34	1+50.85	43.97 L	W16-7P (LEFT)	24"X12"		ADVANCED SUPPLEMENTAL ARROW	PROPOSED
<i>3</i> 5	1+50.85	43.97 L	RRFB-XL	7"X3"		RECTANGULAR RAPID FLASH BEACON	PROPOSED
36	1+50.85	43.97 L	W11-2	30"X30"		ADVANCED PEDESTRIAN CROSSING	PROPOSED
37	2+36.06	33.81 L	W13-1	24"X24"		20 MPH	PROPOSED
38	2+36.06	33.81 L	W2-6	36"X36"		CIRCULAR INTERSECTION	PROPOSED
39	1+43.44	18.08 L	W12-1	30"X30"		DOUBLE ARROW	PROPOSED
40	17+17.44	23.88 R	W16-7P (RIGHT)	24"X12"		ADVANCED SUPPLEMENTAL ARROW	PROPOSED
41	17+17.44	23.88 R	RRFB-XL	7"X3"		RECTANGULAR RAPID FLASH BEACON	PROPOSED
42	17+17.44	23.88 R	W11-2	30"X30"		ADVANCED PEDESTRIAN CROSSING	PROPOSED
43	1+12.38	25.40 L	R1-2	30"X30"		YIELD	PROPOSED
44	1+00.76	25.85 R	STANDARD	48"X9"		MAIN STREET	PROPOSED
45	1+23.83	44.97 R	W16-7P (LEFT)	24"X12"		ADVANCED SUPPLEMENTAL ARROW	PROPOSED

SIGN SCHEDULE							
SIGN	# STATION	OFFSET	SIGN TYPE	SIGN SIZE	POST INFO	DESCRIPTION	REMARKS
46	1+23.83	44.97 R	RRFB-XL	7"X3"		RECTANGULAR RAPID FLASH BEACON	PROPOSED
47	1+23.83	44.97 R	W11-2	30"X30"		ADVANCED PEDESTRIAN CROSSING	PROPOSED
48	16+44.85	25.11 L	R6-4(A)	12"X24"		CHEVRON	PROPOSED
49	16+44.85	25.11 L	R6-1 (RIGHT)	12"X24"		ONE WAY	PROPOSED
50	17+12.20	41.12 L	R1-2	30"X30"		YIELD	PROPOSED
51	17+29.68	35.30 L	W16-7P (LEFT)	24"X12"		ADVANCED SUPPLEMENTAL ARROW	PROPOSED
52	17+29.68	35.30 L	RRFB-XL	7"X3"		RECTANGULAR RAPID FLASH BEACON	PROPOSED
53	17+29.68	35.30 L	W11-2	30"X30"		ADVANCED PEDESTRIAN CROSSING	PROPOSED
54	18+27.49	43.73 L	R3-17BP	30"X12"		BIKE LANE SUPPLEMENTAL ENDS	PROPOSED
55	18+27.49	43.73 L	R3-17	30"X24"		BIKE LANE	PROPOSED
56	18+99.08	51.40 L	W13-1	24"X24"		20 MPH	PROPOSED
57	18+99.08	51.40 L	W2-6	36"X36"		CIRCULAR INTERSECTION	PROPOSED
58	16+84.86	30.28 R	STANDARD	48"X9"		MCCASLIN BLVD.	PROPOSED
59	17+25.83	56.58 R	W16-7P (LEFT)	24"X12"		ADVANCED SUPPLEMENTAL ARROW	PROPOSED
60	17+25.83	56.58 R	RRFB-XL	7"X3"		RECTANGULAR RAPID FLASH BEACON	PROPOSED
61	17+25.83	56.58 R	W11-2	30"X30"		ADVANCED PEDESTRIAN CROSSING	PROPOSED
62	18+15.75	38.16 R	R3-17B	30"X12"		BIKE LANE SUPPLEMENTAL AHEAD	PROPOSED
63	18+15.75	38.16 R	R3-17	30"X24"		BIKE LANE	PROPOSED
64	1+59.38	19.95 R	W13-1	24"X24"		20 MPH	PROPOSED
65	19+98.08	51.70 L	R3-8	36"X36"		ADVANCED ROUNDABOUT SIGN	PROPOSED
66	2+96.41	10.09 L	W16-7P (RIGHT)	30"X30"		ADVANCED SUPPLEMENTAL ARROW	PROPOSED
67						NOT USED	
68	2+96.41	10.09 L	W11-2	30"X30"		ADVANCED PEDESTRIAN CROSSING	PROPOSED
69	2+81.36	0.07 L	W16-7P (RIGHT)	24"X12"		ADVANCED SUPPLEMENTAL ARROW	PROPOSED
70						NOT USED	
71	2+81.36	0.07 L	W11-2	30"X30"		ADVANCED PEDESTRIAN CROSSING	PROPOSED
72	14+77.31	19.20 L	W16-7P (LEFT)	24"X12"		ADVANCED SUPPLEMENTAL ARROW	PROPOSED
73	14+77.31	19.20 L	RRFB-XL	7"X3"		RECTANGULAR RAPID FLASH BEACON	PROPOSED
74	14+77.31	19.20 L	W11-2	30"X30"		ADVANCED PEDESTRIAN CROSSING	PROPOSED
75	1+33.15	8.22 R	W16-7P (RIGHT)	24"X12"		ADVANCED SUPPLEMENTAL ARROW	PROPOSED
76	1+33.15	8.22 R	RRFB-XL	7"X3"		RECTANGULAR RAPID FLASH BEACON	PROPOSED
77	1+33.15	8.22 R	W11-2	30"X30"		ADVANCED PEDESTRIAN CROSSING	PROPOSED
78	1+17.64	20.59 R	W16-7P (RIGHT)	24"X12"		ADVANCED SUPPLEMENTAL ARROW	PROPOSED
79	1+17.64	20.59 R	RRFB-XL	7"X3"		RECTANGULAR RAPID FLASH BEACON	PROPOSED
80	1+17.64	20.59 R	W11-2	30"X30"		ADVANCED PEDESTRIAN CROSSING	PROPOSED
81	17+18.79	4.30 L	W16-7P (RIGHT)	24"X12"		ADVANCED SUPPLEMENTAL ARROW	PROPOSED
82	17+18.79	4.30 L	RRFB-XL	7"X3"		RECTANGULAR RAPID FLASH BEACON	PROPOSED
83	17+18.79	4.30 L	W11-2	30"X30"		ADVANCED PEDESTRIAN CROSSING	PROPOSED
84	15+01.56	10.70 L	R1-2	30"X30"		YIELD	PROPOSED
85	17+00.75	10.68 L	R1-2	30"X30"		YIELD	PROPOSED
86	12+40.00	33.76 R	D1-5	48"X36"		ADVANCE LANE ASSIGNMENT	PROPOSED
87	19+20.00	51.12 L	D1-5	48"X36"		ADVANCE LANE ASSIGNMENT	PROPOSED
88	14+10.00	16.05 R	R3-8	36"X36"		LANE CONTROL	PROPOSED
89	18+10.00	42.35 L	R3-8	36"X36"		LANE CONTROL	PROPOSED





SUPERIOR TOWN CENTER
-DP 1 PHASE 3 (MCCASLIN ROUNDABOUT)
SUPERIOR, COLORADO

SEOTILE NO ####							
REVISIONS							
NO.	DESCRIPTION	DA					
1	TECHNICAL CORRECTIONS	8-17-1					

 DESIGNED BY:
 XXX
 DATE:
 August 11

 DRAWN BY:
 XXX
 SCALE:
 AS NOTED

 CHECKED BY:
 XXX
 AS NOTED


 JOB NO.:
 184-1

 DWG NAME:
 184-1 SD1.DWG

SIGNING SCHEDULE



S2.0

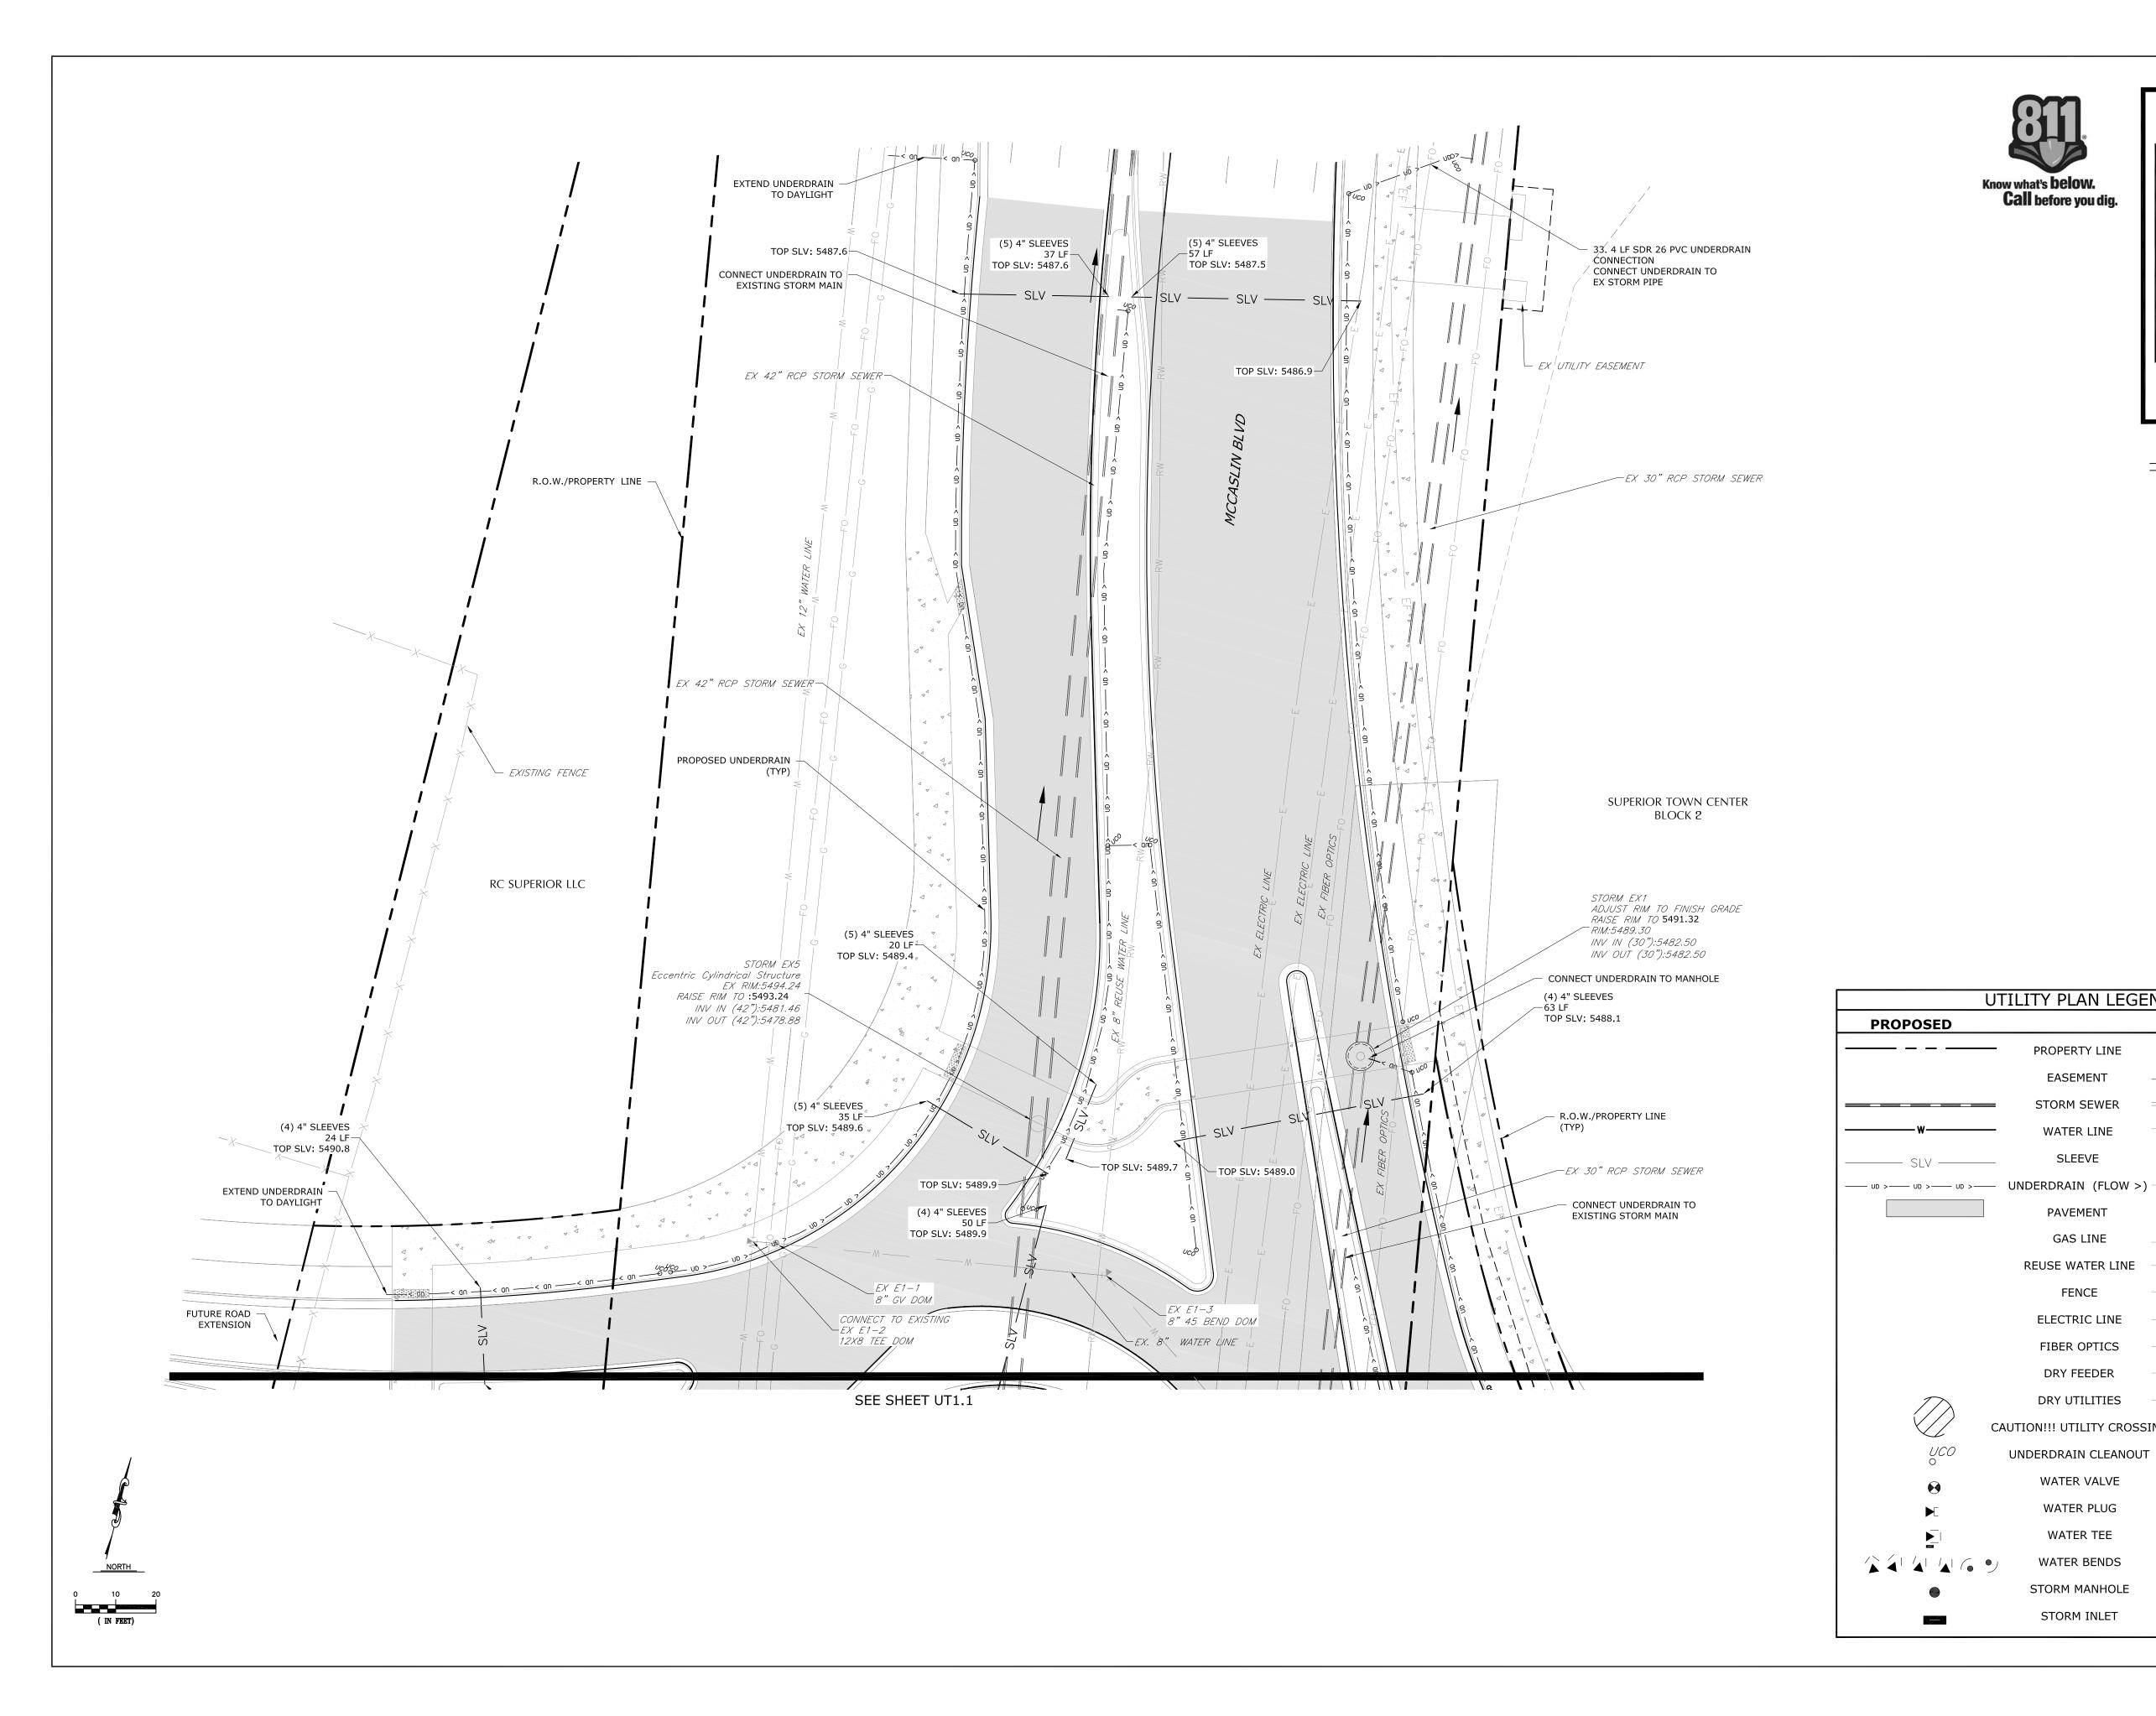



UTILITY PLAN LEGEND:

PROPERTY LINE

EASEMENT

STORM SEWER

WATER LINE

SLEEVE

PAVEMENT

GAS LINE

REUSE WATER LINE

FENCE

ELECTRIC LINE

FIBER OPTICS

DRY FEEDER

DRY UTILITIES

CAUTION!!! UTILITY CROSSING

UNDERDRAIN CLEANOUT

WATER VALVE

WATER PLUG

WATER TEE

WATER BENDS


STORM MANHOLE

STORM INLET

EXISTING

__ _ _ _ _ _

4 4 4 4

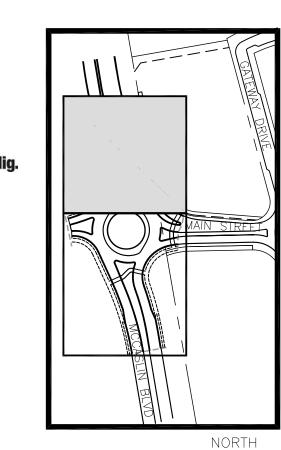



323 5th STREET P.O. Box 680 FREDERICK, CO 80530 303.833.1416 WWW.CIVILRESOURCES.COM


PLANS

	REVISIONS							
NO.	DESCRIPTION	V	DATE					
1	TECHNICAL CORRE	CTIONS	8/17/16					
c	TONES BY 14B	D.4.T.E. 0	C /20 /1 C					

DESIGNED BY: <u>JAB</u> DATE: <u>06/29/16</u> DRAWN BY: <u>CAI</u> SCALE<u>: 1"=20'</u> CHECKED BY: JAB JOB NO.: 228.001.04 DWG NAME<u>STC-FDP1-Ph3_Part_UTP.dwg</u>

PARTIAL UTILITY PLAN 1

UT1.0 SHEET 13 OF 25

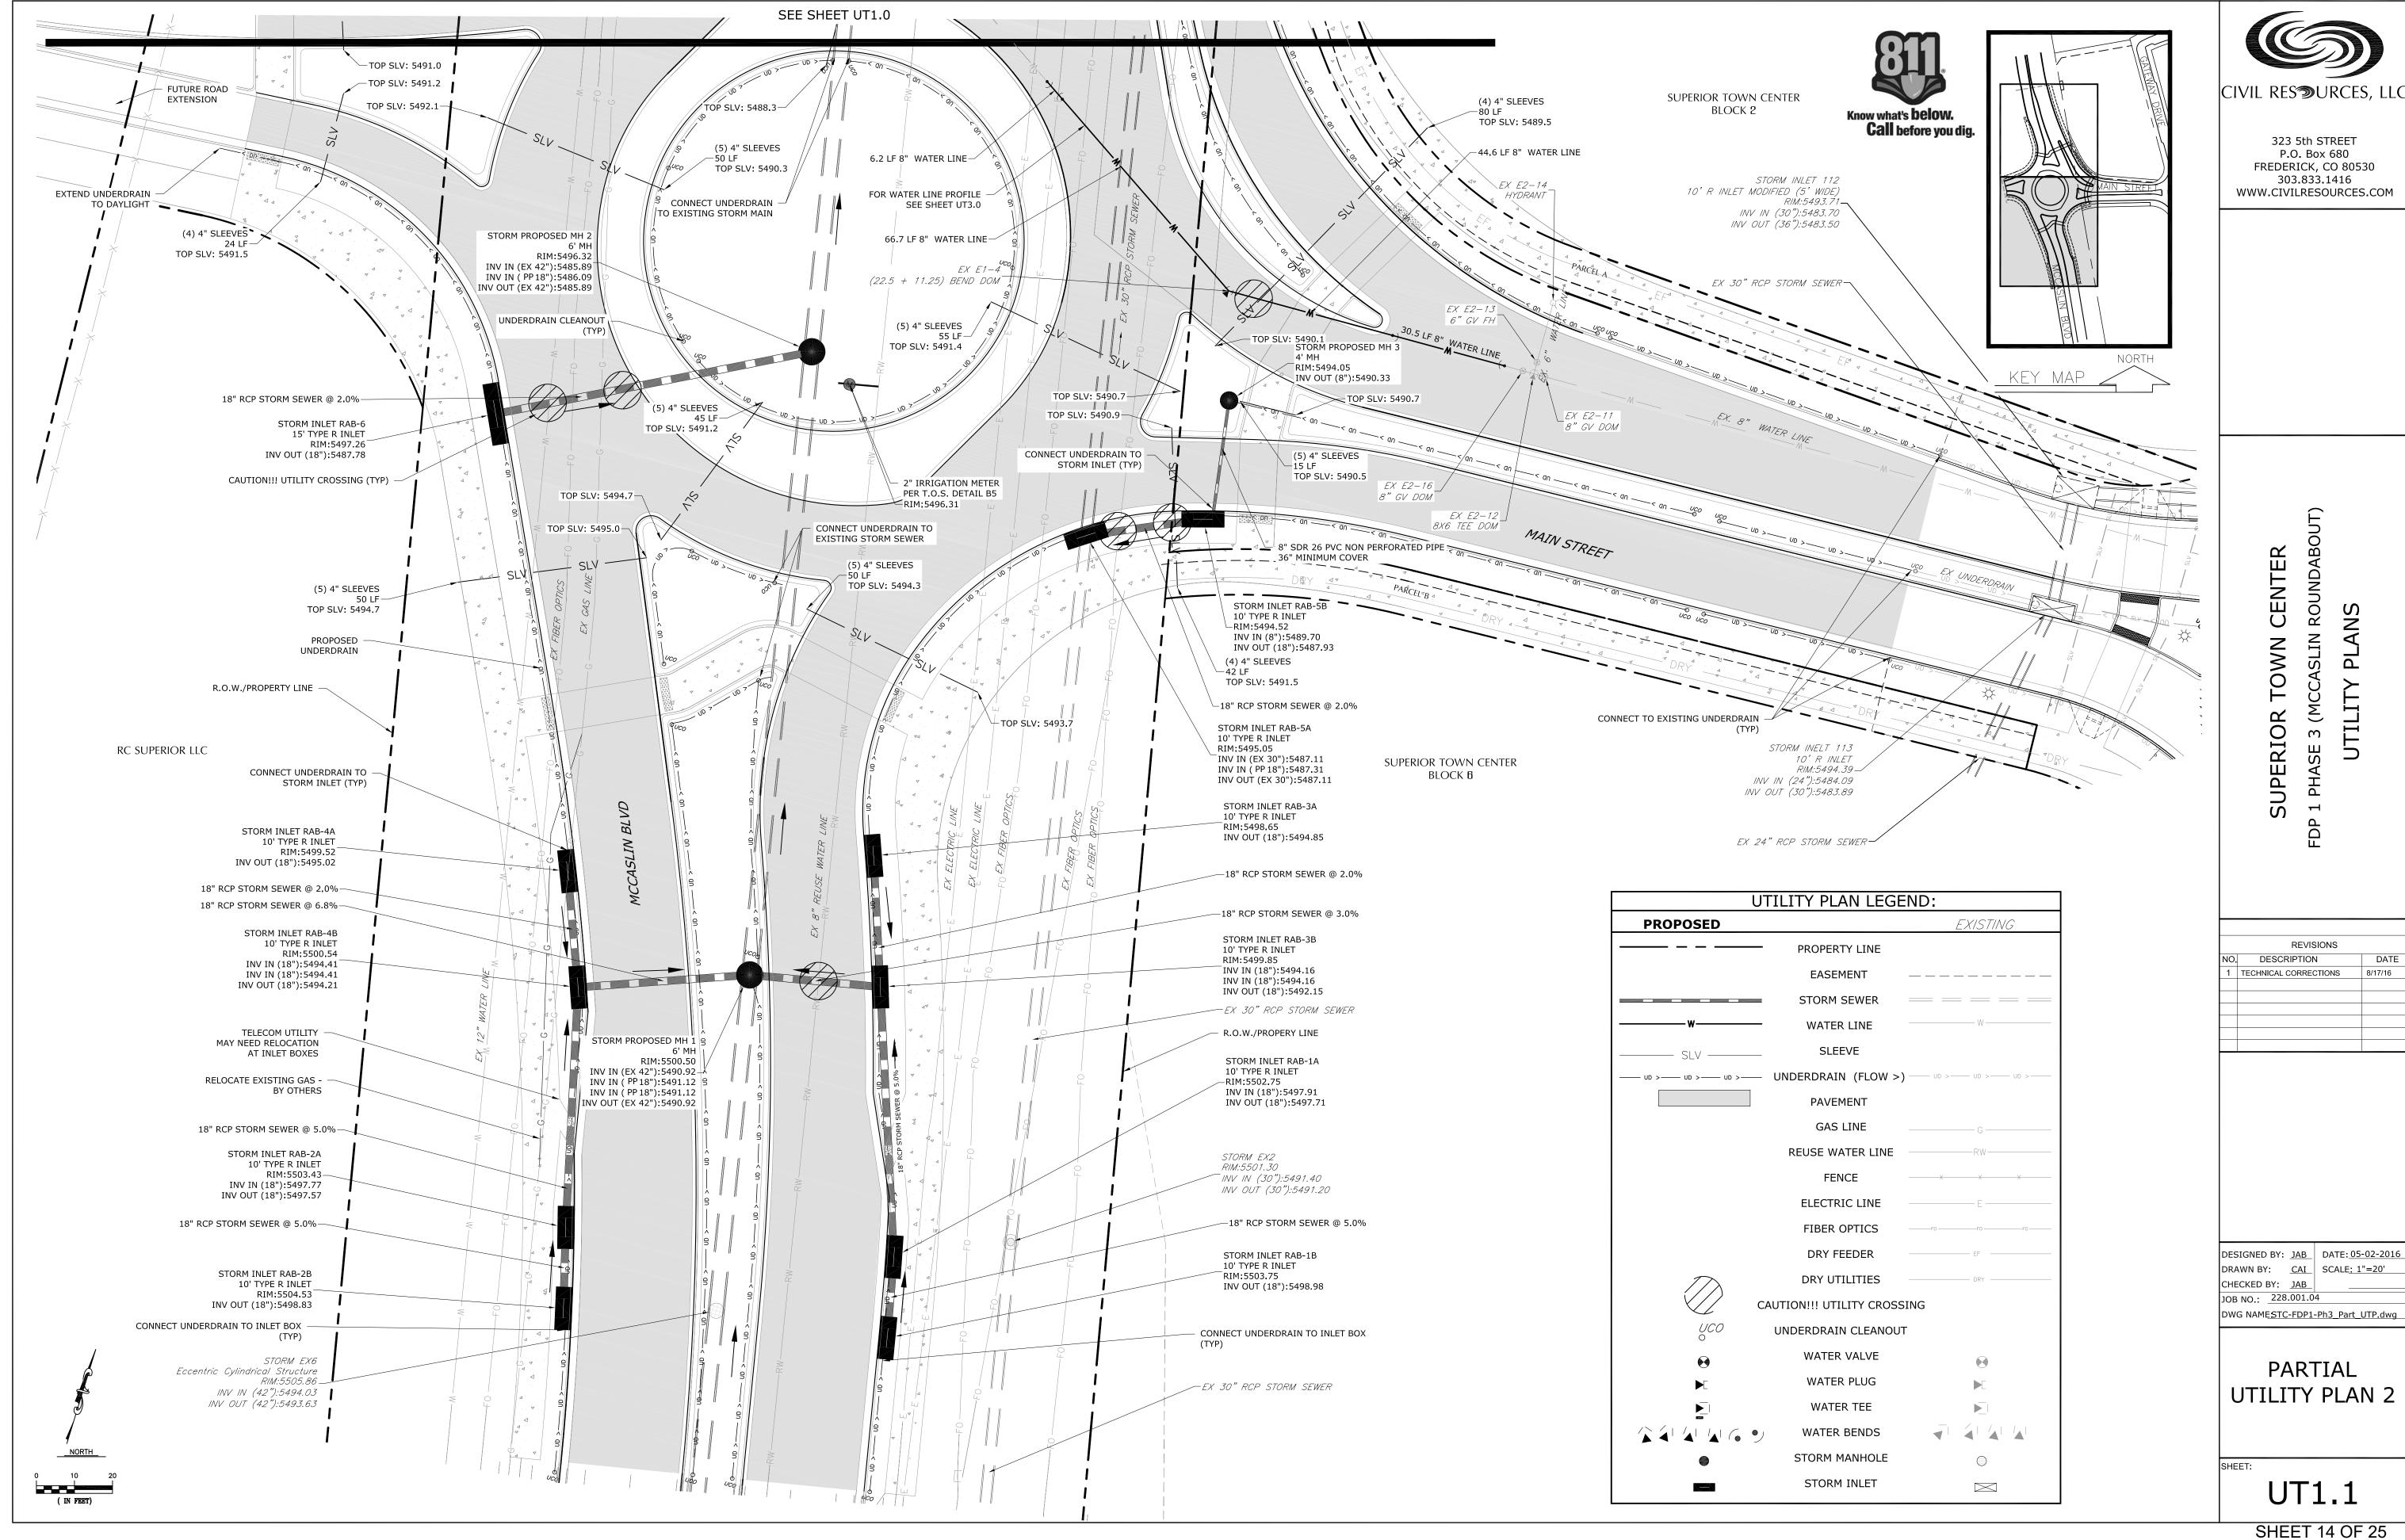



LIGHTING AND ELECTRICAL LEGEND

NEW SINGLE LED LUMINAIRE ON 28'16" LIGHT STANDARD BY XCEL ENERGY.


NEW TWIN LED LUMINAIRES 28'16" LIGHT STANDARD BY XCEL ENERGY.

FUTURE () FUTURE TWIN LED LUMINAIRES 28'16" LIGHT STANDARD BY XCEL ENERGY.

 $\bigcirc - \diamond - \bigcirc = \mathsf{EXISTING} \ \mathsf{LIGHT} \ \mathsf{STANDARD} \ \mathsf{TO} \ \mathsf{REMAIN}.$

HORIZONTAL ILLUMINANCE CALCULATION SUMMARY (fc)				
	avg	max	min	avg/min
ROAD SURFACE	1.45	3.5	0.2	7.25

VERTICAL ILLUMINANCE CALCULATION SUMMARY (fc)					
	avg	max	min	avg/min	
EAST CROSSWALK - EASTBOUND	1.15	1.6	0.6	1.92	
EAST CROSSWALK - WESTBOUND	1.76	2.7	0.7	2.51	
NORTH CROSSWALK - NORTHBOUND	0.82	1.3	0.3	2.73	
NORTH CROSSWALK - SOUTHBOUND	1.86	2.3	1.2	1.55	
SOUTH CROSSWALK - NORTHBOUND	1.69	2.1	1.3	1.30	
SOUTH CROSSWALK - SOUTHBOUND	1.07	1.2	0.9	1.19	
WEST CROSSWALK - EASTBOUND	2.31	2.5	2.0	1.16	
WEST CROSSWALK - WESTBOUND	0.58	0.8	0.4	1.45	

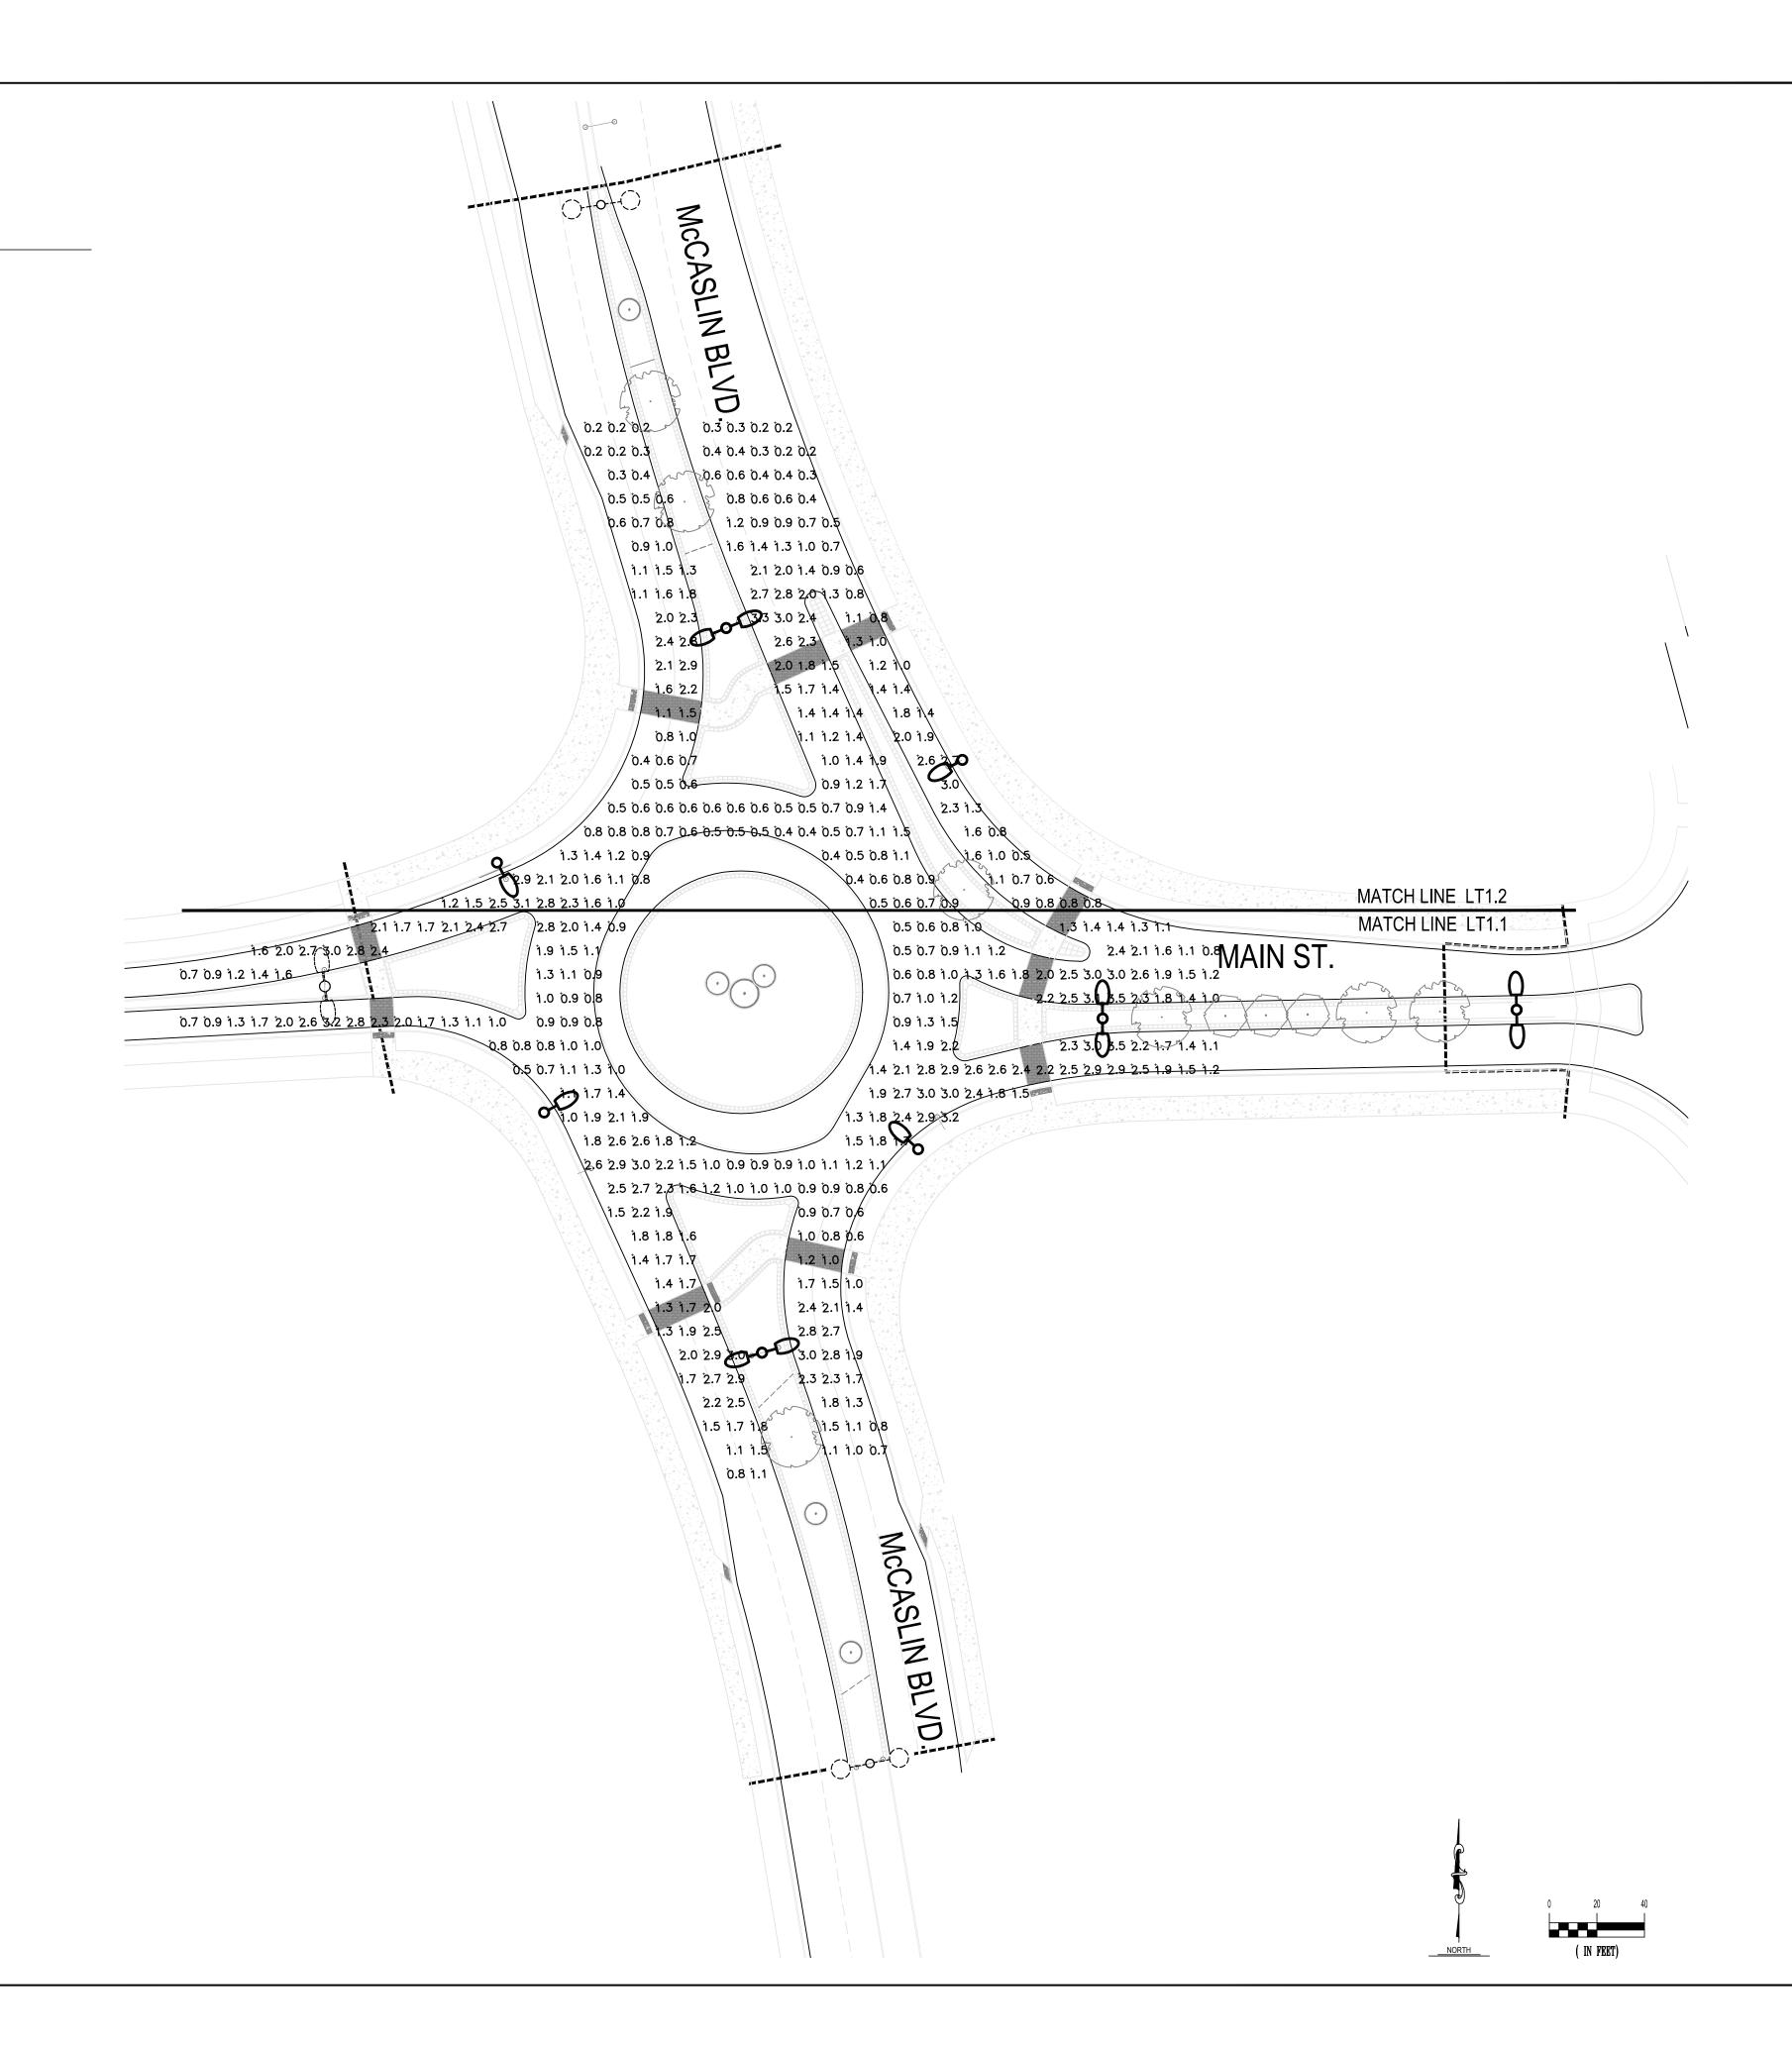

CLANTON & ASSOCIATES

LIGHTING DESIGN AND ENGINEERING
4699 NAUTILUS COURT SOUTH STE. 102
BOULDER, CO 80301
303-530-7229

SUPERIOR TOWN CENTER FDP 1 PHASE 3 (MCCASLIN ROUNDABOUT)

DESIGNED BY: AS DATE: 0□18-2016

DRAWN BY: JE SCALE: AS SHOWN

CHECKED BY: JW


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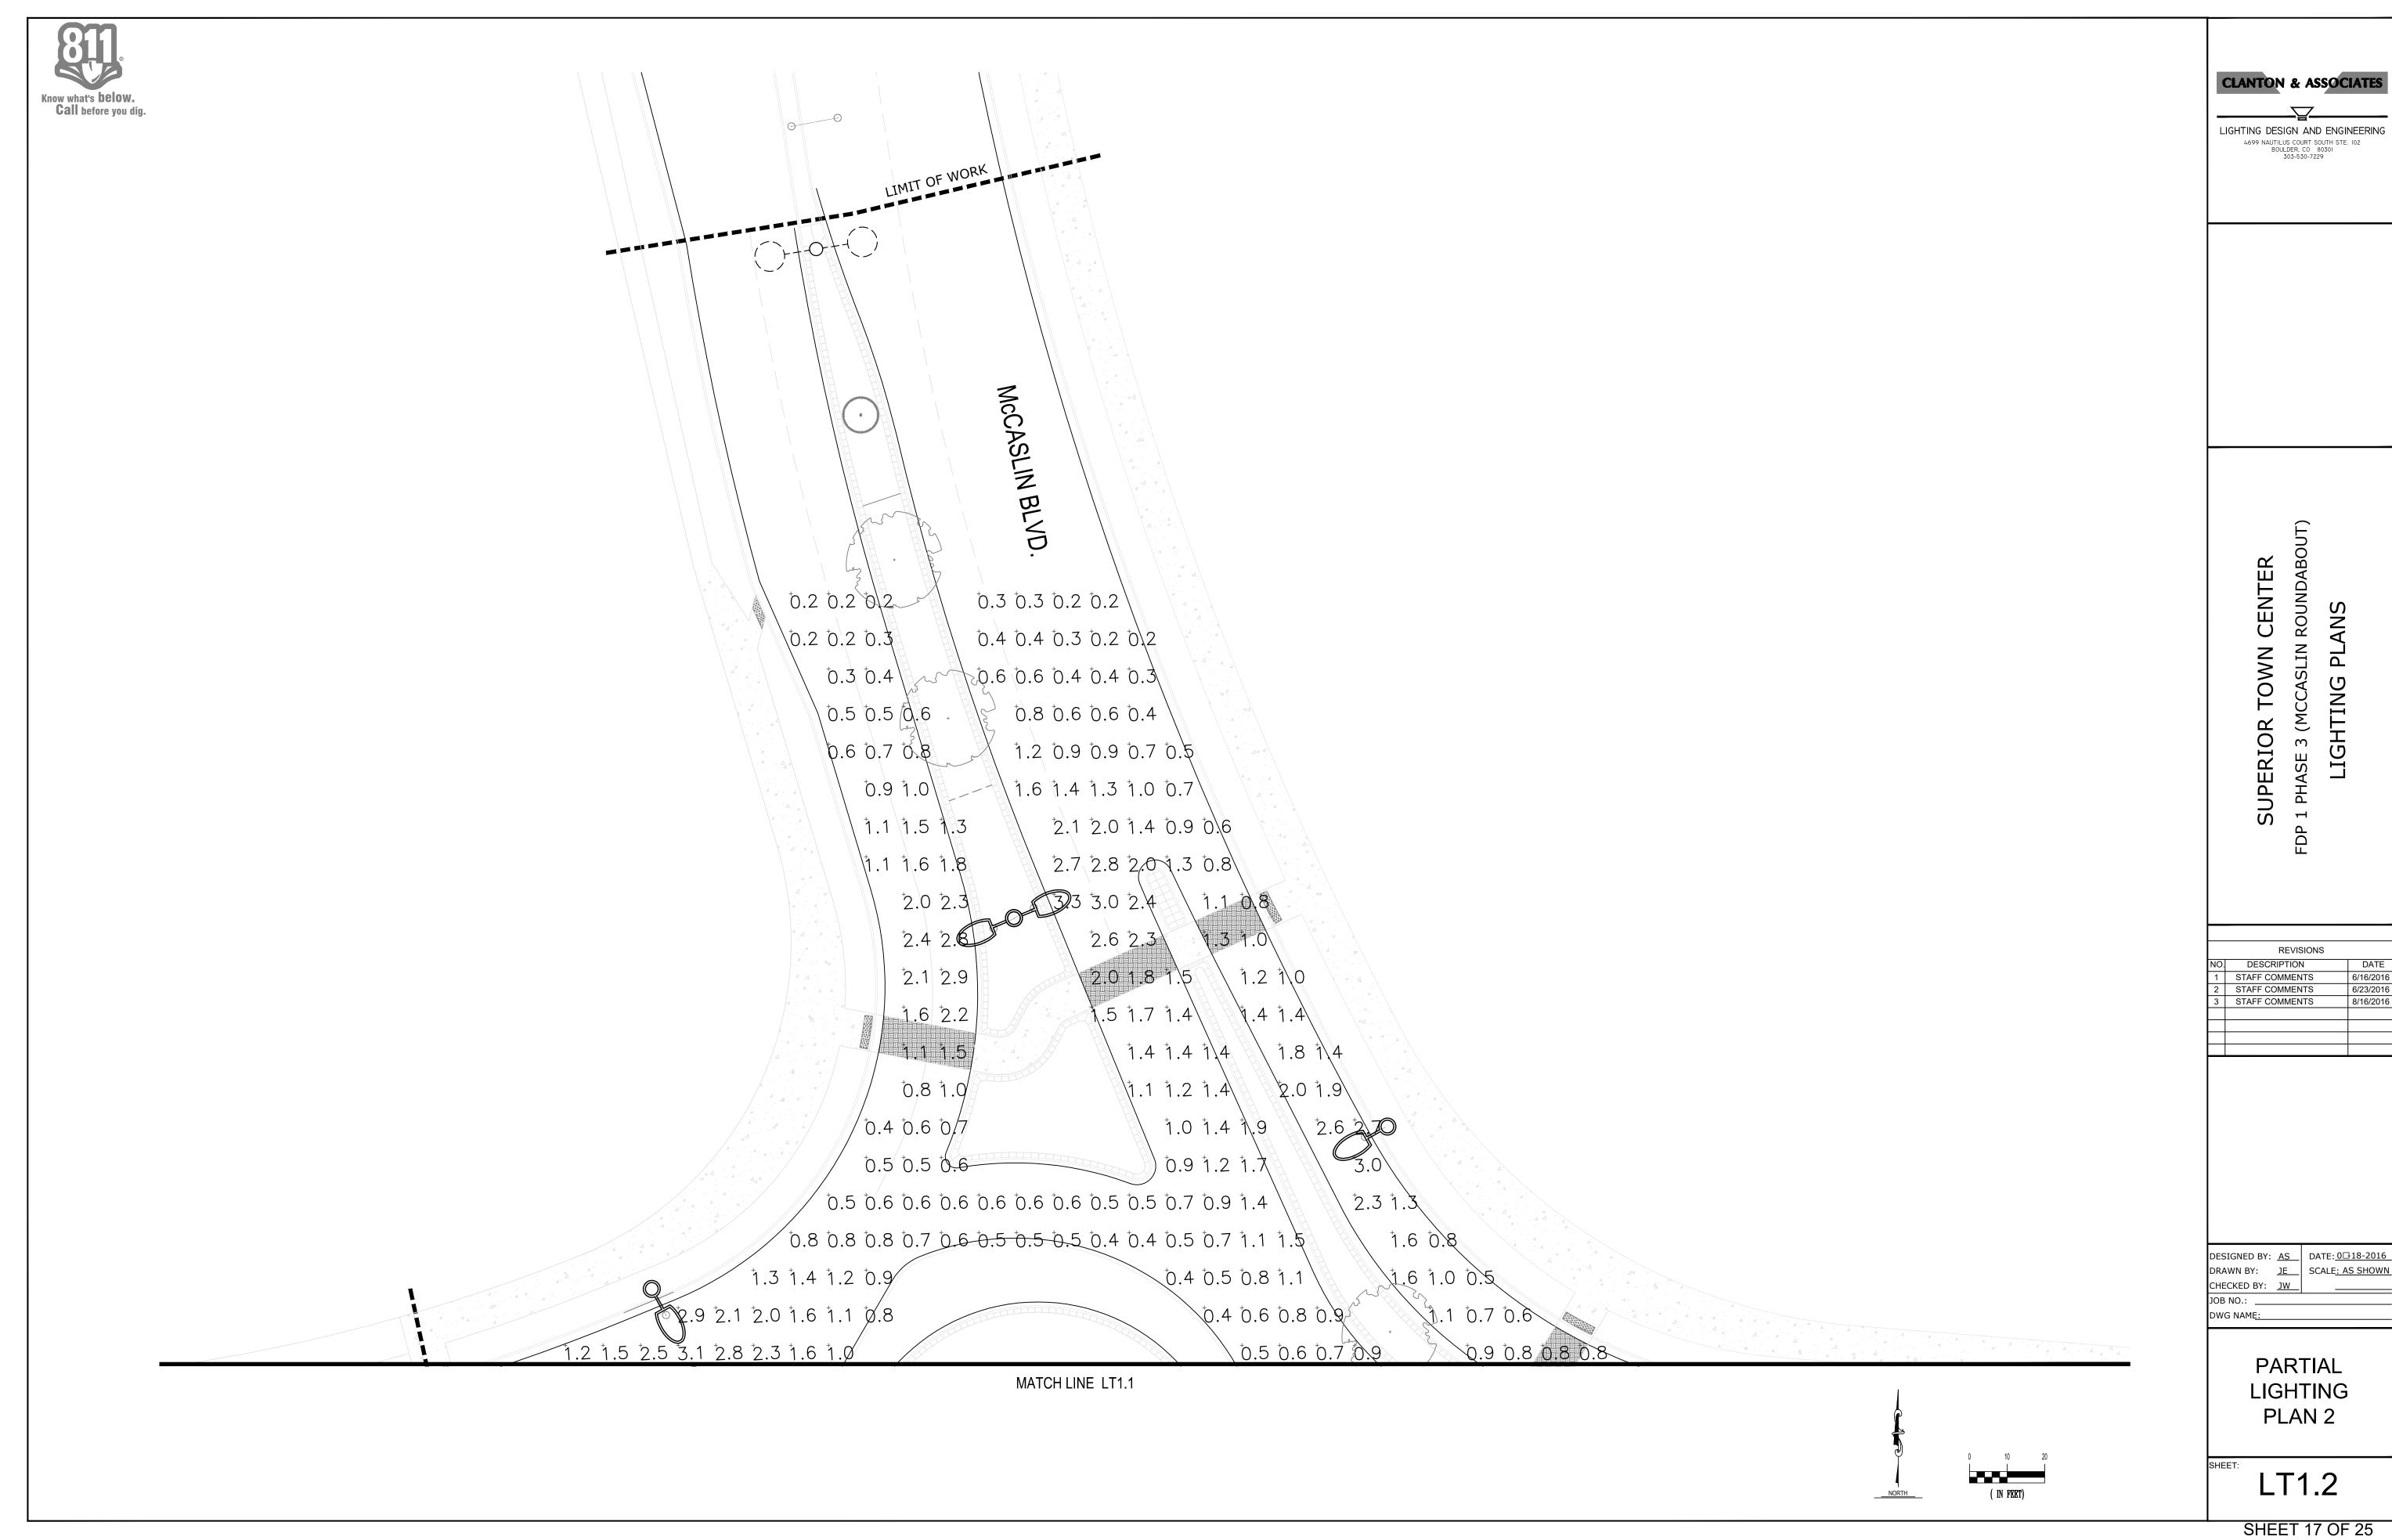
DWG NAME:

OVERALL LIGHTING PLAN

LT1.0


SHEET 15 OF 25



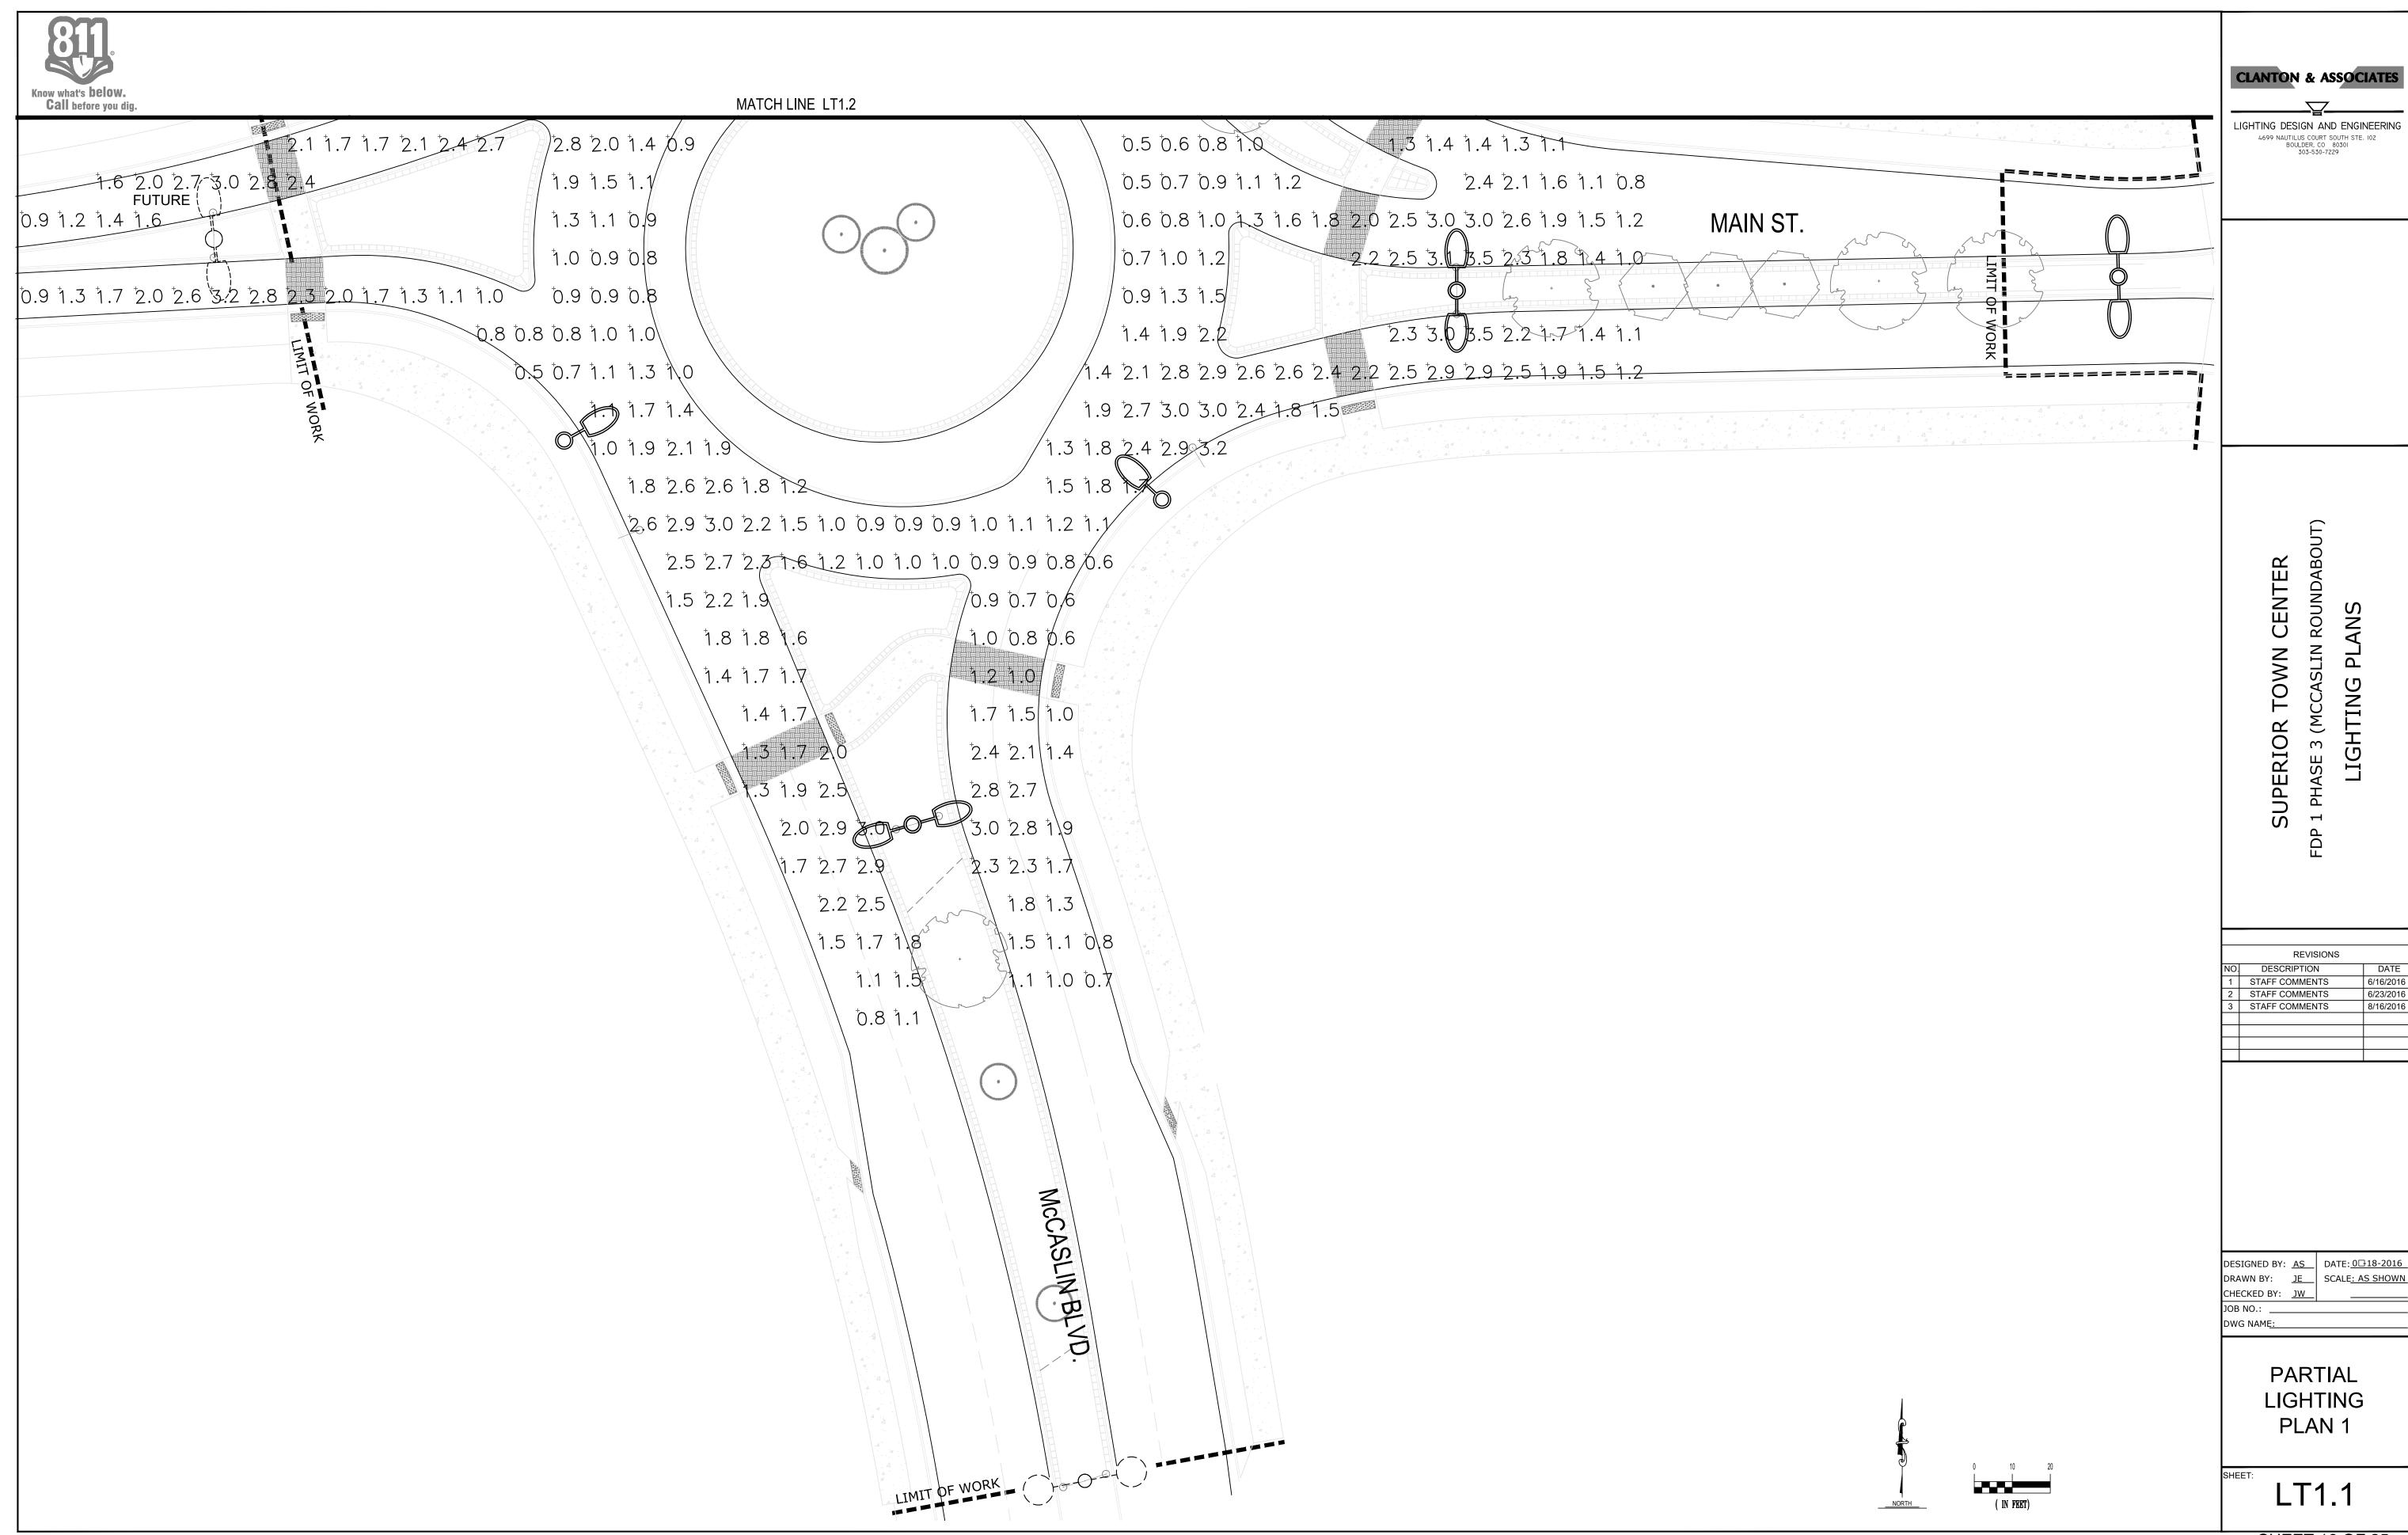





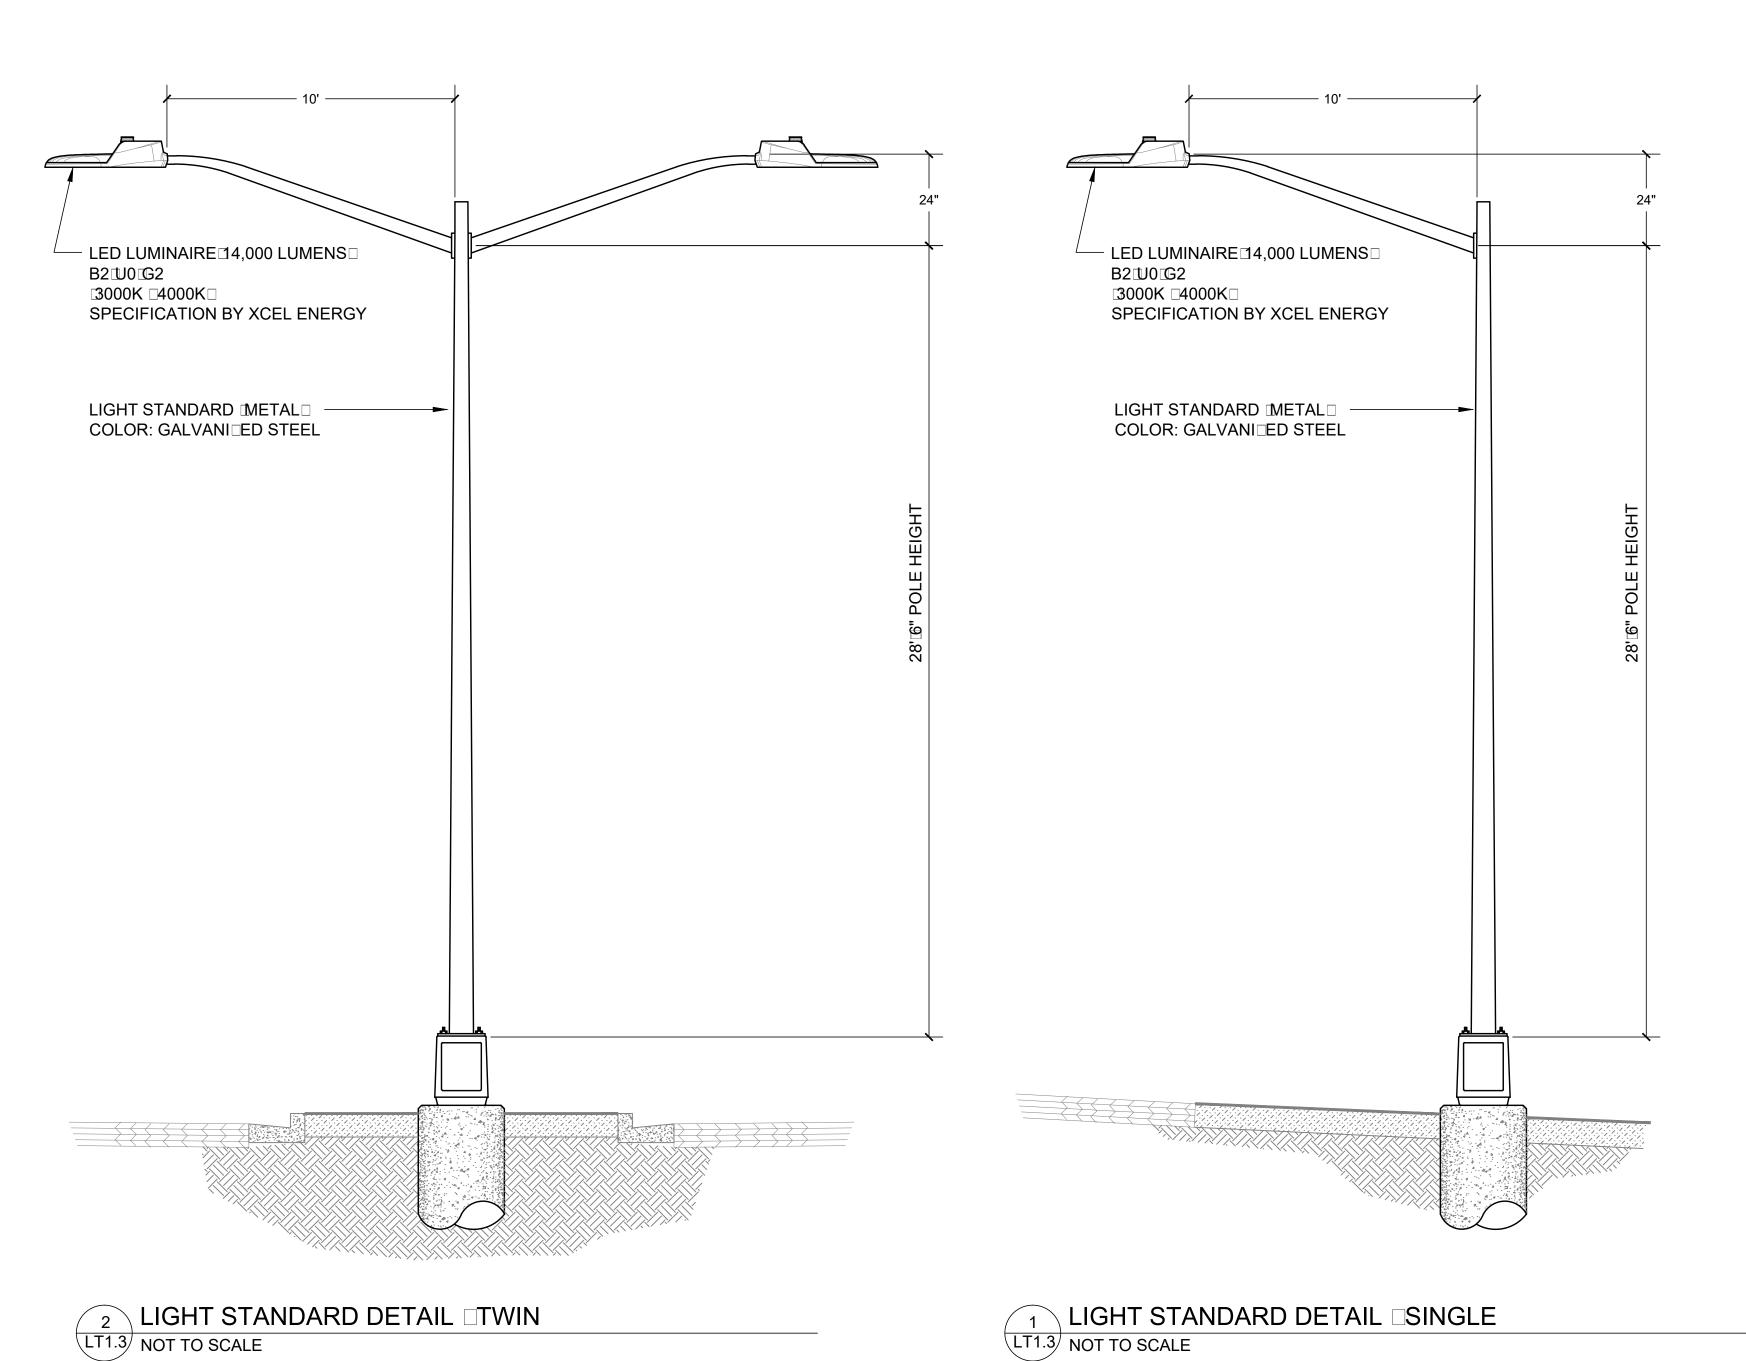

SUPERIOR TOWN CENTER
FDP 1 PHASE 3 (MCCASLIN ROUNDABOUT)
LIGHTING PLANS

REVISIONS

10. DESCRIPTION DATE

1 STAFF COMMENTS 6/16/201

2 STAFF COMMENTS 6/23/201

3 STAFF COMMENTS 8/16/201

DESIGNED BY: AS DATE: 0☐18-2016
DRAWN BY: JE SCALE: AS SHOWN
CHECKED BY: JW


JOB NO.:

LIGHTING DETAILS

LT1.3


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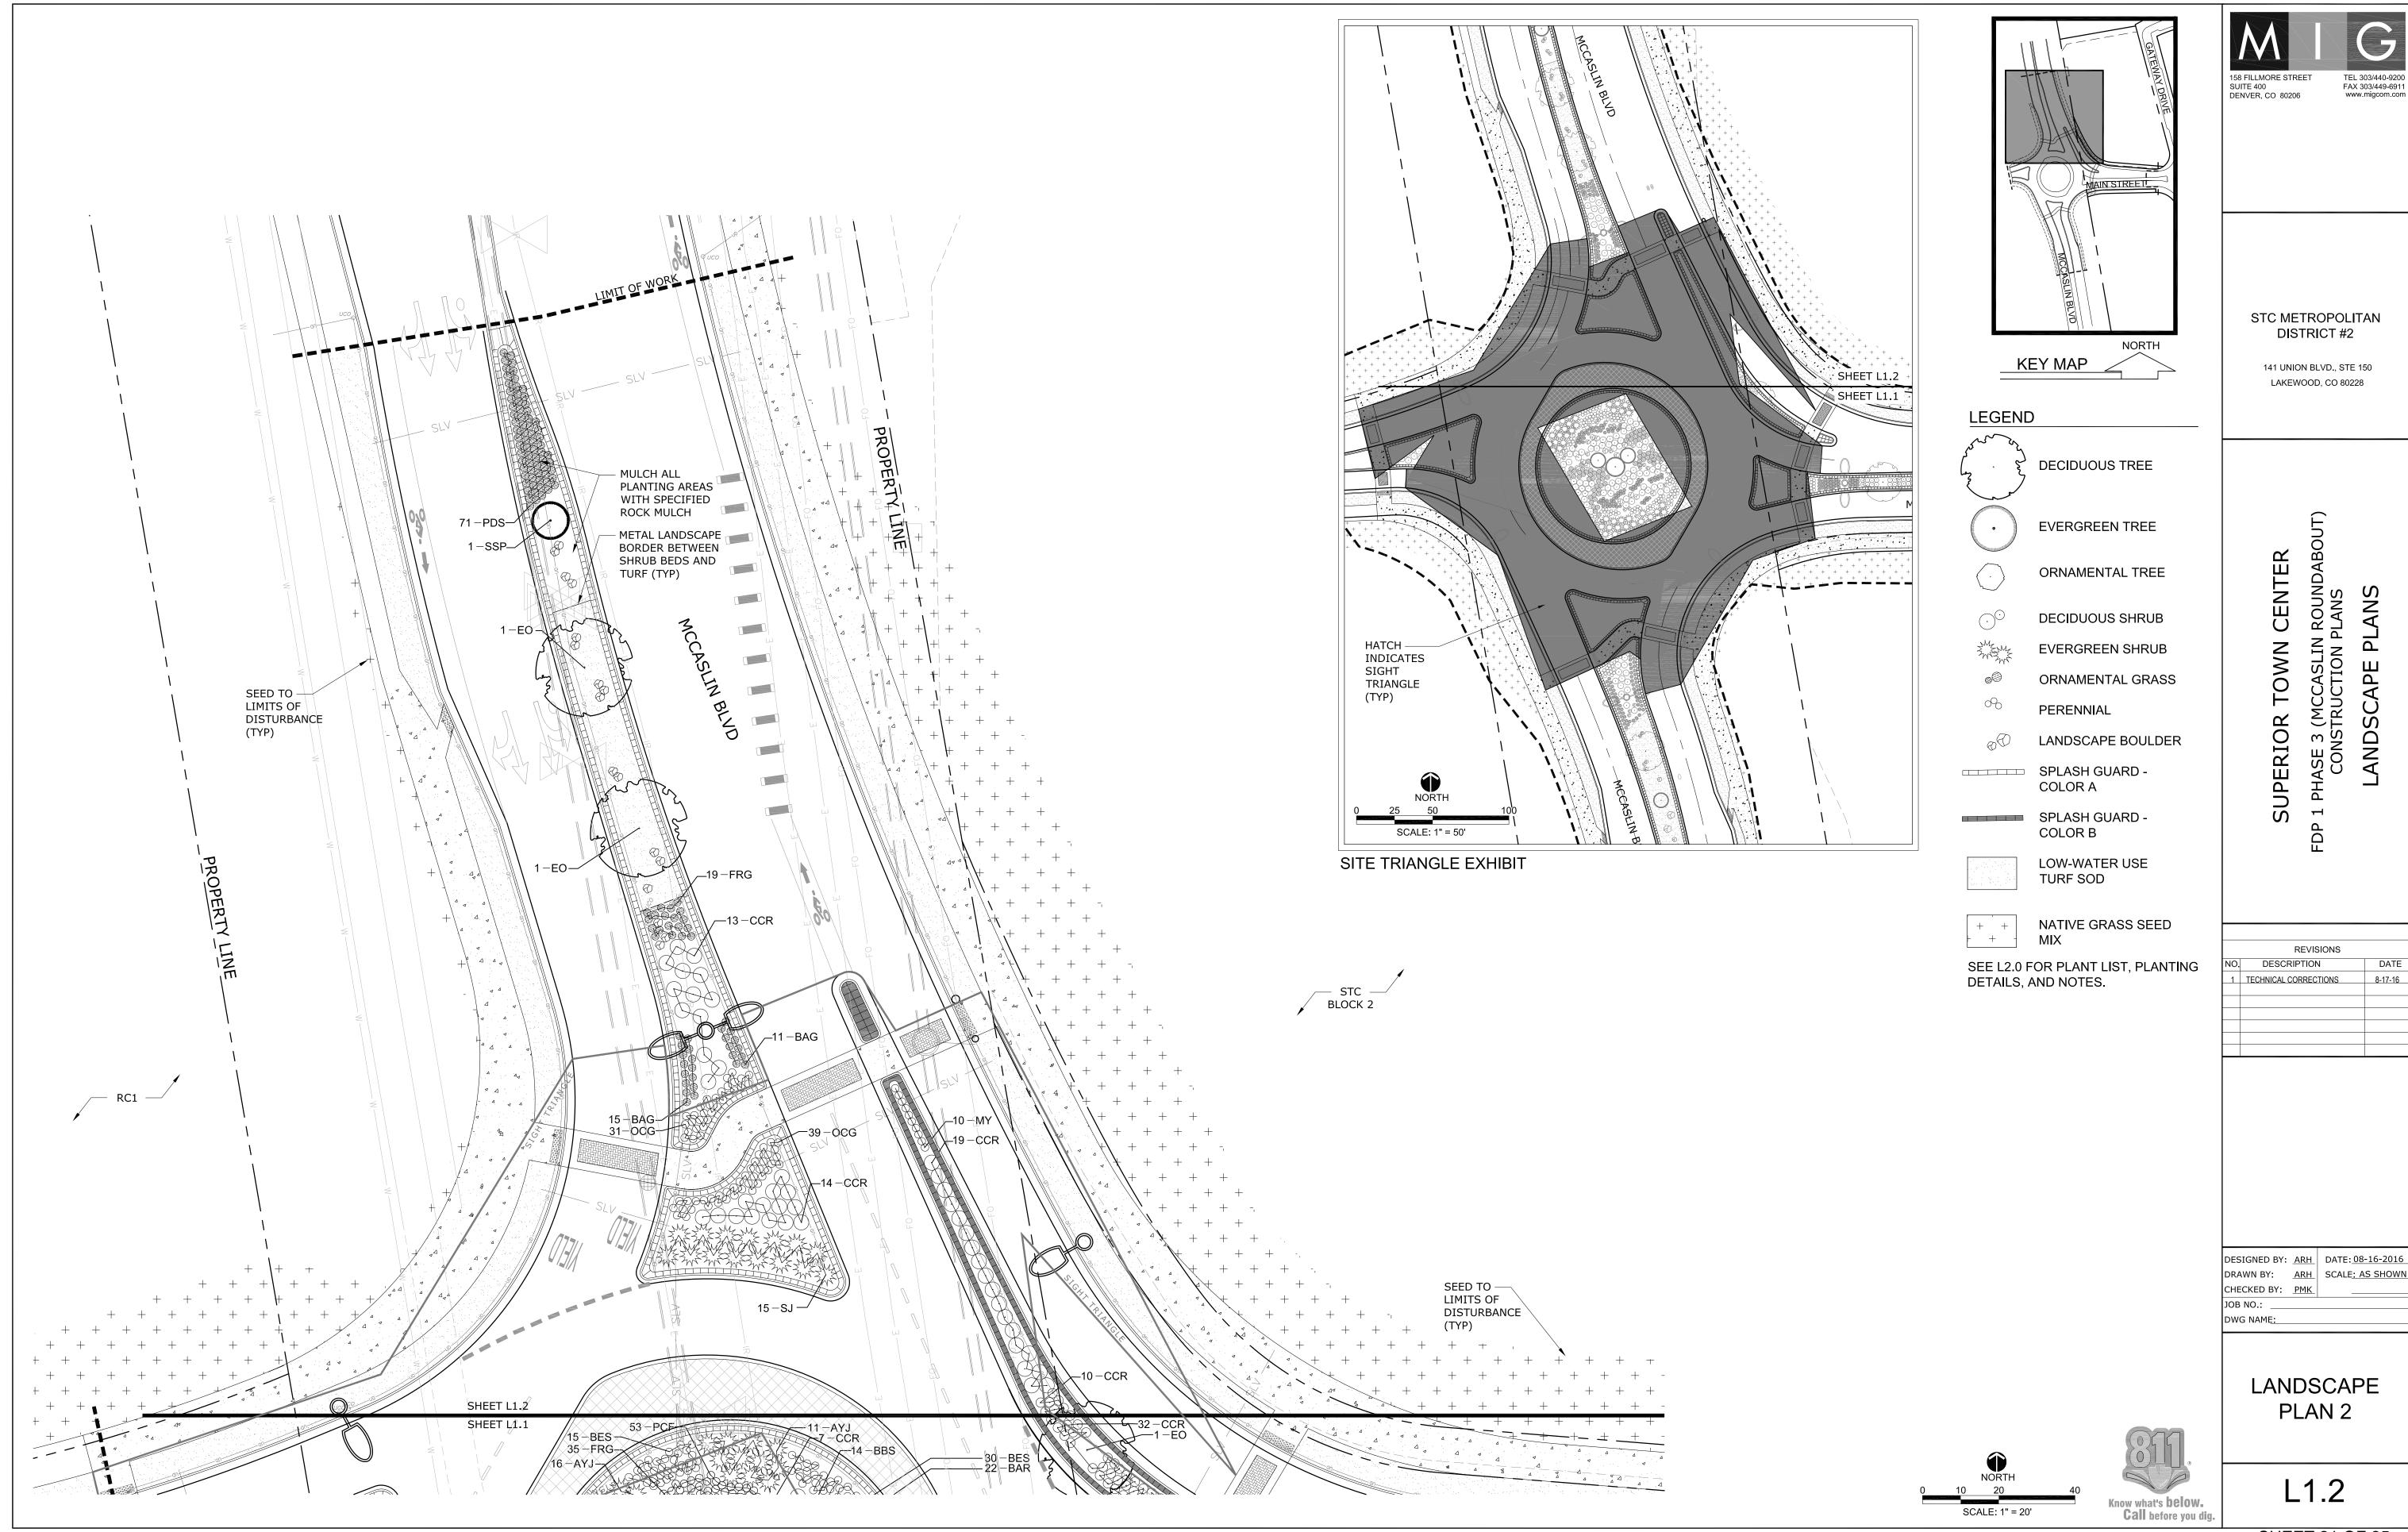
SHEET 18 OF 25




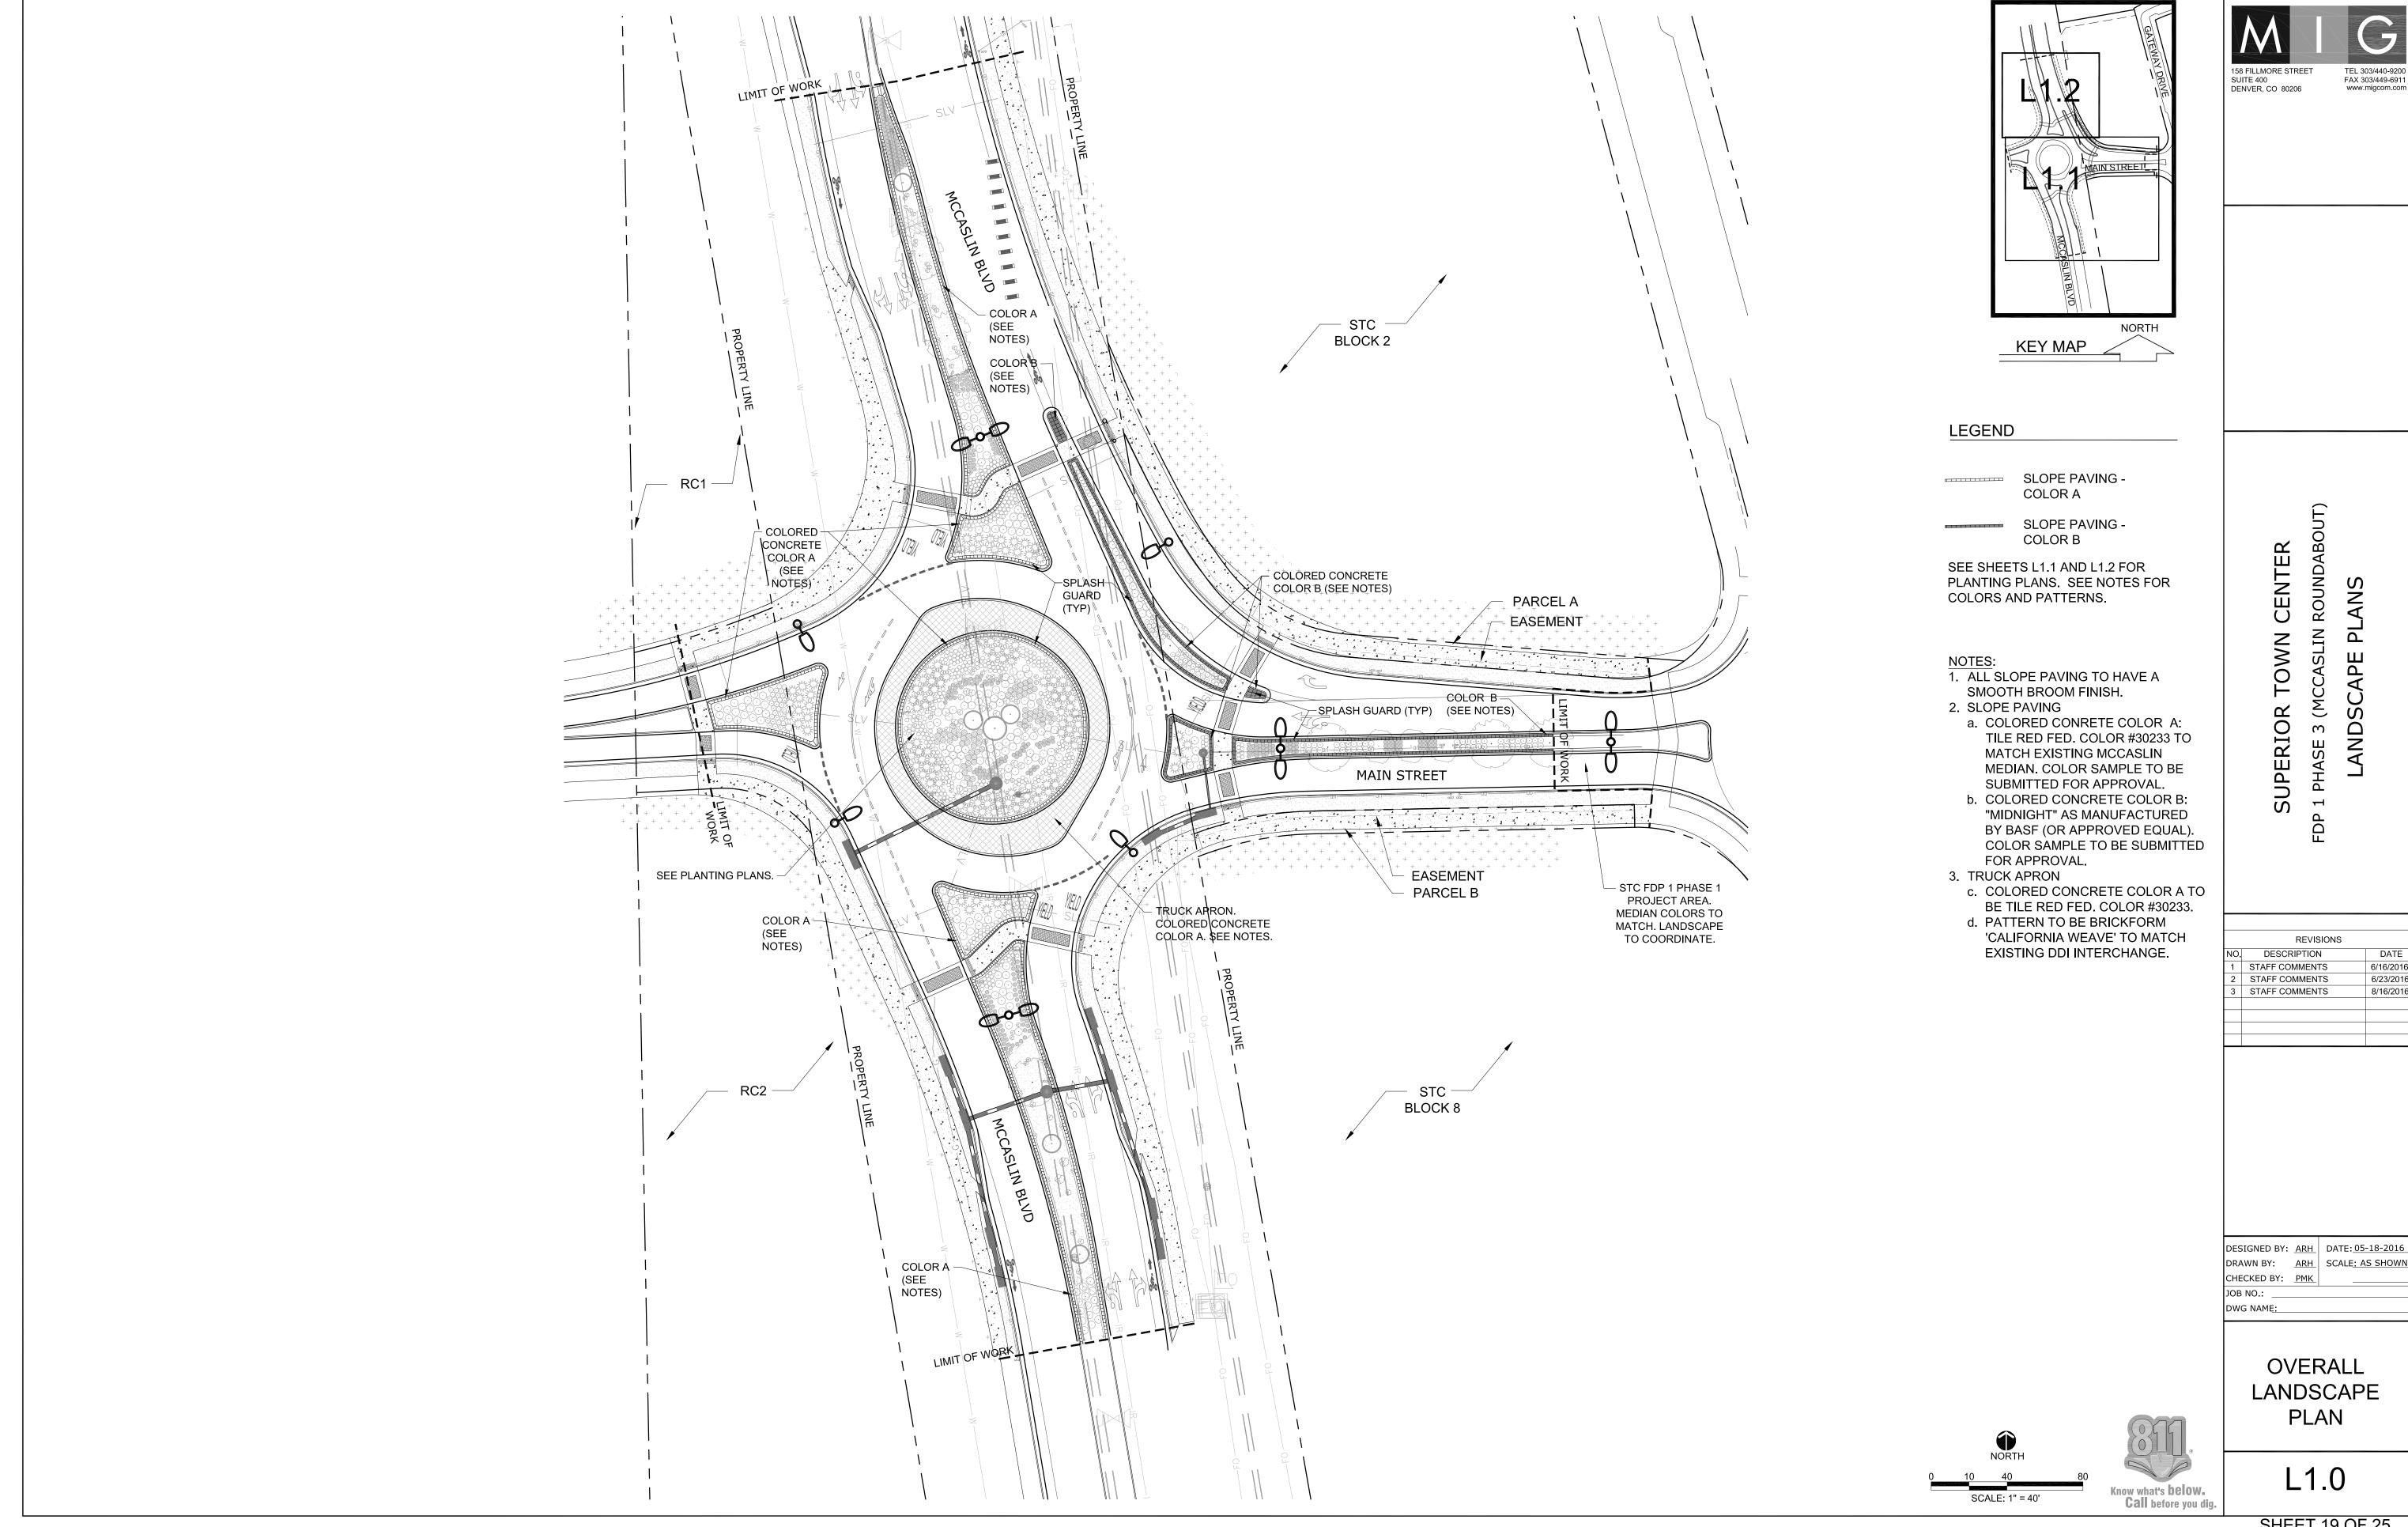



	REVISIONS	
NO.	DESCRIPTION	DATE
1	STAFF COMMENTS	6/16/20
2	STAFF COMMENTS	6/23/20
3	STAFF COMMENTS	8/16/20



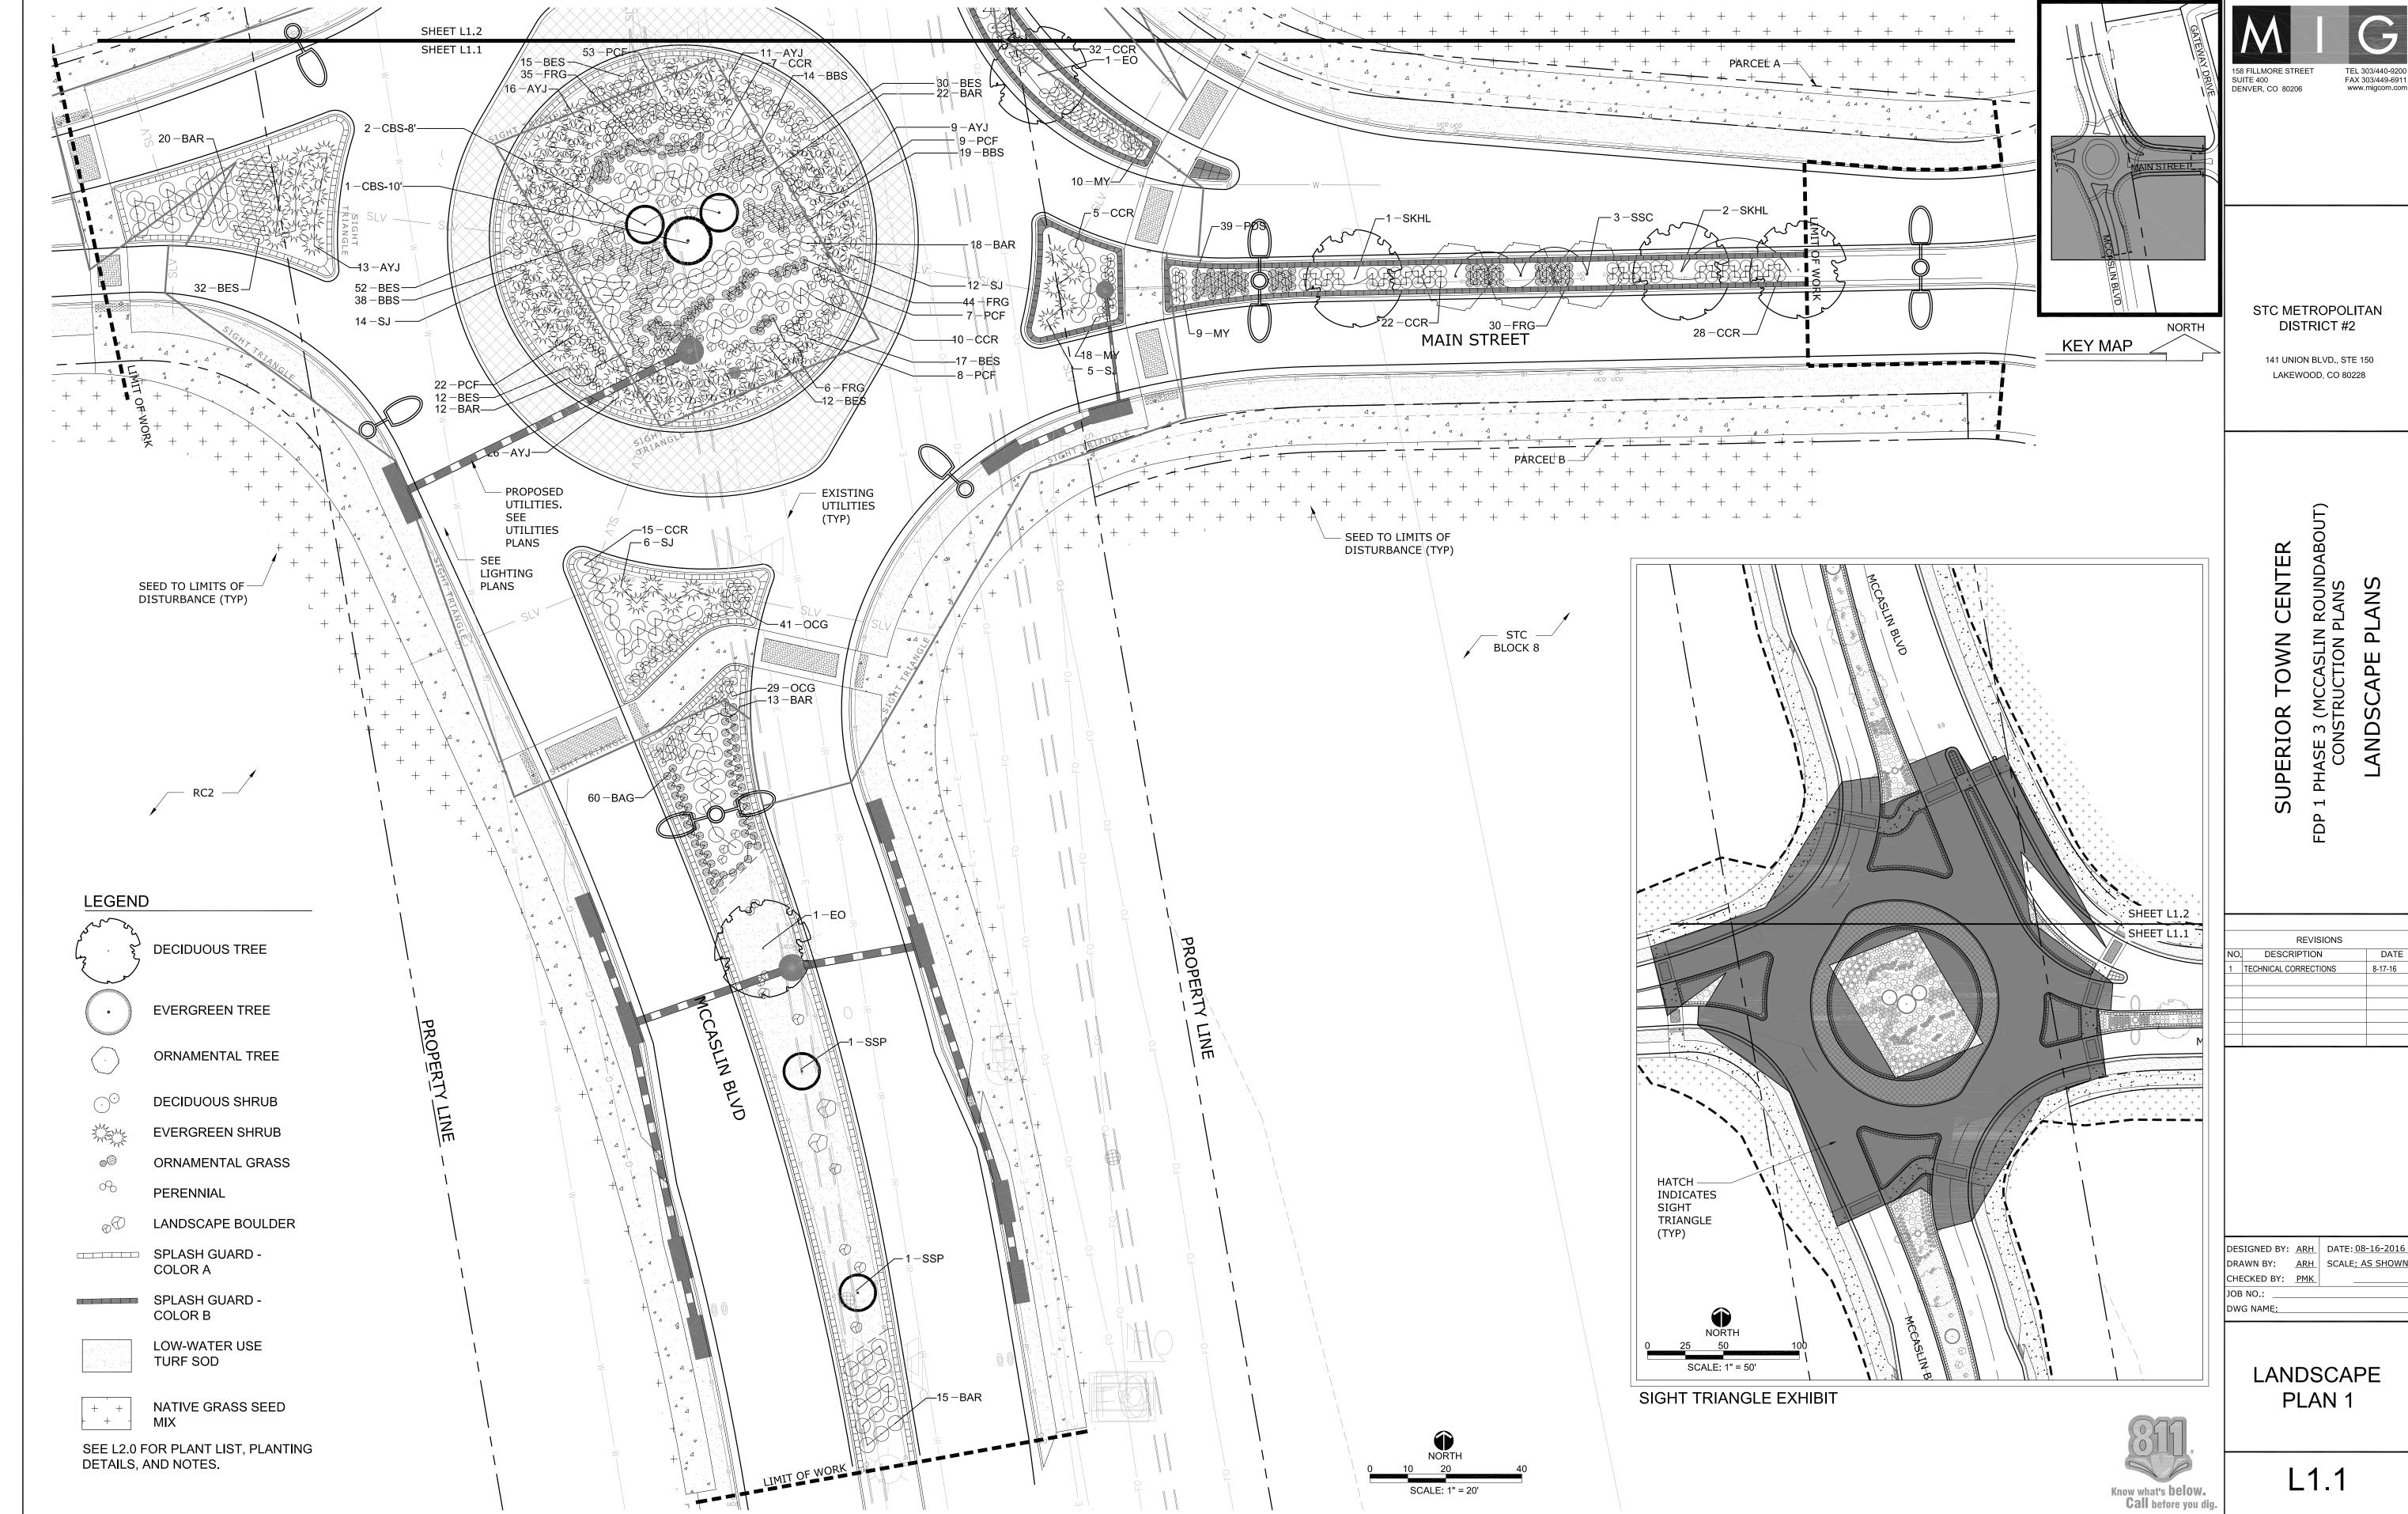

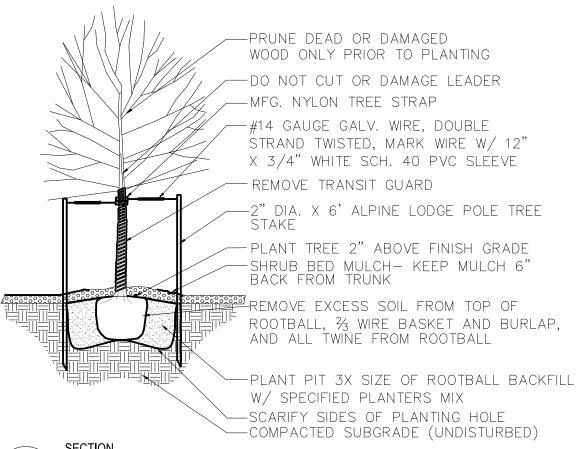


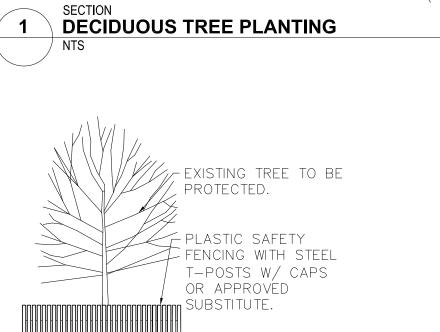

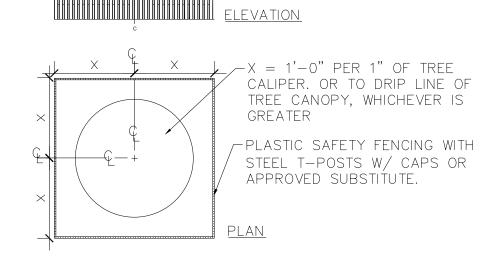

2 TREE PROTECTION DETAIL

/ NTS

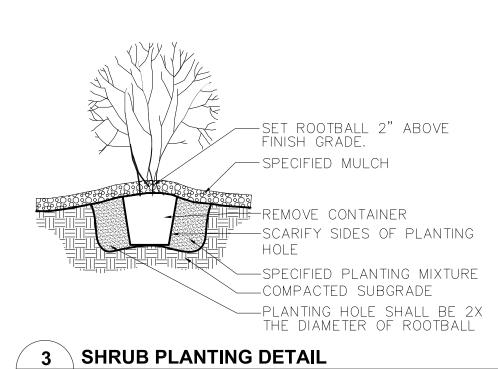

SPECIFIED MULCH STEEL EDGER PER SPECS. EDGING FLUSH WITH ADJOINING SURFACES HOLD SOD 1" BELOW TOP OF EDGING
SECTION STEEL EDGER NTS

Qty 4 3 1 2 ine 3	Spacing As Shown	Total = 7 Size 2.5" Cal. 2.5" Cal. Total = 3 2" Cal. Total = 6 10' 8' 8'	Height 40-60' 40-50' Height 20-25' Height 20-25' 20-25' 25-35'
3 3 1 2	As Shown As Shown As Shown As Shown	2.5" Cal. 2.5" Cal. Total = 3 2" Cal. Total = 6 10' 8'	40-50' Height 20-25' Height 20-25' 20-25'
3 3 1 2	As Shown As Shown As Shown As Shown	2.5" Cal. Total = 3 2" Cal. Total = 6 10' 8'	40-50' Height 20-25' Height 20-25' 20-25'
1 2	As Shown As Shown As Shown	Total = 3 2" Cal. Total = 6 10' 8'	Height 20-25' Height 20-25' 20-25'
1 2	As Shown As Shown	2" Cal. Total = 6 10' 8'	20-25' Height 20-25' 20-25'
1 2	As Shown As Shown	Total = 6 10' 8'	Height 20-25' 20-25'
2	As Shown	10' 8'	20-25' 20-25'
2	As Shown	8'	20-25
		1001	
ine 3	As Shown	8'	25-35'
and the same of th		Total = 255	Height
Qty	Spacing	Size	
Barberry 100	As Shown	5 Gal.	18-24'
ie 175	As Shown	5 Gal.	12-24"
		Total = 126	Height
Qty	Spacing	Size	
niper 72	As Shown	5 Gal.	12-18'
51	As Shown	5 Gal.	18-24'
		Total = 527	Height
Qty	Spacing	Size	
89	As Shown	5 Gal.	24-36"
71	As Shown	5 Gal.	6-8'
134	As Shown	5 Gal.	36-48"
110	As Shown	5 Gal.	24-30'
		Total = 378	Height
170	As Shown	1 Gal.	18-24"
48	As Shown	1 Gal.	24-30"
Trumpet 140	As Shown	1 Gal.	4-6"
99	As Shown	1 Gal.	24-36"
	Carte	As Shown Qty Spacing Thiper Qty Spacing Thiper Qty Spacing Thiper As Shown As Shown As Shown As Shown The shown	Total = 126

NOTES

- 1. TREES PLANTED WITHIN SIGHT TRIANGLES SHALL NOT BRANCH HORIZONTALLY BELOW A 6' HEIGHT. SHRUBS WITHIN SIGHT TRIANGLES SHALL NOT EXCEED 2'-0" IN HEIGHT.
- ALL SHRUB BEDS ARE TO BE MULCHED WITH SPECIFIED ROCK MULCH TO MATCH EXISTING MCCASLIN BLVD MEDIAN ROCK MULCH. MULCH IS TO BE PLACED OVER WEED CONTROL FABRIC.
- 3. ALL SHRUB BEDS SHALL BE SEPARATED FROM TURF GRASS AND NATIVE GRASS AREAS BY 3/16" X 4" X 16' STEEL EDGING.
- 4. LOCATION OF PLANT MATERIAL SHALL BE ADJUSTED TO PROVIDE THE REQUIRED MINIMUM CLEARANCE FROM THE FINAL LOCATION OF ALL BURIED UTILITY LINES
- MINIMUM CLEARANCE FROM THE FINAL LOCATION OF ALL BURIED UTILITY LINES.

 5. PLANTING DENSITY WILL BE ON A SCALE THAT IS COMPATIBLE WITH THE
- LANDSCAPE OF THE EXISTING MCCASLIN BLVD MEDIAN.
 6. ALL TREES IN TURF GRASS AREAS SHALL HAVE A 3' DIAMETER, 4" DEEP WOOD
- MULCH RING AROUND THE BASE OF THE TREE.
- MEDIAN SPLASH GUARD TO BE PER THE TOWN OF SUPERIOR STANDARDS.
 EXISTING MCCASLIN MEDIAN BOULDERS TO BE SALVAGED AND RE-USED AS "LANDSCAPE BOULDERS" IN THIS PLAN. NEW LANDSCAPE BOULDERS SHALL MATCH EXISTING.

158 FILLMORE STREET
SUITE 400
DENVER, CO 80206

TEL 303/440-9200
FAX 303/449-6911
www.migcom.com

SUPERIOR LOWN CENTER

PHASE 3 (MCCASLIN ROUNDABOUT)

ANDSCAPE PLANS

NO. 1	REVISIONS DESCRIPTION	
	DESCRIPTION	
1		DA ⁻
	STAFF COMMENTS	6/16/2
2	STAFF COMMENTS	6/23/2
3	STAFF COMMENTS	8/16/2

DESIGNED BY: ARH DATE: 05-18-2016
DRAWN BY: ARH SCALE: AS SHOWN
CHECKED BY: PMK

JOB NO.: _____

DWG NAME:

LANDSCAPE

NOTES
AND
DETAILS

L2.0

Know what's below.
Call before you dig.

SYMBOL	MANUFACTURER	MODEL NO.	DESCRIPTION	DETAIL NO.
6000	RAIN BIRD	RD-06-SAM-P30-NP W/ MATCHED PRECIP SERIES NOZZLE	POPUP SPRAY HEAD	6
•	RAIN BIRD	PESB W/ SB-DAC-1	ELECTRIC CONTROL VALVE W/ DECODER	7 \$ 8
▼	RAIN BIRD	44-NP	QUICK COUPLING VALVE	11
N/5	MATCO	201X	MANUAL DRAIN VALVE	12
(A)	TORO	SBAPS1U & SHHR	ELECTRIC CONTROLLER & HAND HELD REMOTE	1 \$ 2
♠	TORO	TMRFS	RAIN/FREEZE SHUT-OFF DEVICE	3
•	RAIN BIRD	PESB-PRS-D	MASTER CONTROL VALVE	5
FS	TORO	TFS-200	FLOW SENSOR	4
M		LINE SIZE - $2\frac{1}{2}$ " AND SMALLER	GATE VALVE	10
		CLASS 200 BE - 21/2" \$ SMALLER	PVC MAINLINE	16
		CLASS 200 BE	PVC LATERAL	16
		CLASS 160	PVC SLEEVING	17
	TORO	BLUE STRIPE	POLY DRIP TUBING -3/4" MIN. WIDTH	13 - 15
\oplus	RAIN BIRD	XCZ-100-PRF W/ SB-DAC-1	DRIP VALVE ASSEMBLY W/ DECODER	13 \$ 8
▶			DRIP LINE BLOW-OUT STUB	15
N/5	RAIN BIRD	XERI-BUG	DRIP EMITTERS	14
© ^B	TORO	SB-BLA	SURGE PROTECTION	9
N/5	PAIGE	P7350D	2-WIRE DECODER CABLE	7, 8, 9 \$ 13
			EXISTING MAINLINE	

IRRIGATION CONSTRUCTION NOTES

- 1. DRAWINGS AND BASE INFORMATION ALL BASE AND PLANTING INFORMATION HAVE BEEN PROVIDED BY MIG. THE CONTRACTOR IS RESPONSIBLE TO NOTIFY HYDROSYSTEMS*KDI OF ANY DISCREPANCIES BETWEEN THE UTILITY OR PLANTING PLANS AND THE IRRIGATION PLAN. IF CONTRACTOR FAILS TO NOTIFY HYDROSYSTEMS*KDI AND MAKES CHANGES TO THE IRRIGATION SYSTEM DESIGN, HE ASSUMES ALL COSTS AND LIABILITIES ASSOCIATED WITH THOSE FIELD CHANGES. REFER TO SPECIFICATIONS FOR ADDITIONAL PROJECT REQUIREMENTS.
- 2. SYSTEM PRESSURE HYDROSYSTEMS*KDI HAS CONTACTED THE LOCAL WATER DISTRICT THAT SERVES THIS SITE AND THEY HAVE BEEN TOLD THAT THE STATIC MATER PRESSURE IN THIS AREA SHOULD BE 70 PSI. THE CONTRACTOR IS RESPONSIBLE TO FIELD VERIFY PRESSURE PRIOR TO COMMENCING ANY CONSTRUCTION AND NOTIFY HYDROSYSTEMS*KDI OF ANY VARIANCE FROM THE STATED PRESSURE IMMEDIATELY. WRITTEN DOCUMENTATION OF PRESSURE TEST AND RESULTS SHALL BE PROVIDED TO HYDROSYSTEMS*KDI AT CONSTRUCTION ONSET. IF CONTRACTOR FAILS TO FIELD VERIFY PRESSURE AND/OR NOTIFY HYDROSYSTEMS*KDI OR ANY VARIATIONS FROM THIS PRESSURE, THEN HE ASSUMES ALL CONSTRUCTION AND ENGINEERING COSTS ASSOCIATED WITH SYSTEM MODIFICATIONS REQUIRED TO ACCOMMODATE ACTUAL SITE PRESSURE. THIS SYSTEM HAS BEEN DESIGNED FOR A REQUIRED STATIC PRESSURE OF 70 PSI MINIMUM.
- 3. IRRIGATION SYSTEM OPERATION INTENT THIS IRRIGATION SYSTEM HAS BEEN DESIGNED TO IRRIGATE THE ESTABLISHED LANDSCAPE WITHIN A SIX NIGHT PER WEEK, SIX HOUR PER NIGHT WATERING WINDOW. ESTABLISHMENT WATERING WILL REQUIRE UP TO TWICE AS MUCH IRRIGATION FOR A FOUR TO SIX WEEK PERIOD. THE DESIGN IS BASED ON THE FOLLOWING PROJECTED WEEKLY APPLICATION RATES AFTER ESTABLISHMENT. THESE FIGURES ARE BASED ON A 30-YEAR AVERAGE MEATHER DATA AND MILL NEED TO BE ADJUSTED DUE TO SEASONAL CHANGES AND MEATHER CONDITIONS ABOVE AND BELOW THE AVERAGE VALUES UTILIZED. BLUEGRASS TURF 1.75" PER WEEK PEAK SEASON

ORNAMENTAL PLANTINGS 1.00" PER WEEK PEAK SEASON

NATIVE SEED MIXES 1.00" PER WEEK PEAK SEASON (TWO SEASONS)


NOTE: IT IS THE INTENT OF THIS DESIGN THAT NATIVE AREAS WOULD ONLY BE IRRIGATED FOR ESTABLISHMENT.

- 4. EQUIPMENT INSTALLATION IT IS THE INTENT OF THIS DESIGN THAT ALL IRRIGATION EQUIPMENT BE INSTALLED WITHIN PROPERTY LIMITS AND WITHIN LANDSCAPED AREAS. ANY EQUIPMENT SHOWN OUTSIDE OF THESE LIMITS IS SHOWN IN THAT LOCATION FOR GRAPHICAL CLARITY ONLY. ALL VALVE BOXES SHALL BE INSTALLED A MINIMUM OF 2'-O" FROM EDGE OF ANY PAVED SURFACES. ALL VALVE BOXES SHALL BE PLACED A MINIMUM OF 3'-O" FROM THE CENTERLINE OF ANY DRAINAGE SMALE.
- 5. SLEEVING ALL SLEEVING UNDER PAVED SURFACES SHOWN ON PLANS IS BY CONTRACTOR UNLESS OTHERWISE NOTED. SLEEVING SHALL BE INSTALLED IN THE SIZES AND QUANTITIES SHOWN ON PLANS OR BASED ON THE SCHEDULE BELOW. WHERE SLEEVES ARE SHOWN, BUT NOT LABELED, FOLLOW THE SCHEDULE BELOW. ALL MAINLINE, CONTROL WIRES AND DRIP LINES UNDER PAVED SURFACES ARE TO BE INSTALLED IN SLEEVING. ALL MAINLINE SLEEVE LOCATIONS TO INCLUDE A SEPARATE WIRE SLEEVE.

SLEEVED PIPE SIZE/WIRE QUANTITY REQUIRED SLEEVE SIZE & (QUANTITY)

 $\frac{3}{4}$ " - $\frac{1}{4}$ " PIPING 2" PVC (1) 1½" - 2" PIPING 4" PVC (1) 21/2" - 3" PIPING 6" PVC (1) 1-25 CONTROL WIRES 2" PVC (1)

- 6. MANUAL DRAIN VALVES CONTRACTOR TO INSTALL ONE MANUAL DRAIN VALVE ON PRESSURE SUPPLY LINE DIRECTLY DOWNSTREAM OF BACKFLOW PREVENTER AND AT ALL LOW POINTS AND DEAD ENDS OF PRESSURE SUPPLY PIPING TO INSURE COMPLETE DRAINAGE OF SYSTEM. CONTRACTOR SHALL BE RESPONSIBLE FOR DETERMINING THESE LOCATIONS IN-FIELD AND INSTALLATION LOCATIONS SHALL BE NOTED ON AS-BUILTS.
- 7. POP-UP SPRAY NOZZLES CONTRACTOR TO INSTALL PLASTIC NOZZLES ON ALL POP-UP SPRAY HEADS. INSTALL 15 SERIES NOZZLES ON ALL HEADS SPACED AT 12' TO 14'. INSTALL 12 SERIES NOZZLES ON ALL HEADS SPACED 10' TO 11'. INSTALL 10 SERIES NOZZLES ON ALL HEADS SPACED AT 8' TO 9'. INSTALL 8 SERIES NOZZLES ON ALL HEADS SPACED AT 6' TO 7'. INSTALL 5' NOZZLES ON ALL HEADS SPACED AT 5'. INSTALL SIDE STRIP NOZZLES ON ALL HEADS WITH AN "S" DESIGNATION AND RIGHT AND LEFT CORNER STRIP NOZZLES ON ALL HEADS WITH AN "L" OR "R" DESIGNATION. VARIABLE ARC NOZZLES SHOULD BE UTILIZED ADJACENT TO CURVILINEAR SHRUB BEDS OR FOR ANY ANGLES THAT ARE NOT A STANDARD NOZZLE ANGLE. WHERE INDICATED, INSTALL LOW FLOW SQ SERIES SQUARE NOZZLES AT SPACING SHOWN.
- 8. DRIP IRRIGATION REFER TO IRRIGATION DETAIL SHEET FOR DRIP EMITTER QUANTITIES AND PLACEMENT.
- 9. 2-WIRE SYSTEM NOTES CONTRACTOR SHALL INSTALL ALL TWO-WIRE COMPONENTS PER MANUFACTURES RECOMMENDATIONS AND STANDARDS.
- 9.1. CONTRACTOR SHALL USE ONLY MANUFACTURED 2-WIRE DECODER CABLE (SEE SCHEDULE FOR SPECIFIC 2-WIRE
- 9.2. ONLY USE SINGLE STATION DECODERS (SEE SCHEDULE FOR SPECIFIC MODEL)
- 9.3. LOOP 5' OF 2-WIRE DECODER CABLE INTO ALL VALVE BOXES (WITH DECODERS AND SPLICES) FOR MAINTENANCE. USE ONLY 3M DBR-6 WATERPROOF CONNECTORS ON ALL WIRE SPLICES AND ALL WIRE SPLICES ARE TO BE MADE
- WITHIN A VALVE BOX WITH CONTROL VALVES OR A SEPARATE 10" ROUND VALVE BOX FOR WIRE SPLICES. 9.5. INSTALL SURGE PROTECTOR RODS OR PLATES 8 LF. FROM VALVES, DECODERS, AND COMMUNICATION WIRE.
- 9.6. GROUND ALL DECODERS AND DECODER WIRE A MINIMUM OF EVERY 500' AND AT ALL ENDS OF 2-WIRE DECODER
- 9.7. LOOP EXTRA 10' OF 2-WIRE DECODER CABLE INTO A VALVE BOX AT PHASING LINES FOR FUTURE CONNECTION (IF INDICATED ON PLANS).
- 10. ADJUSTMENT CONTRACTOR SHALL FINE TUNE/ADJUST THE IRRIGATION SYSTEM TO REDUCE/AVOID OVERSPRAY ONTO HARD SURFACES BY ADJUSTING NOZZLE DIRECTION AND NOZZLE RADIUS.
- 11. EXISTING IRRIGATION DAMAGE CONTRACTOR SHALL REPAIR OF REPLACE ANY EXISTING IRRIGATION SYSTEMS DAMAGED DURING NEW INSTALLATION. REPAIR OR REPLACEMENT SHALL BE DETERMINED BY OWNER OR OWNER'S REPRESENTATIVE AND PAID FOR BY THE LANDSCAPE CONTRACTOR.
- 12. EXISTING IRRIGATION COORDINATION EXISTING IRRIGATION SYSTEM SHALL NOT BE TURNED OFF FOR MORE THAN 24 HOURS MAXIMUM. CONTRACTOR SHALL COORDINATE TURN OFF OF SYSTEM WITH OWNER OR MAINTENANCE STAFF 12 HOURS PRIOR TO ANY NEW CONSTRUCTION.
- 13. UNLABELED PIPING ALL UNLABELED LATERAL PIPING SHALL BE 1" MINIMUM UNLESS OTHERWISE NOTED.

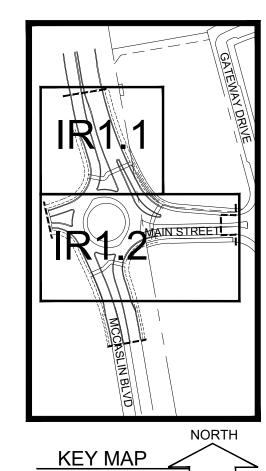

STC METROPOLITAN DISTRICT #2

> 141 UNION BLVD., STE 150 LAKEWOOD, CO 80228

ROUND . Ш ICCASLIN NMO. 0 0 \sim ERI IASE \propto UP

	REVISIONS	
NO.	DESCRIPTION	DAT
1	STAFF COMMENTS	6/16/20
2	STAFF COMMENTS	6/23/20
3	STAFF COMMENTS	8/16/20

DESIGNED BY: <u>KJD</u> DATE: <u>06-23-2016</u> DRAWN BY: <u>KJD</u> SCALE<u>: AS SHOWN</u> CHECKED BY: JSB

DWG NAME:

IRRIGATION

NOTES &


SCHEDULE

Know what's below. Call before you dig. CALL 3 BUSINESS DAYS IN ADVANCE BEFORE YOU DIG. GRADE, OR EXCAVATE FOR THE MARKING OF

IR1.0

SHEET 23 OF 25

REFER TO SHEET IR1.1-IR1.2 IRRIGATION PLAN

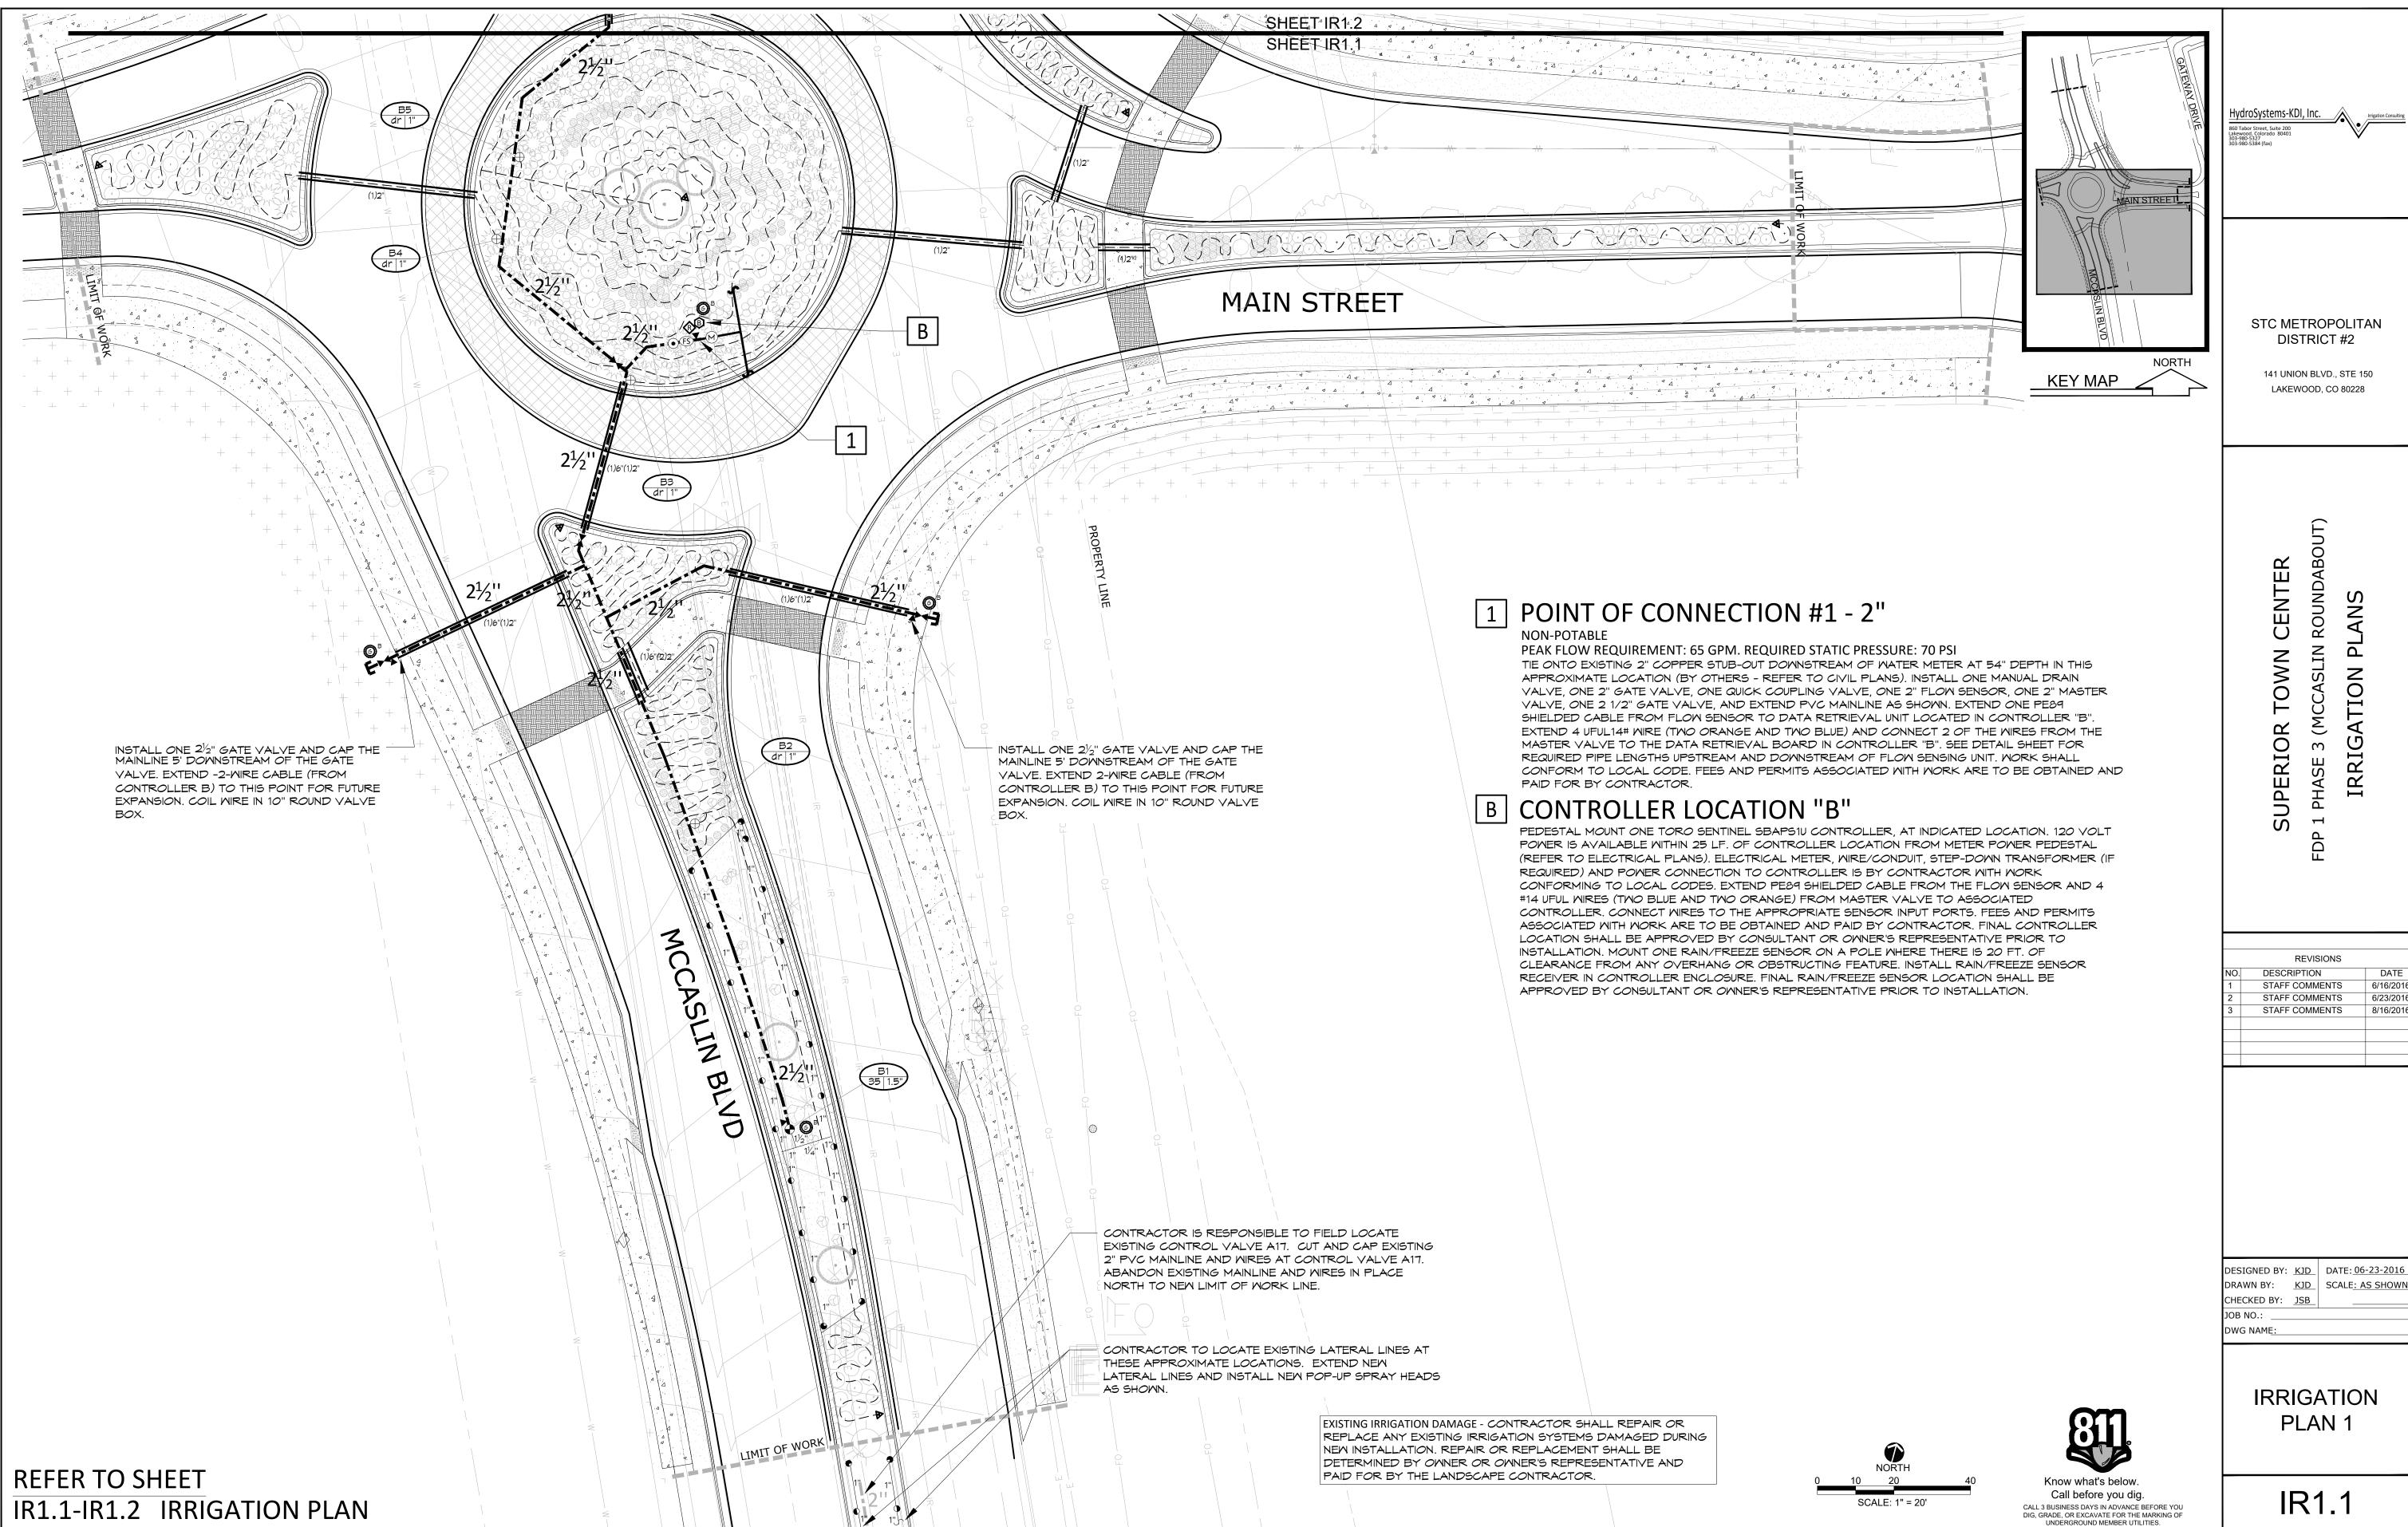

IR1.1 SHEET 24 OF 25

(MCCASLIN


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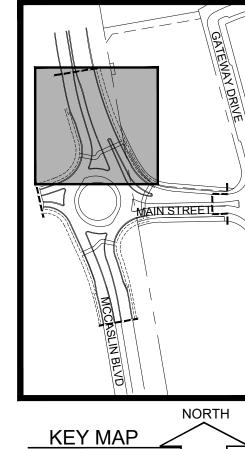
REVISIONS

6/16/2016

6/23/2016

IRRIG/



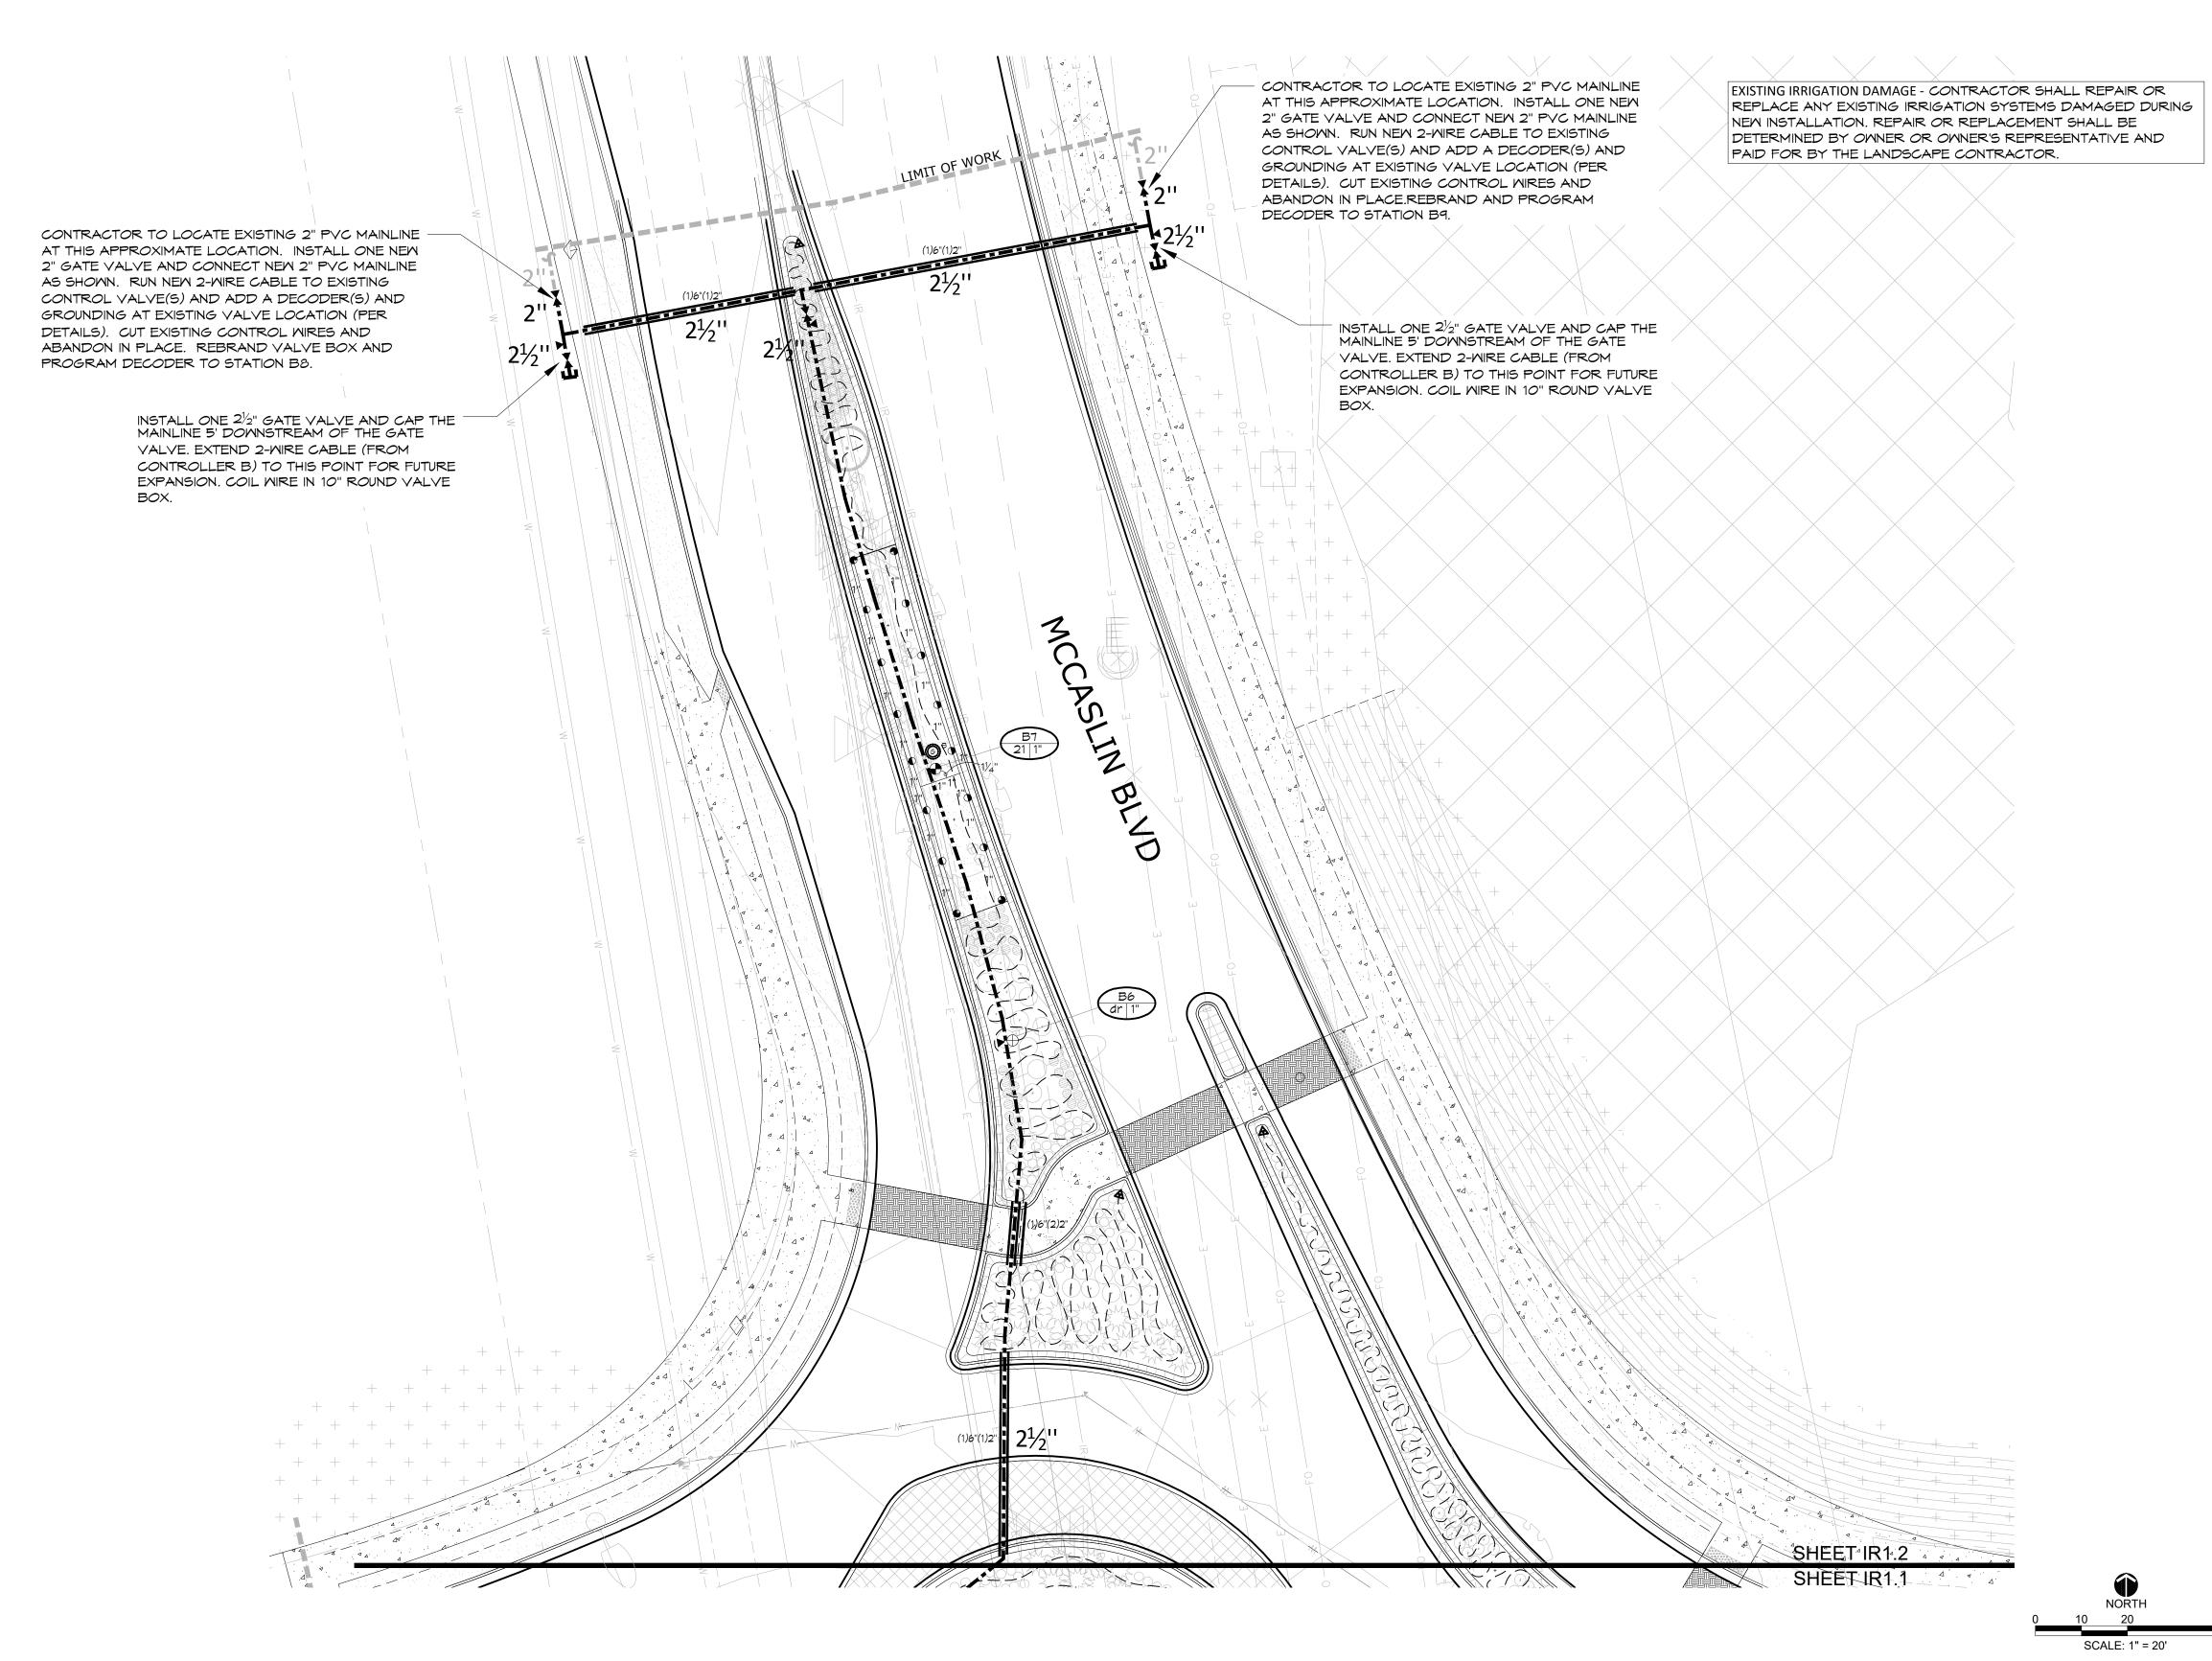

STC METROPOLITAN DISTRICT #2

> 141 UNION BLVD., STE 150 LAKEWOOD, CO 80228

CENTER ROUND, TOWN (MCCASLIN IRRIGATION SUPERIOR \sim PHASE

	REVISIONS	
NO.	DESCRIPTION	DATE
1	STAFF COMMENTS	6/16/201
2	STAFF COMMENTS	6/23/201
3	STAFF COMMENTS	8/16/201

DESIGNED BY: <u>KJD</u> DATE: <u>06-23-2016</u> DRAWN BY: <u>KJD</u> SCALE<u>: AS SHOWN</u> CHECKED BY: JSB

DWG NAME:

Know what's below.

Call before you dig.

CALL 3 BUSINESS DAYS IN ADVANCE BEFORE YOU DIG, GRADE, OR EXCAVATE FOR THE MARKING OF UNDERGROUND MEMBER UTILITIES.

IRRIGATION PLAN 2

IR1.2

REFER TO SHEET IR1.1-IR1.2 IRRIGATION PLAN